

Omni Waste of Osceola County, LLC 1501 Omni Way St. Cloud, Florida 34773

RESPONSE TO FIRST REQUEST FOR ADDITIONAL INFORMATION

RENEWAL PERMIT APPLICATION TO OPERATE PHASES 1 THROUGH 4 OF THE J.E.D. SOLID WASTE MANAGEMENT FACILITY

Prepared by:

Geosyntec D

consultants 13101 Telecom Drive, Suite 120 Temple Terrace, Florida 33637

Project Number FL1962

FEB 1 0 2012

DEP Central Dist.

February 2012

ATTACHMENT 3 Revised Sheets of Lateral Expansion Permit Drawings


J.E.D. SOLID WASTE MANAGEMENT FACILITY

ST.CLOUD, FLORIDA

PHASES 1 THROUGH 4 RENEWAL PERMIT DRAWINGS


NOVEMBER 2011

(REVISED, JANUARY 2012)

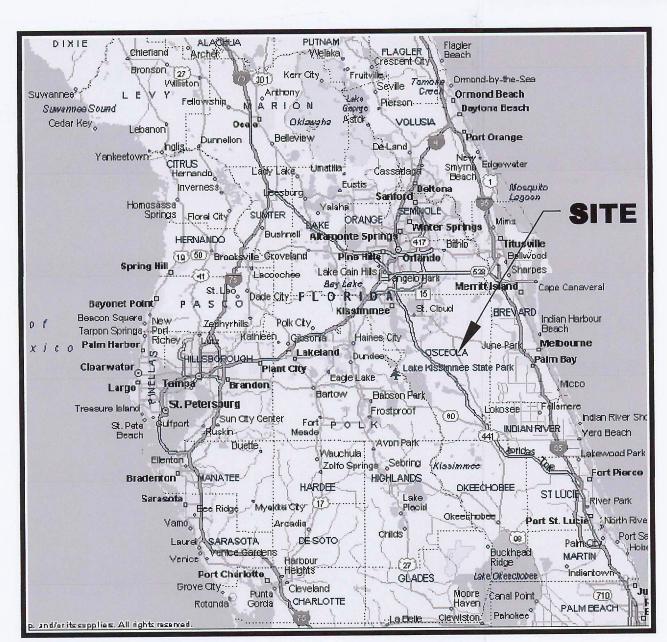


LOCATION MAP

SCALE: 1" = 32 MILES

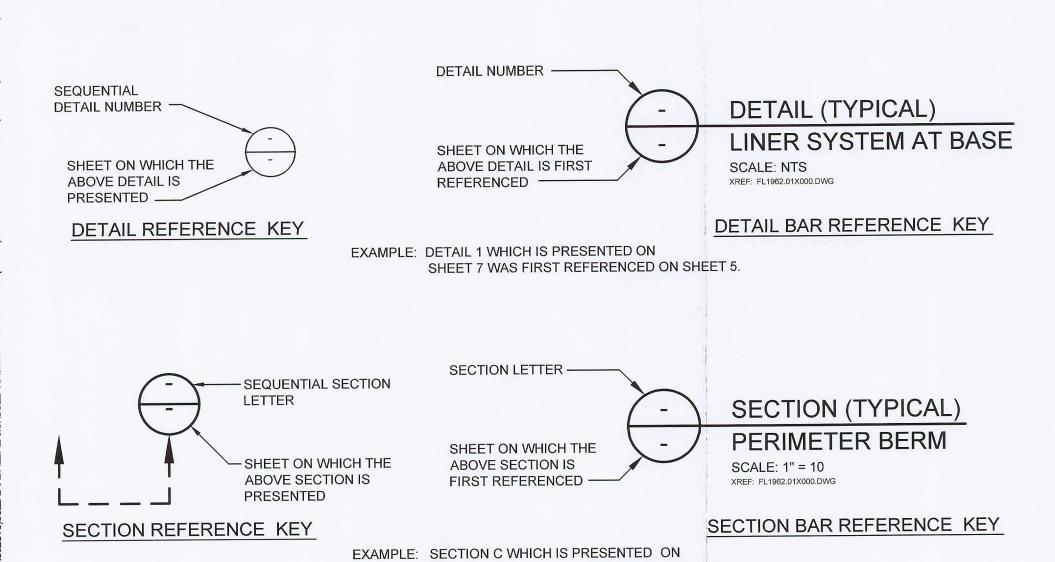


SHEET 5 WAS FIRST REFERENCED ON SHEET 3.

LIST OF DRAWINGS			
SHEET NUMBER	SHEET TITLE	REVISION	
1	TITLE SHEET	1	
2	EXISTING SITE CONDITIONS AND AERIAL PHOTOGRAPH	0	
3	TOPOGRAPHIC MAP OF THE SITE	0	
4	SITE CHARACTERIZATION PLAN I	0	
5	SITE CHARACTERIZATION PLAN II	0	
6	SITE DEVELOPMENT PLAN		
7	BASE GRADING PLAN - PHASE 3	0	
8	BASE GRADING PLAN - PHASE 4	0	
9	LEACHATE COLLECTION SYSTEM LAYOUT PLAN I	0	
10	LEACHATE COLLECTION SYSTEM LAYOUT PLAN II	1	
11	LANDFILL CROSS SECTIONS I	0	
12	LANDFILL CROSS SECTIONS II	0	
13	LANDFILL CROSS SECTIONS III	0	
14	PERIMETER BERM TYPICAL SECTIONS	0	
15	LINER SYSTEM DETAILS I - CELLS 8 THROUGH 13	0	
16	LINER SYSTEM DETAILS II - CELLS 8 THROUGH 13	0	
17	LEACHATE SUMP PLAN - CELLS 8 THROUGH 13	0	
18	SECONDARY SUMP CROSS SECTIONS - CELLS 8 THROUGH 13	0	
19	PRIMARY SUMP CROSS SECTIONS - CELLS 8 THROUGH 13	0	
20	LEACHATE SUMP CROSS SECTIONS - CELLS 8 THROUGH 13	0	
21	LEACHATE COLLECTION SYSTEM DETAILS - CELLS 8 THROUGH 13	0	
22	LEACHATE STORAGE FACILITY PLAN	1	
23	LEACHATE STORAGE FACILITY CROSS SECTIONS	1	
24	LEACHATE MANAGEMENT SYSTEM SCHEMATIC DIAGRAM	0	
25	GROUNDWATER MONITORING NETWORK	0	
26	PHASE 3 CONSTRUCTION SEQUENCING	1	
27	PHASE 4 CONSTRUCTION SIEQUENCING	1	
28	WASTE FILL SEQUENCING PLAN I	0	
29	WASTE FILL SEQUENCING PLAN II	0	
30	GAS MANAGEMENT SYSTEM PLAN I	0	
31	GAS MANAGEMENT SYSTEM PLAN II	0	
32	CONCEPTUAL LAYOUT OF HORIZONTAL GAS COLLECTORS	0	
33	GAS MANAGEMENT DETAILS I	0	
34	GAS MANAGEMENT DETAILS II	0	
35	GAS MANAGEMENT DETAILS III	0	
36	GAS MANAGEMENT DETAILS IV	0	
37	LANDFILL GAS PIPELINE DETAILS	0	
38	SCALE AND ADMINISTRATIVE AREA LAYOUT	0	
39	FINAL COVER SYSTEM GRADING PLAN I	0	
40	FINAL COVER SYSTEM GRADING PLAN II	0	
41	FINAL COVER SYSTEM DETAILS	0	
42	STORM WATER MANAGEMENT PLAN	0	
43	STORM WATER MANAGEMENT DETAILS I	0	
44	STORM WATER MANAGEMENT DETAILS II	0	
45	STORM WATER DRAINAGE STRUCTURE DETAILS	0	

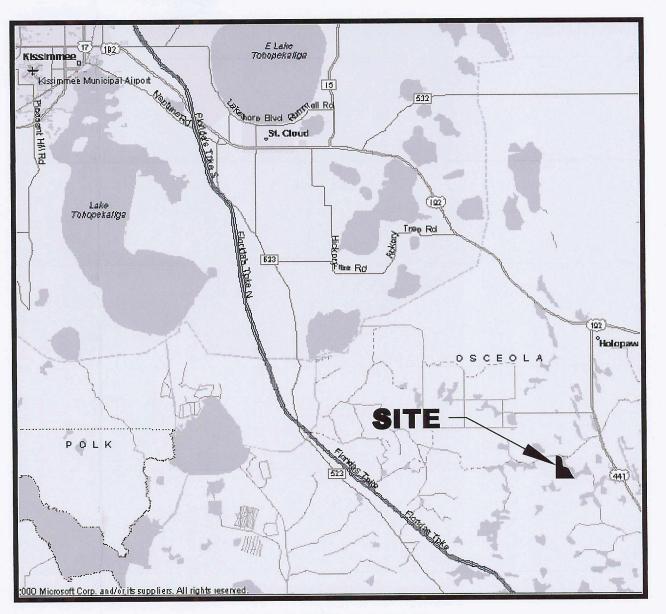



VICINITY MAP


SCALE: 1" = 4 MILES

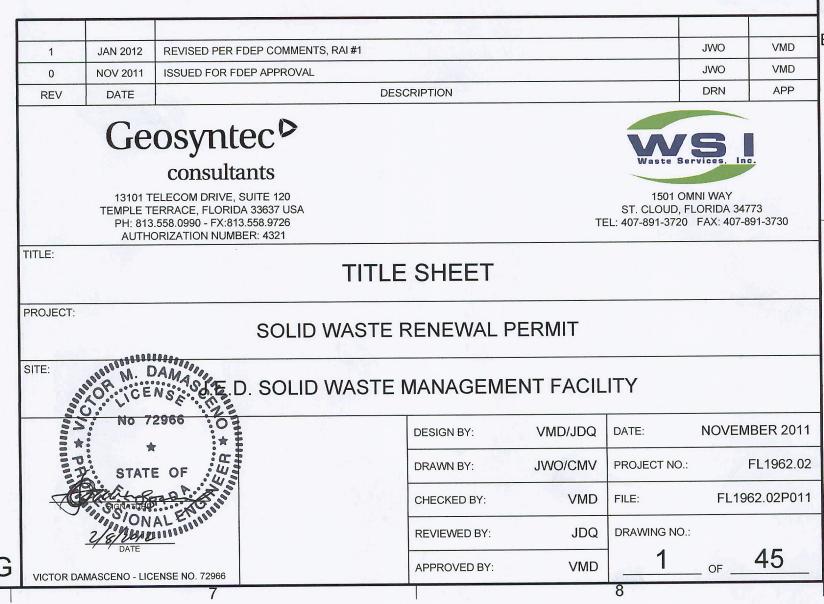



PERMIT DRAWING

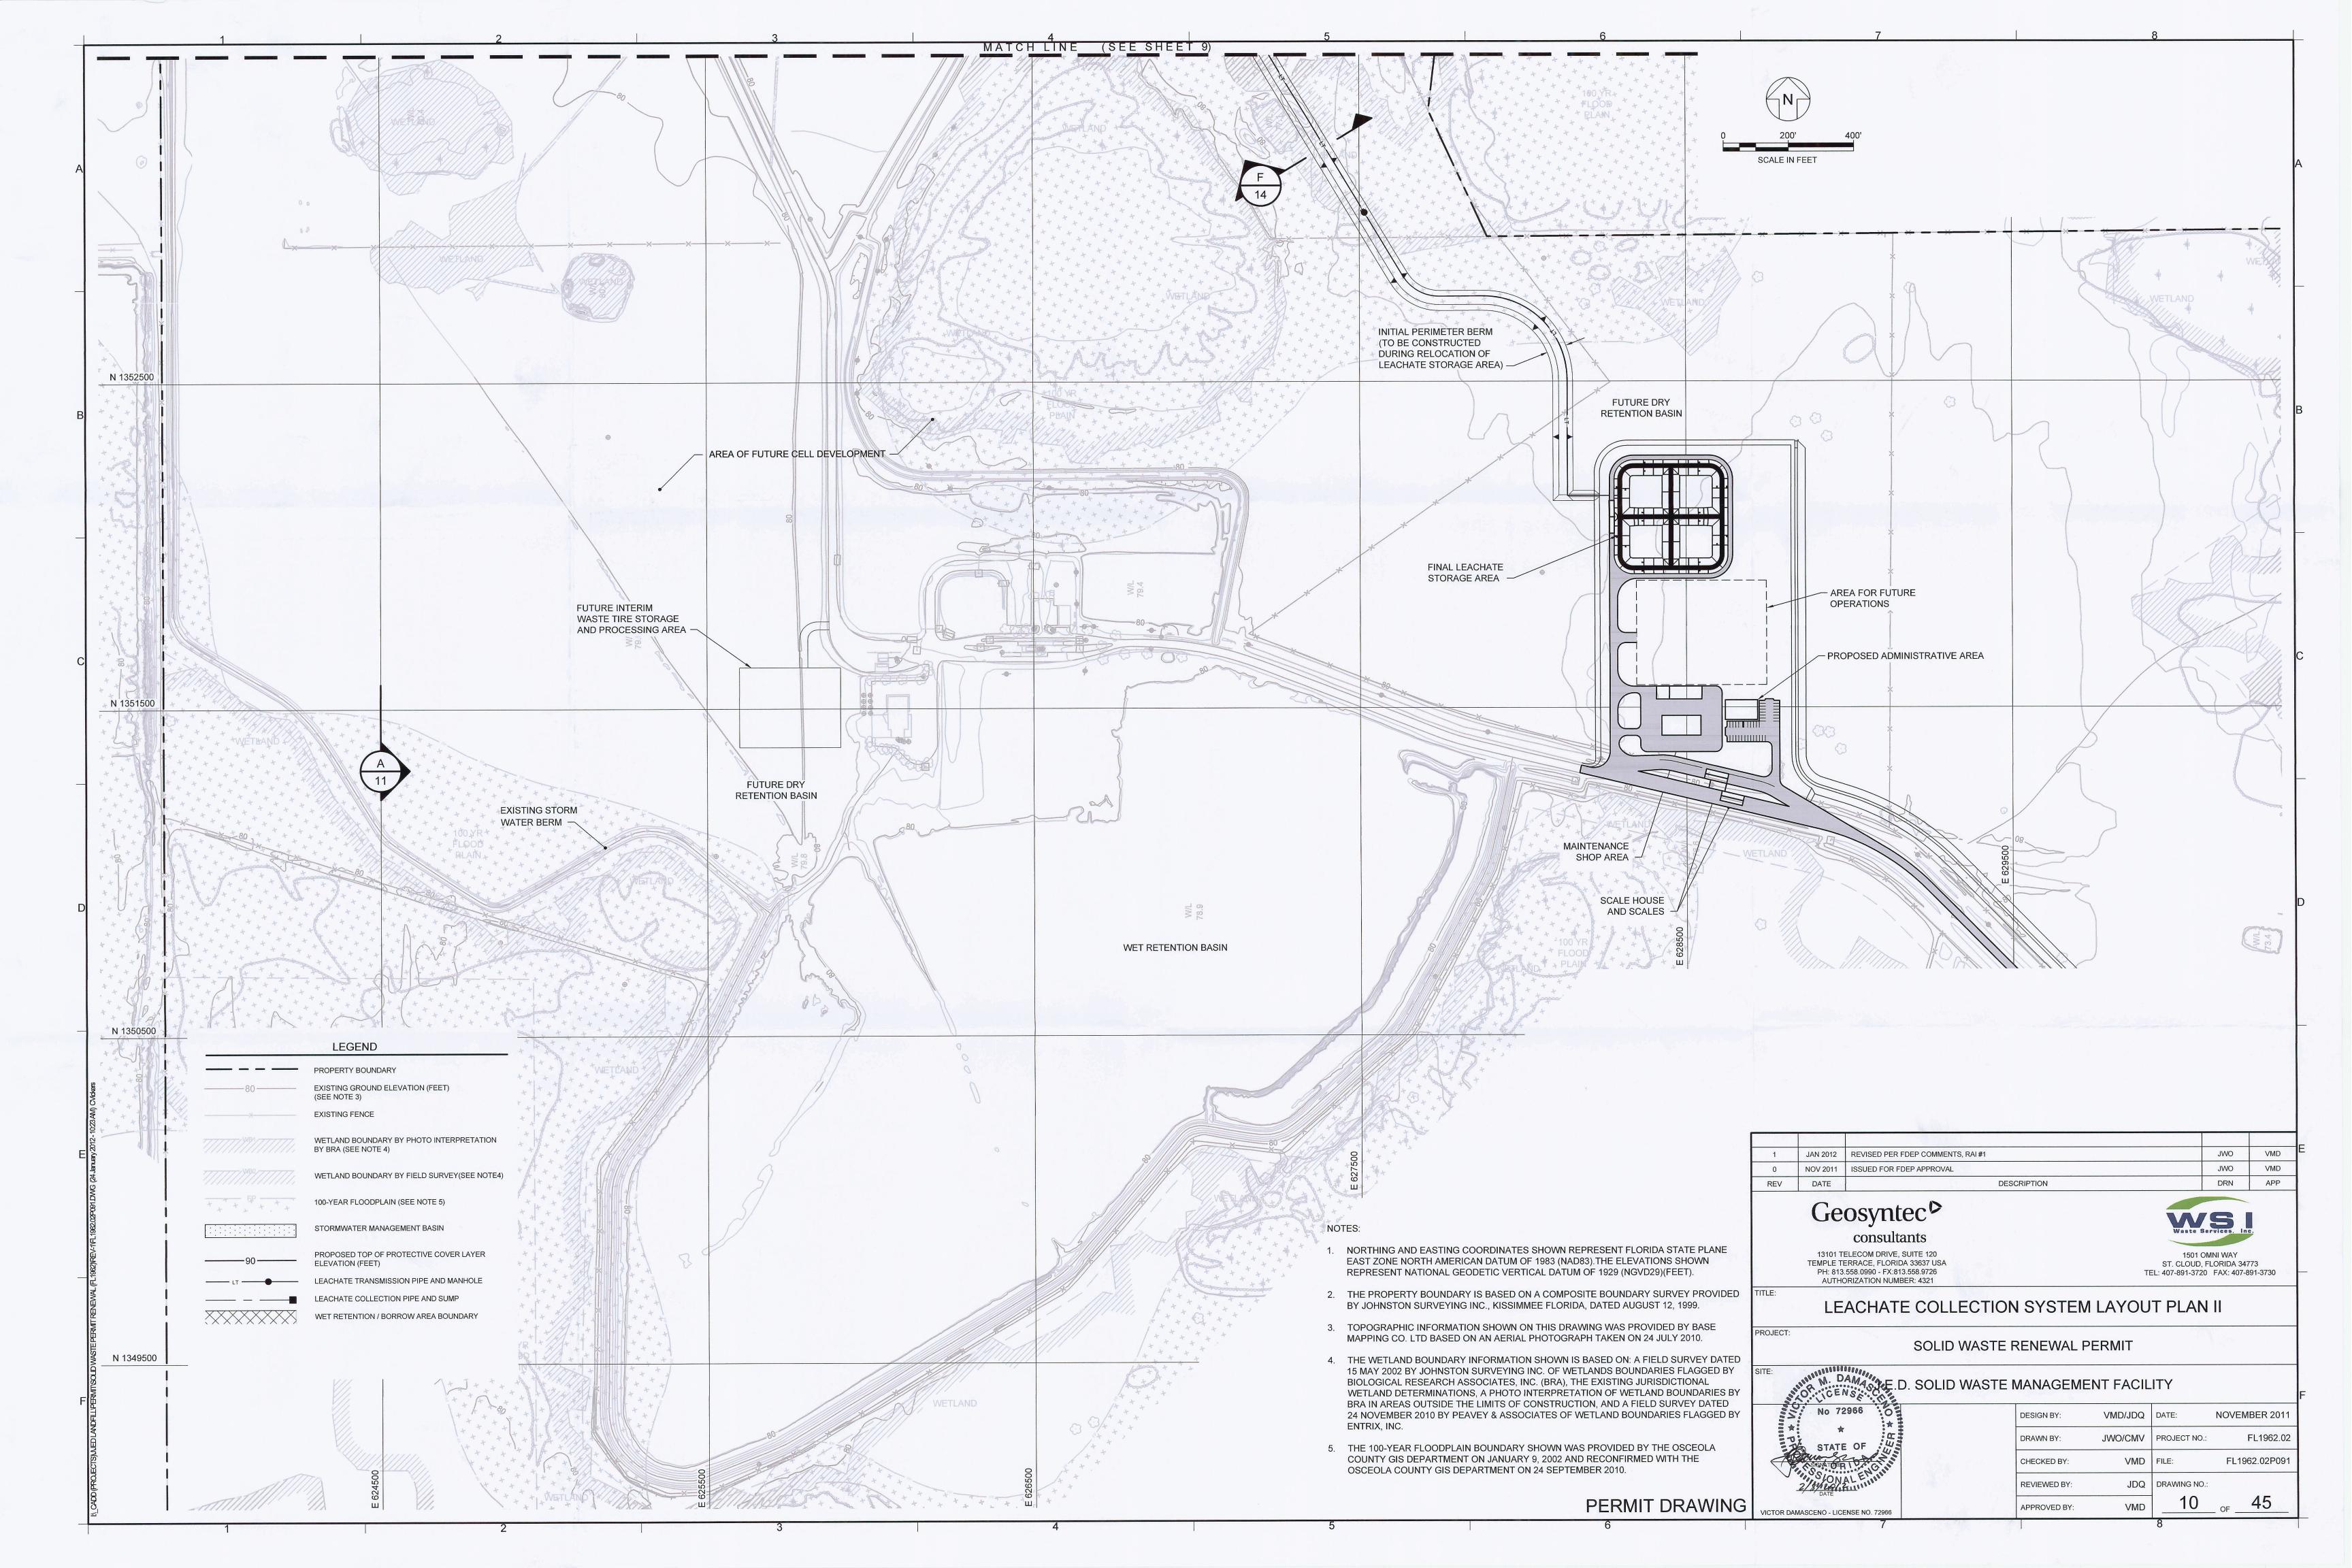

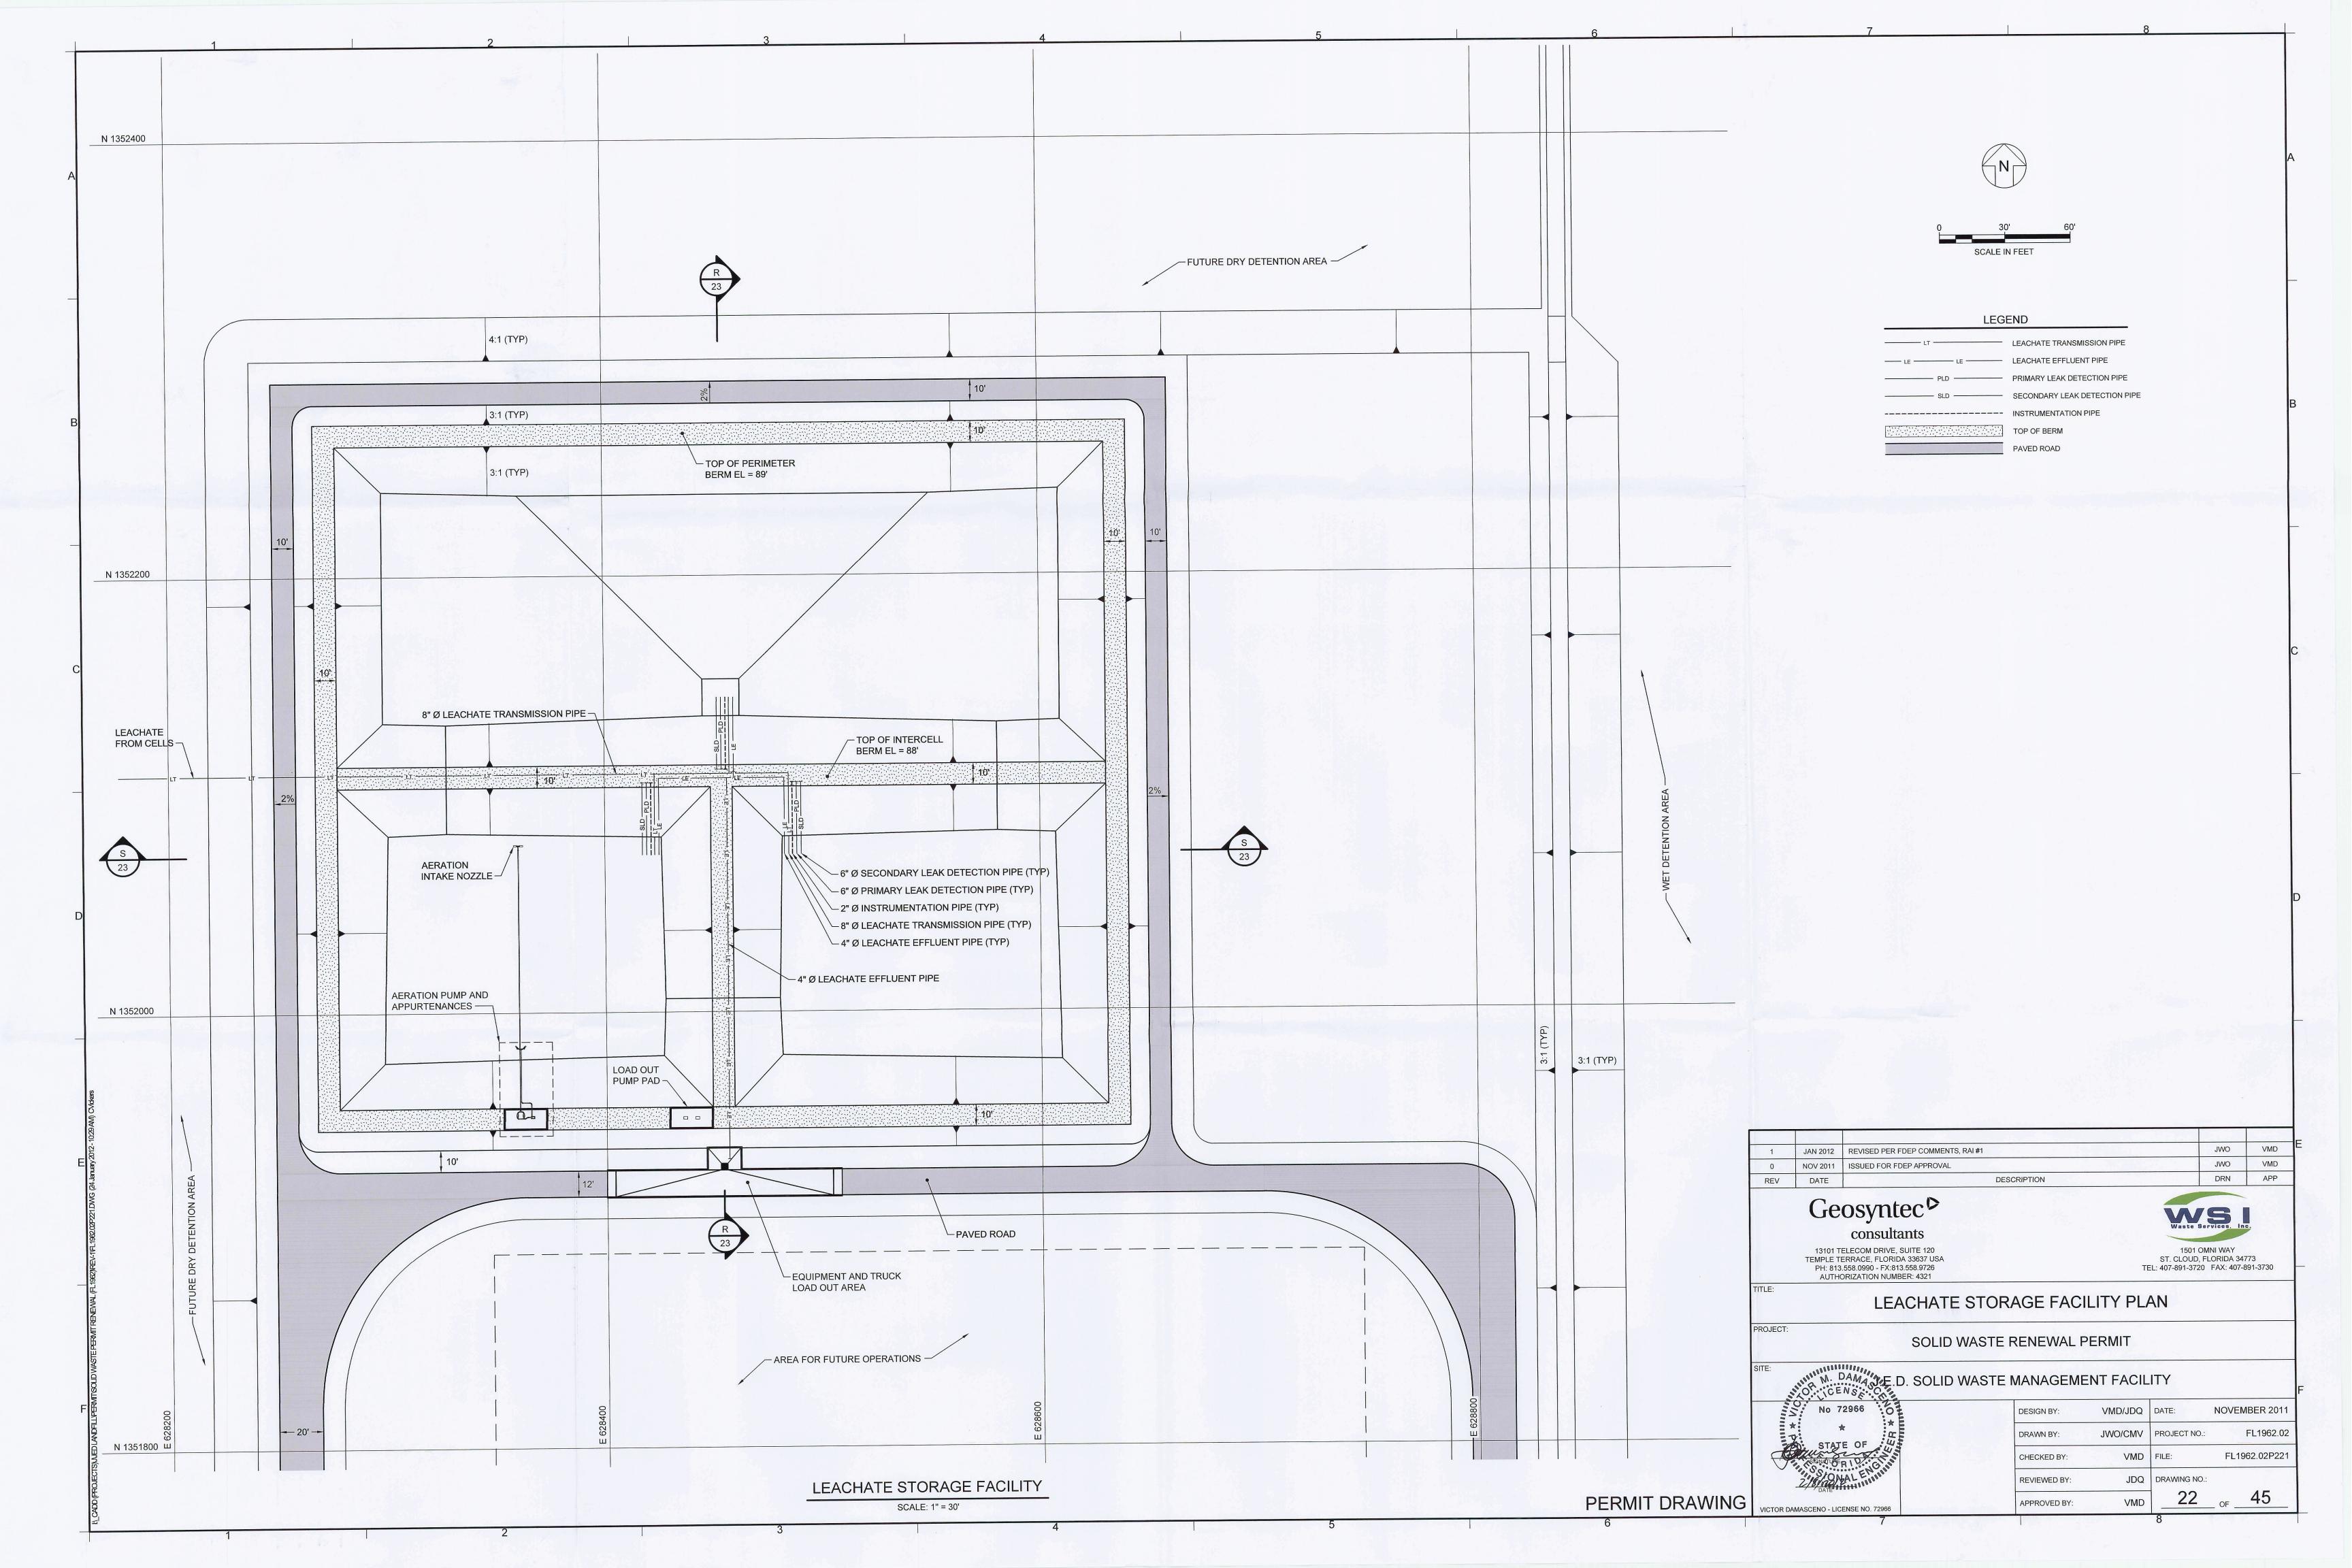

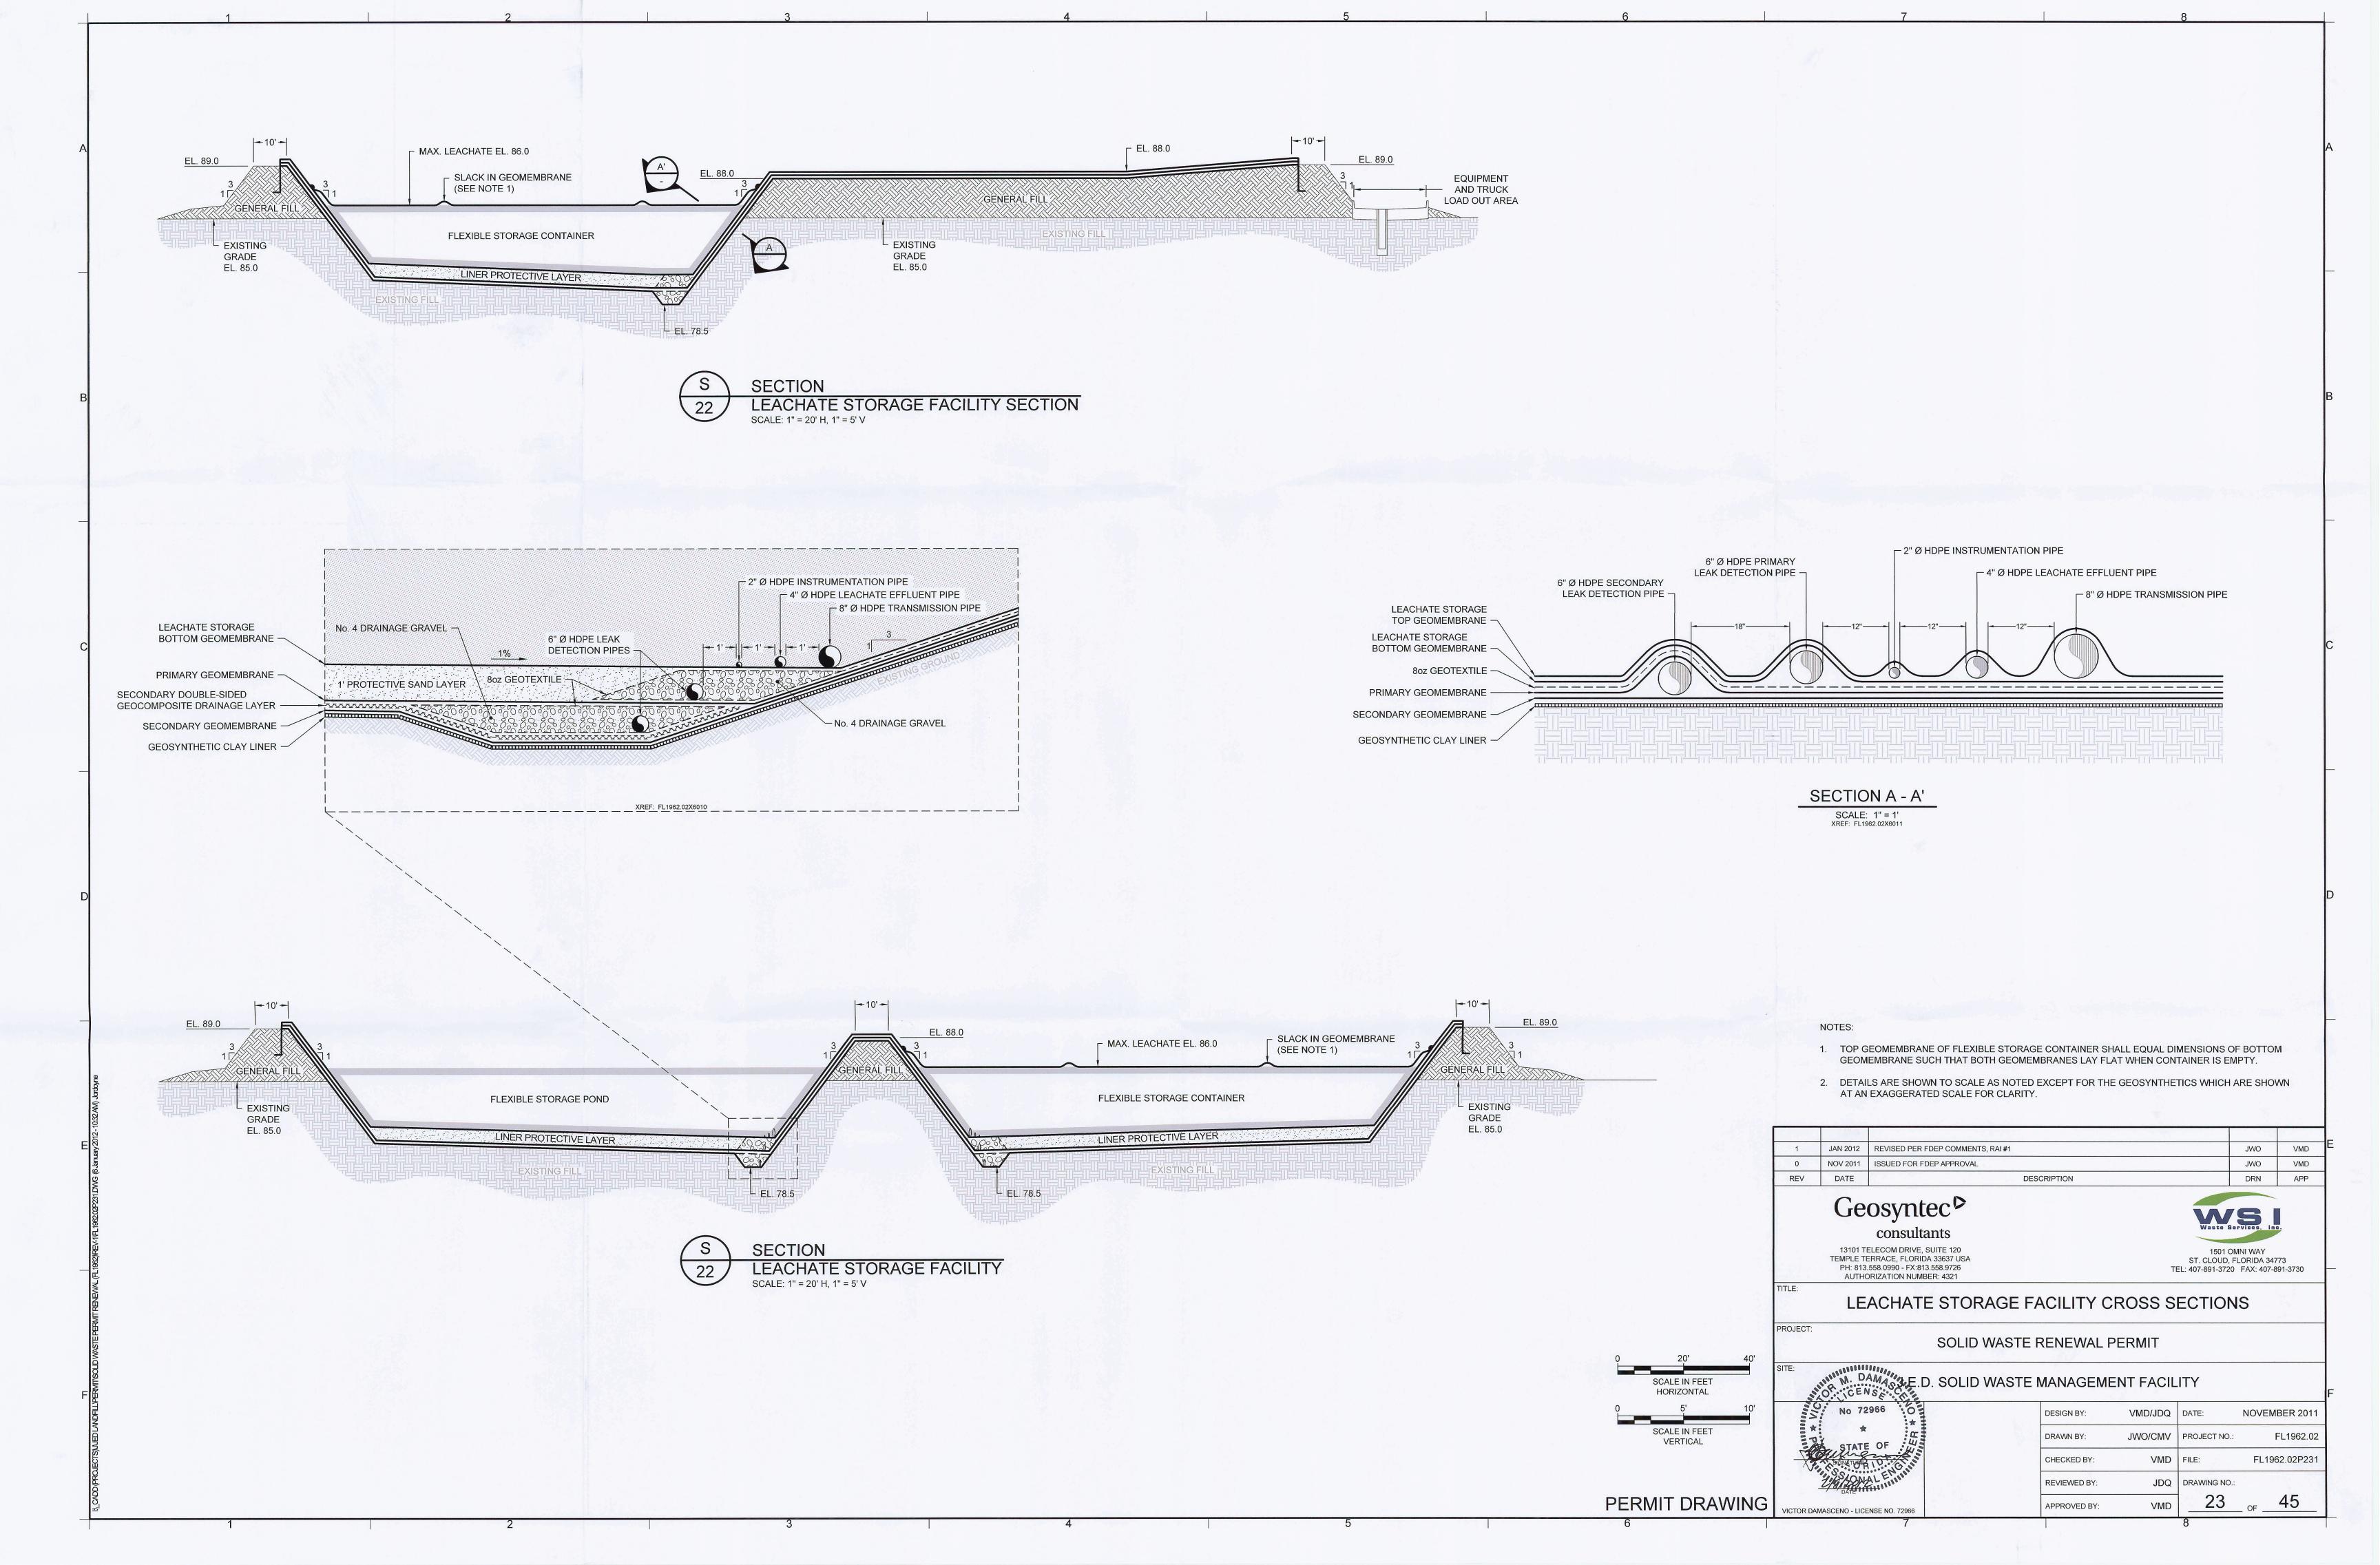


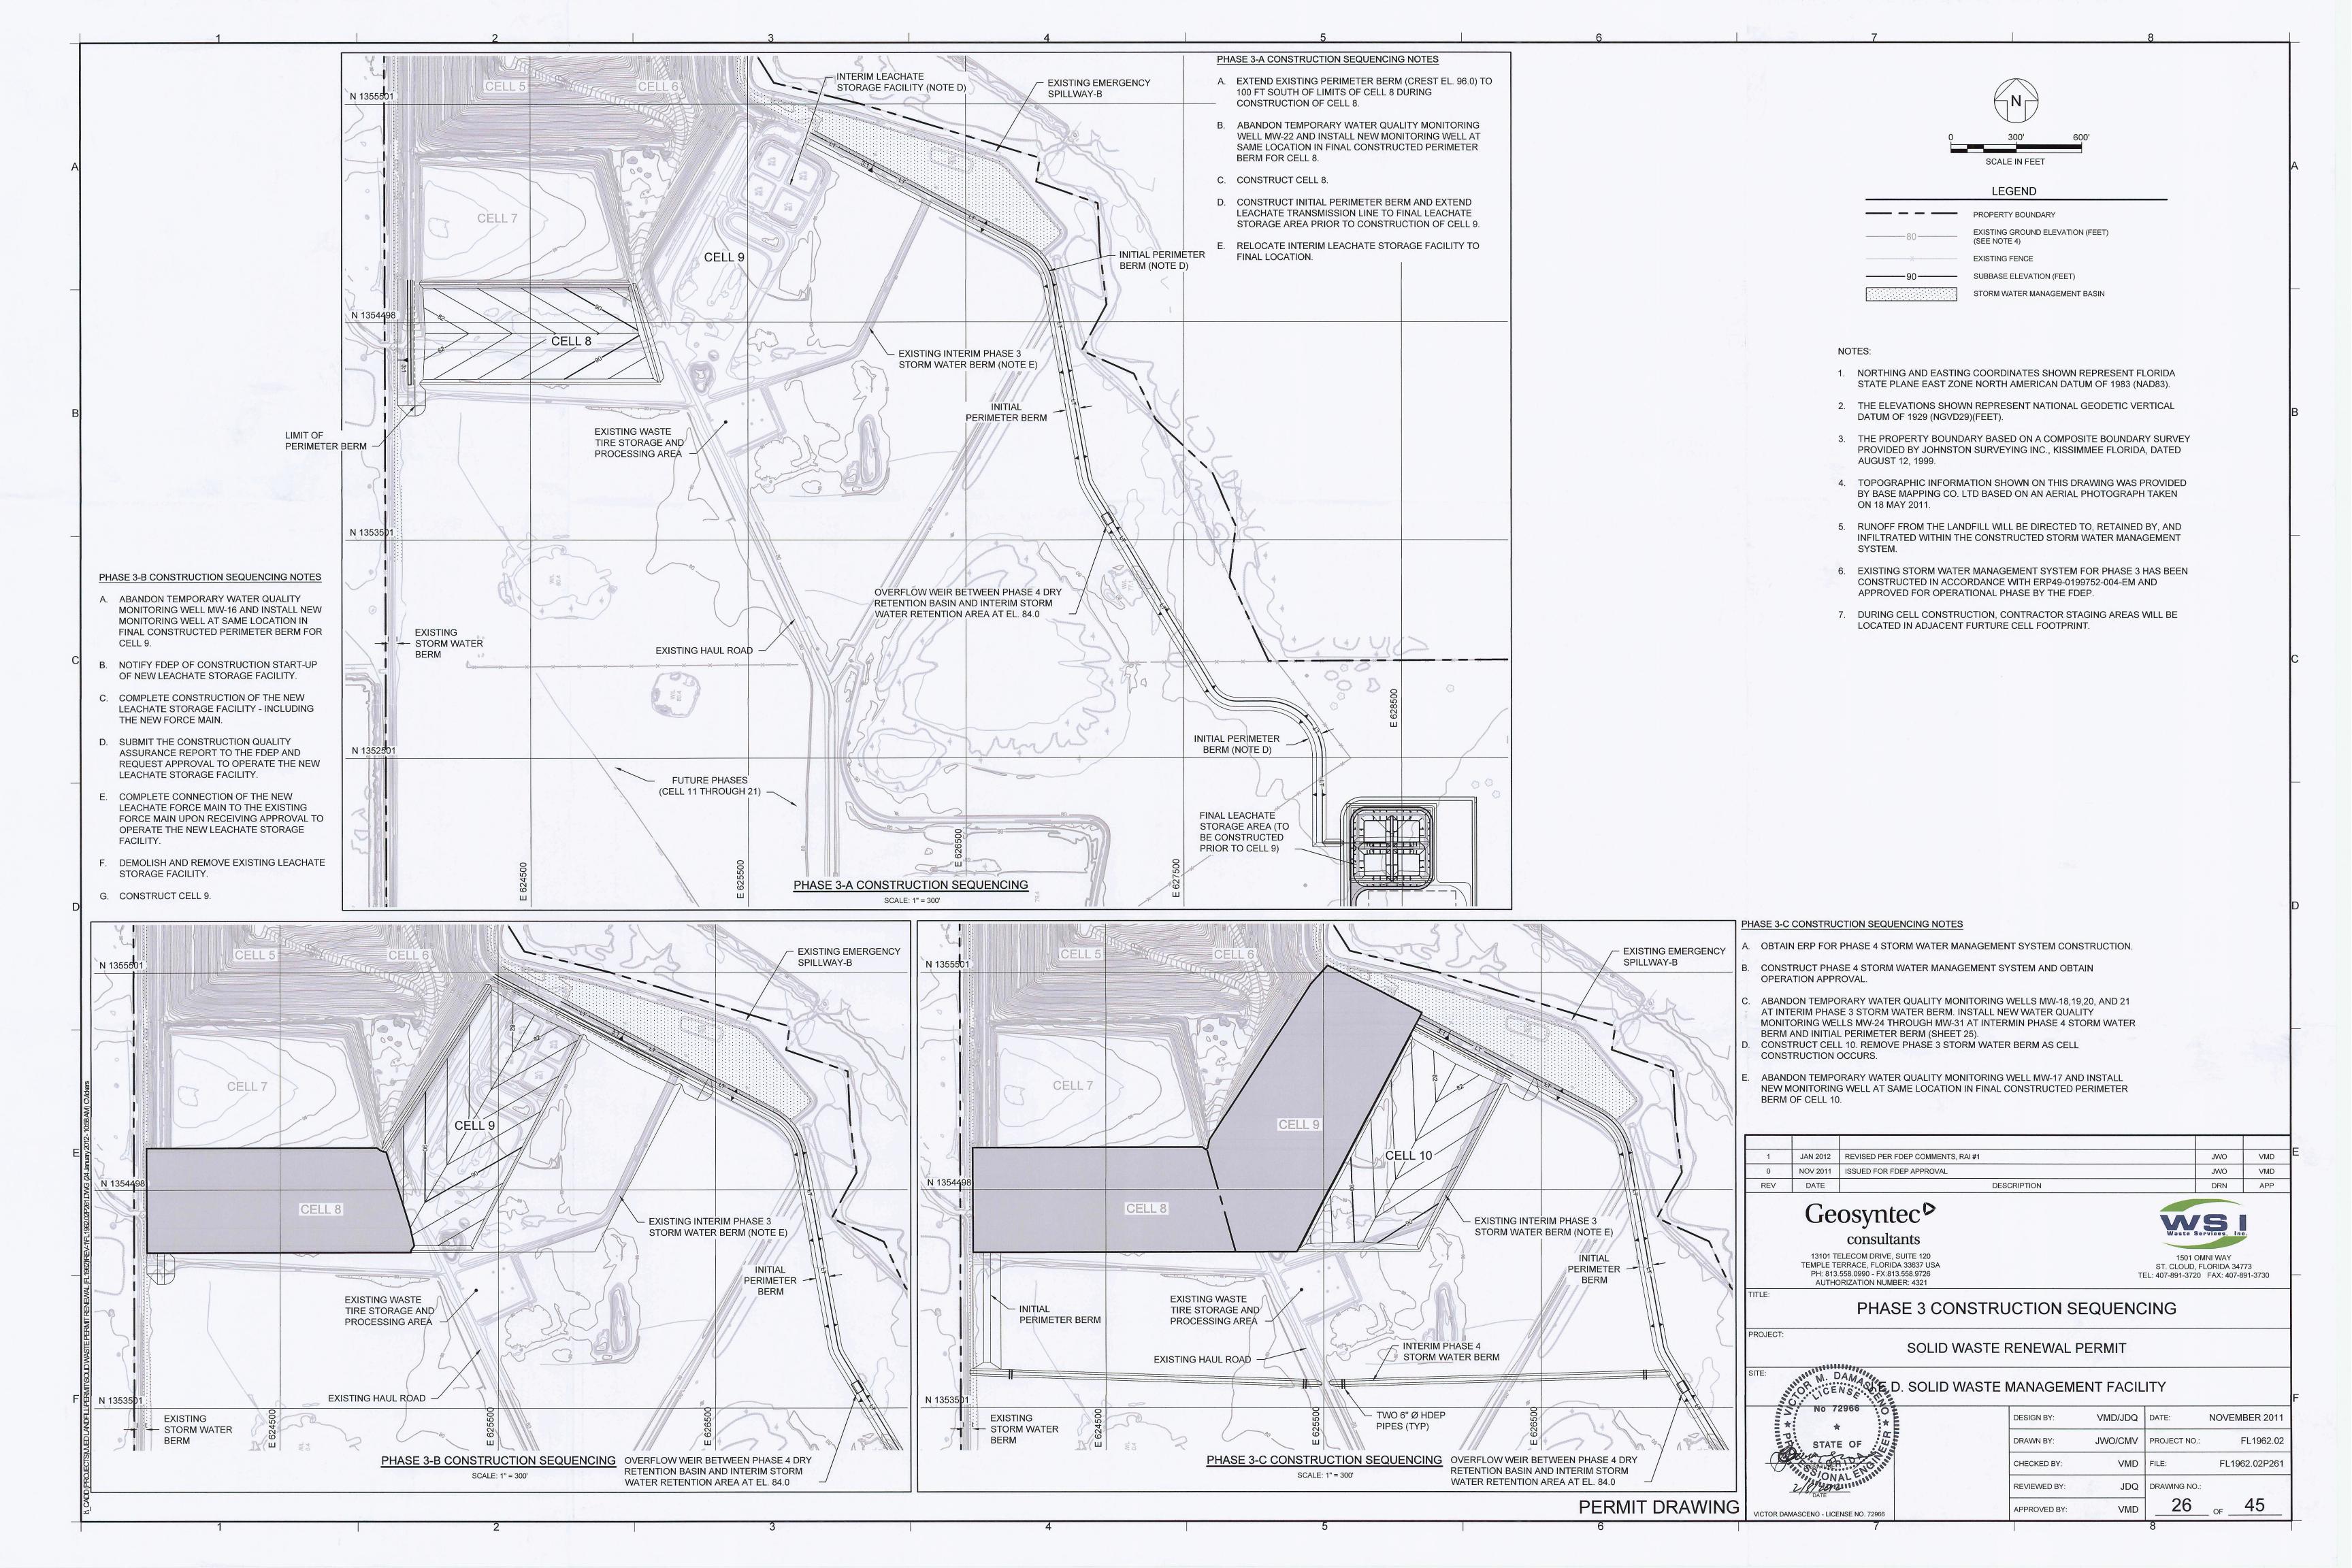

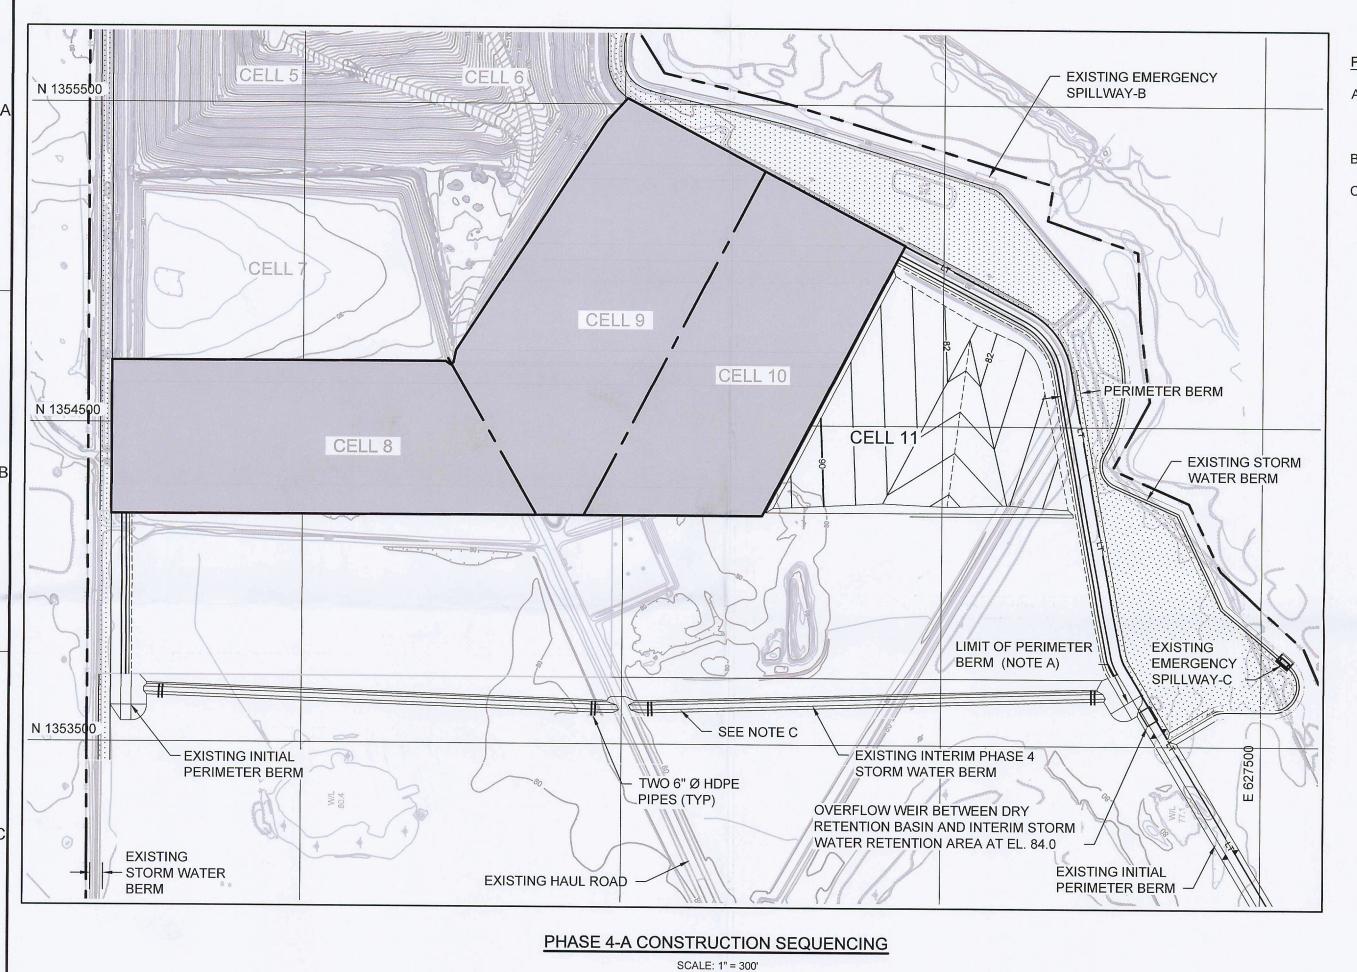

PHASE 4-A CONSTRUCTION SEQUENCING NOTES

- A. EXTEND EXISTING PERIMETER BERM (CREST EL. 96.0) TO 100 FT SOUTH OF LIMITS OF CELL 11 DURING CONSTRUCTION OF CELL 11.
- B. CONSTRUCT CELL 11.
- C. ABANDON TEMPORARY WATER QUALITY MONITORING WELLS MW-30 AND 31, AND INSTALL NEW MONITORING WELLS AT SAME LOCATION IN FINAL CONSTRUCTED PERIMETER BERM FOR CELL 11.

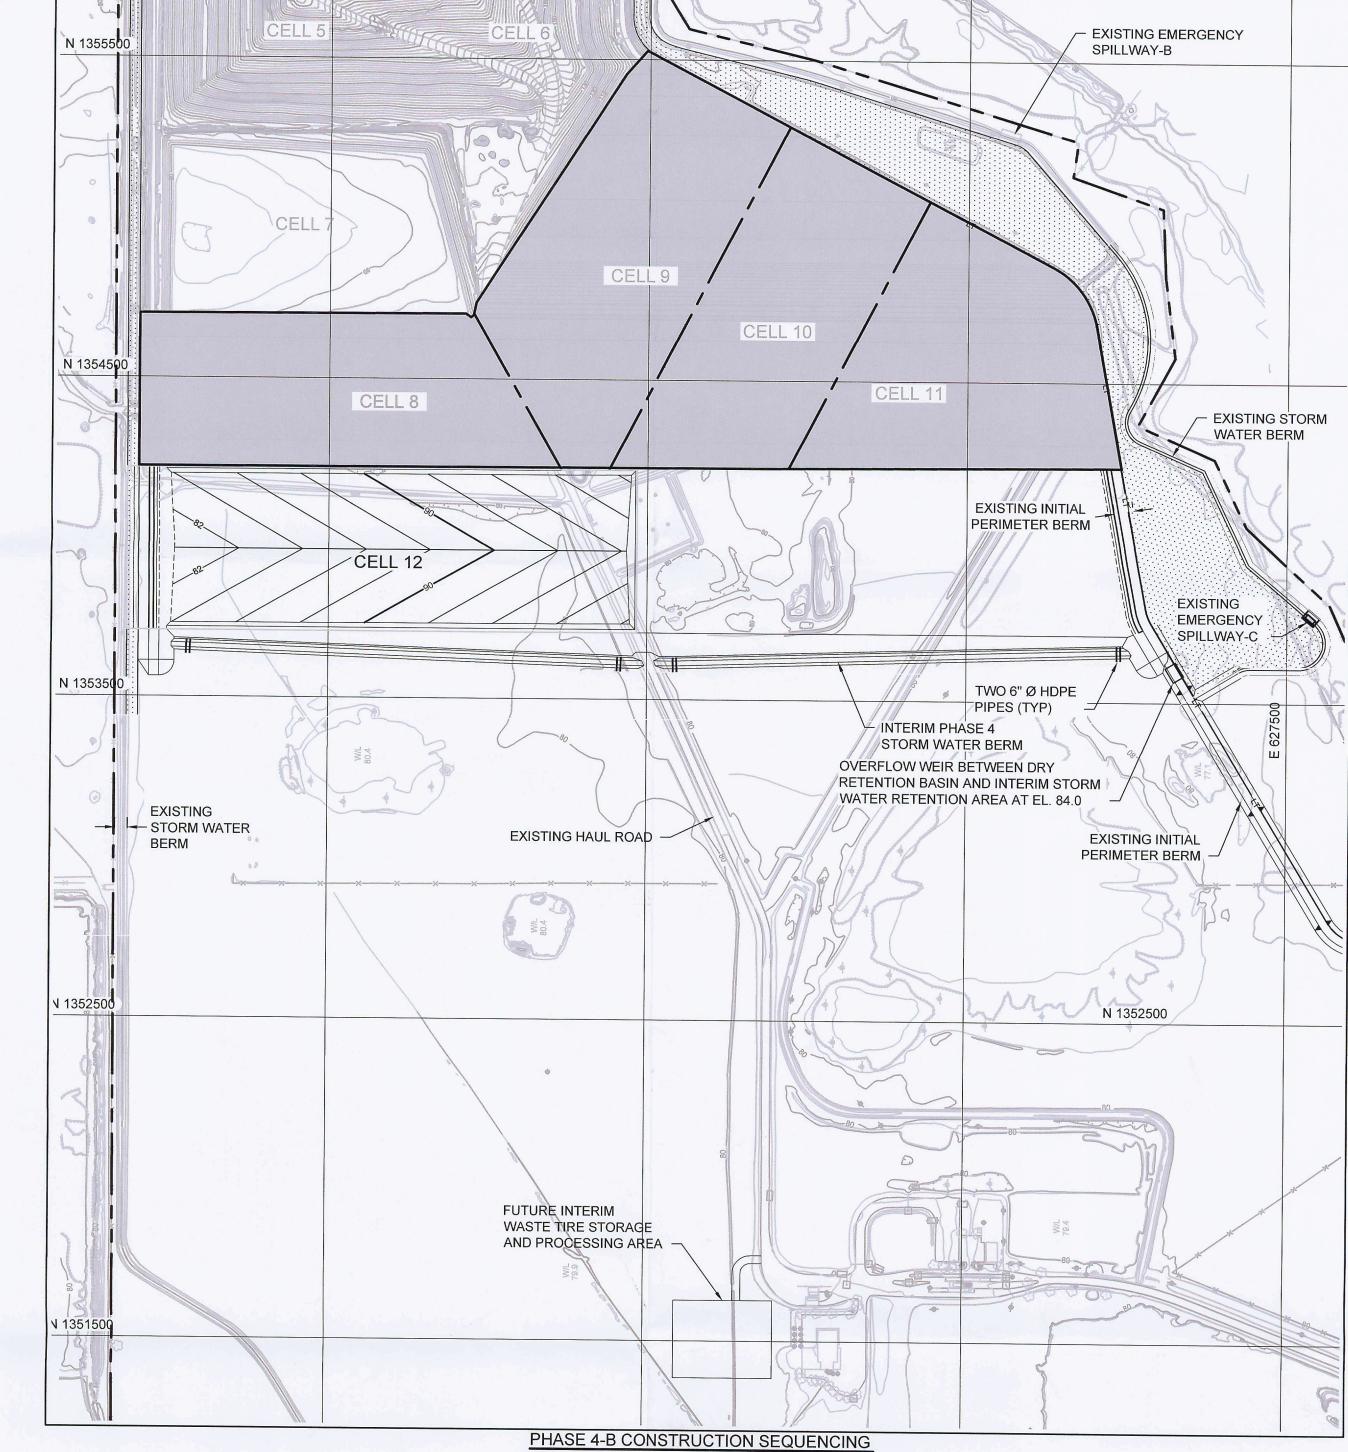

PHASE 4-C CONSTRUCTION SEQUENCING NOTES


- A. EXTEND EXISTING PERIMETER BERM TO 100FT SOUTH OF LIMITS OF CELL 13 DURING CONSTRUCTION OF CELL 13.
- B. CONSTRUCT CELL 13.

EXISTING EMERGENCY

SPILLWAY-B

EXISTING INITIAL

PERIMETER BERM -

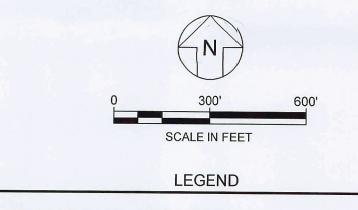

	DDODEDTY DOLINDADY
	PROPERTY BOUNDARY
80	EXISTING GROUND ELEVATION (FEET) (NOTE 4)
X	EXISTING FENCE
90	STORM WATER MANAGEMENT BASIN
	PROPOSED SUBBASE ELEVATION (FEET)

CONSTRUCTED STORM WATER MANAGEMENT SYSTEM.

PHASE 4-B CONSTRUCTION SEQUENCING NOTES

- A. RELOCATE WASTE TIRE STORAGE AND PROCESSING AREA PRIOR TO BEGINNING CELL 12 CONSTRUCTION. NEW INTERIM LOCATION TO BE WEST OF THE EXISTING MAINTENANCE SHOP (SHEET 10). SIZE AND DETAILS WILL BE CONSISTENT WITH APPROVED WASTE TIRE STORAGE AND PROCESSING PLAN.
- B. EXTEND EXISTING PERIMETER BERM TO 100 FT SOUTH OF LIMITS OF CELL 12 DURING CONSTRUCTION OF CELL 12.
- C. CONSTRUCT CELL 12.

consultants

AUTHORIZATION NUMBER: 4321

1 JAN 2012 REVISED PER FDEP COMMENTS, RAI #1

0 NOV 2011 ISSUED FOR FDEP APPROVAL JWO VMD REV DATE DRN APP Waste Services.

JWO

1501 OMNI WAY ST. CLOUD, FLORIDA 34773 TEL: 407-891-3720 FAX: 407-891-3730

VMD

13101 TELECOM DRIVE, SUITE 120 TEMPLE TERRACE, FLORIDA 33637 USA PH: 813.558.0990 - FX:813.558.9726

PROJECT:

VICTOR DAMASCENO - LICENSE NO. 72966

PERMIT DRAWING

SCALE: 1" = 300'

PHASE 4 CONSTRUCTION SEQUENCING

SOLID WASTE RENEWAL PERMIT

APPROVED BY:

E.D. SOLID WASTE MANAGEMENT FACILITY No 72966

DESIGN BY: VMD/JDQ DATE: NOVEMBER 2011 DRAWN BY: JWO/CMV | PROJECT NO.: FL1962.02 CHECKED BY: VMD | FILE: FL1962.02P271 REVIEWED BY JDQ DRAWING NO.:

- 1. NORTHING AND EASTING COORDINATES SHOWN REPRESENT FLORIDA STATE PLANE EAST ZONE NORTH AMERICAN DATUM OF 1983 (NAD83).
- 2. THE ELEVATIONS SHOWN REPRESENT NATIONAL GEODETIC VERTICAL DATUM OF 1929 (NGVD29)(FEET).
- 3. THE PROPERTY BOUNDARY BASED ON A COMPOSITE BOUNDARY SURVEY PROVIDED BY JOHNSTON SURVEYING INC., KISSIMMEE FLORIDA, DATED AUGUST 12, 1999.
- 4. TOPOGRAPHIC INFORMATION SHOWN ON THIS DRAWING WAS PROVIDED BY BASE MAPPING CO. LTD BASED ON AN AERIAL PHOTOGRAPH TAKEN ON 18 MAY 2011.

5. RUNOFF FROM THE LANDFILL WILL BE DIRECTED TO, RETAINED BY, AND INFILTRATED WITHIN THE

6. DURING CELL CONSTRUCTION, CONTRACTOR STAGING AREAS WILL BE LOCATED IN ADJACENT FURTURE CELL FOOTPRINT.

CELL 10 CELL 8 EXISTING STORM WATER BERM PERIMETER BERM CELL 12 EMERGENCY SPILLWAY-C TWO 6" Ø HDPE PIPES (TYP) EXISTING INTERIM PHASE 4 STORM WATER BERM

PHASE 4-C CONSTRUCTION SEQUENCING

SCALE: 1" = 300'

EXISTING HAUL ROAD

OVERFLOW WEIR BETWEEN DRY

RETENTION BASIN AND INTERIM STORM WATER RETENTION AREA AT EL. 84.0

PROPOSED LEACHATE

STORAGE AREA

EXISTING STORM WATER

BERM