#### CONTRACT PLANS COMPONENTS

PLUMBING STRUCTURES FIRE PROTECTION CIVILELECTRICAL

### INDEX OF STRUCTURE PLANS

SHEET NO.	SHEET DESCRIPTION
S-01	KEYSHEET
S-02	SIGNATURE SHEET
S-03	GENERAL NOTES (1 OF 2)
S-04	GENERAL NOTES (2 OF 2)
S-05	SUMMARY OF QUANTITIES
S-06	DEMOLITION PLAN
S-07	MARINA LAYOUT PLAN
S-08	SOIL PROFILES
S-09*	FRAMING PLAN
S-10	TYPICAL SECTIONS (1 OF 2)
S-11	TYPICAL SECTIONS (2 OF 2)
S-12	MISCELLANEOUS DETAILS (1 OF 2)
S-13	MISCELLANEOUS DETAILS (2 OF 2)

\*NOTE - NOT INCLUDED IN THIS SUBMITTAL

#### INDEX OF SITE CIVIL PLANS

SHEET NO.	SHEET DESCRIPTION
C-01	EROSION CONTROL GENERAL NOTES
C-02	SITE CIVIL AND EROSION CONTROL PLAN

#### INDEX OF ELECTRICAL PLANS

SHEET NO.	SHEET DESCRIPTION	
S-02 E-01 E-02	SIGNATURE SHEET ELECTRICAL LEGEND ELECTRICAL PLAN NOTES	BEGIN PROJECT
E-03 E-04 E-05 E-06 E-07	ELECTRICAL DEMOLITION PLAN ELECTRICAL PLAN POWER ONE-LINE DIAGRAM NOTES POWER ONE-LINE DIAGRAM PANEL SCHEDULE A	∇ VETERANS MEMORIAL LAI     N 27°59'22.96"     W 82°41'15.35"
E-08 E-09 E-10 E-11	PANEL SCHEDULE B PANEL SCHEDULE C MARINA PEDESTAL SCHEDULE DETAILS	

#### INDEX OF FIRE PROTECTION AND PLUMBING PLANS

SHEET NO.	SHEET DESCRIPTION
5-02	SIGNATURE SHEET
FP-01	FIRE PROTECTION COMPLIANCE NOTES
FP-02	FIRE PROTECTION SPECIFICATIONS
FP-03	FIRE PROTECTION GENERAL NOTES
FP-04	FIRE PROTECTION LEGEND
FP-05	FIRE PROTECTION FLOOR PLAN
P-01	PLUMBING NOTES, LEGEND, AND SCHEDULE
P-02	WATER FLOOR PLAN

#### GOVERNING DESIGN STANDARDS:

Florida Department of Transportation, FY 2024-25 Standard Plans for Road and Bridge Construction and applicable Interim Revisions (IRs) and as amended by


For Design Standard Plans click on "Standards Plans for Road and Bridge Construction" at the following web site: Https://www.fdot.gov/design/standardplans/

GOVERNING STANDARD SPECIFICATIONS:

Florida Department of Transportation, Standard Specifications for Road and Bridge Construction FY2024-25 as amended by Contract Documents.

## CITY OF SAFETY HARBOR

CONTRACT PLANS MARINA REPLACEMENT 110 VETERANS MEMORIAL LANE CIP #XXXXXXXX

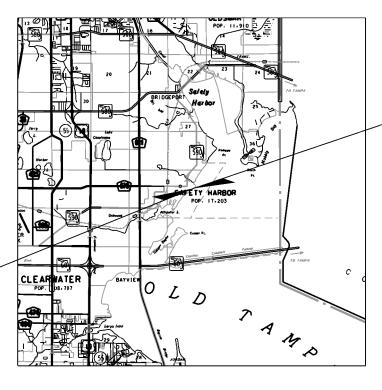

LOCATION MAP SECTION 3 TOWNSHIP 29S, RANGE 16E

PUBLIC WORKS DIRECTOR - CHARLES AHRENS. P.E.

60% SUBMITTAL NOT FOR CONSTRUCTION


END PROJECT

N 27°59'21.62"

W 82°41'12.88"

*Ç VETERANS MEMORIAL LANE* 

GOOGLE EARTH LINK PROVIDED FOR BRIDGE LOCATION. https://maps.app.goo.gl/VC2t1DhWkQB3zUEAA

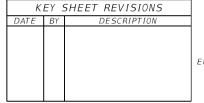

BOARD OF COUNTY COMMISSIONERS

JOE AYOUB ANDY STEINGOLD NANCY BESORE CARLOS DIAZ CLIF MERZ

LOCATION OF PROJECT

MAYORVICE-MAYOR COMMISSIONER COMMISSIONER COMMISSIONER

SHOP DRAWINGS TO BE SUBMITTED TO:

DAVID R. JOHNSON, P.E. DRMP, INC. 15310 AMBERLY DRIVE SUITE 310 TAMPA FL, 33647

PLANS PREPARED BY:

DRMP, INC. 15310 AMBERLY DRIVE SUITE 310 TAMPA FL, 33647 PHONE: (813) 265-9800 DAVID R. JOHNSON. P.E. 79354

NOTE: THE SCALE OF THESE PLANS MAY HAVE CHANGED DUE TO REPRODUCTION.


ENGINEER OF RECORD: DAVID R. JOHNSON, P.E.

P.E. NO.: 79354

FISCAL YEAR SHEET NO. 5-01 24

P:\Projects22\22-00709.001 Marina Basin - Dock Repair\ CADD\struct\B1 KeySheet01.dgn

Contract Documents.

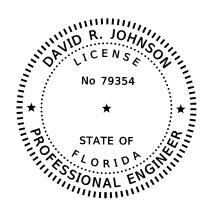

THIS ITEM HAS BEEN DIGITALLY SIGNED AND SEALED BY

ON THE DATE ADJACENT TO THE SEAL.

PRINTED COPIES OF THIS DOCUMENT ARE NOT CONSIDERED SIGNED AND SEALED AND THE SIGNATURE MUST BE VERIFIED ON ANY ELECTRONIC COPIES.

DRMP, INC. DAVID R. JOHNSON, P.E. P.E. LICENSE NUMBER 79354 15310 AMBERLY DRIVE, SUITE 200 TAMPA, FL. 33647

THE ABOVE NAMED PROFESSIONAL ENGINEER SHALL BE RESPONSIBLE FOR THE FOLLOWING SHEETS IN ACCORDANCE WITH RULE 61G15-23.004, F.A.C.

#### STRUCTURE PLANS


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#### SITE CIVIL PLANS

SHEET NO. SHEET DESCRIPTION

C-01 EROSION CONTROL GENERAL NOTES C-02 SITE CIVIL AND EROSION CONTROL PLAN

\*NOTE - NOT INCLUDED IN THIS SUBMITTAL

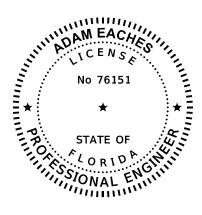

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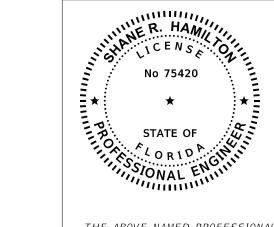
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HALL ENGINEERING GROUP ADAM EACHES, P.E. P.E. LICENSE NUMBER 76151 3820 GUNN HIGHWAY, SUITE 200 TAMPA, FL. 33618

THE ABOVE NAMED PROFESSIONAL ENGINEER SHALL BE RESPONSIBLE FOR THE FOLLOWING SHEETS IN ACCORDANCE WITH RULE 61G15-23.004, F.A.C.

#### ELECTRICAL PLANS

SHEET NO.	SHEET DESCRIPTION
S-02	SIGNATURE SHEET
E-01	ELECTRICAL LEGEND
E-02	ELECTRICAL PLAN NOTES
E-03	ELECTRICAL DEMOLITION PLAN
E-04	ELECTRICAL PLAN
E-05	POWER ONE-LINE DIAGRAM NOTES
E-06	POWER ONE-LINE DIAGRAM
E-07	PANEL SCHEDULE A
E-08	PANEL SCHEDULE B
E-09	PANEL SCHEDULE C
E-10	MARINA PEDESTAL SCHEDULE
E-11	DETAILS



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ENGINEERING PROFESSIONALS, INC. SHANE R. HAMILTON, P.E. P.E. LICENSE NUMBER 75420 912 W. DR. MARTIN LUTHER KING JR. BLVD. TAMPA, FL 33603

THE ABOVE NAMED PROFESSIONAL ENGINEER SHALL BE RESPONSIBLE FOR THE FOLLOWING SHEETS IN ACCORDANCE WITH RULE 61G15-23.004, F.A.C.

#### FIRE PROTECTION AND PLUMBING PLANS CHEET NO CULET DESCRIPTION

SHEET NO.	SHEET DESCRIPTION
S-02	SIGNATURE SHEET
FP-01	FIRE PROTECTION COMPLIANCE NOTES
FP-02	FIRE PROTECTION SPECIFICATIONS
FP-03	FIRE PROTECTION GENERAL NOTES
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P-01	PLUMBING NOTES, LEGEND, AND SCHEDULE
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TIERRA, INC. DANIEL R. RUEL, P.E. P.E. LICENSE NUMBER 82404 7351 TEMPLE TERRACE HIGHWAY TAMPA, FL 33637

THE ABOVE NAMED PROFESSIONAL ENGINEER SHALL BE RESPONSIBLE FOR THE FOLLOWING SHEETS IN ACCORDANCE WITH RULE 61G15-23.004, F.A.C.

#### STRUCTURE PLANS

SHEET DESCRIPTION SHEET NO.

S-02 SIGNATURE SHEET S-08 SOIL PROFILES

REVISIONS					
DATE	BY	DESCRIPTION	DATE	BY	DESCRIPTION
					60% SUBMITTAL NOT FOR CONSTRUCTION

DAVID R. JOHNSON, P.E. P.E. NO.: 79354 DRMP, INC. 15310 AMBERLY DRIVE, SUITE 200 TAMPA, FL 33647



	SHEET TITLE:	TWA NO.
i	SIGNATURE SHEET	
L	PROJECT NAME:	SHEET NO.
	SAFETY HARBOR MARINA REPLACEMENT	5-02

DESIGN AND CONSTRUCTION SPECIFICATIONS:

- FLORIDA DEPARTMENT OF TRANSPORTATION (FDOT) STANDARD SPECIFICATIONS FOR ROAD AND BRIDGE CONSTRUCTION FY2024-25 EDITION, AS AMENDED BY CONTRACT DOCUMENTS.
- FLORIDA BUILDING CODE 8TH EDITION (2023).
- NATIONAL DESIGN SPECIFICATION FOR WOOD CONSTRUCTION AMERICAN WOOD COUNCIL 2018
- AMERICAN SOCIETY OF CIVIL ENGINEERS, ASCE 7-16.
- E) AISC STEEL CONSTRUCTION MANUAL 16TH EDITION.

#### DESIGN METHOD

LOAD AND RESISTANCE FACTOR DESIGN (LRFD) METHOD USING STRENGTH AND SERVICE LIMIT STATES.

#### DESIGN LOADINGS

- DEAD LOAD 10 PSF
- LIVE LOAD 100 PSF
- WIND LOAD:
  - A) DESIGN WIND SPEED 150 MPH
  - B) RISK CATEGORY
  - 11 C) EXPOSURE CATEGORY D
  - D) IMPORTANCE FACTOR 1.0

### GENERAL NOTES

- 1. COMPLY WITH ALL STATE, COUNTY, AND LOCAL ORDINANCES AND OBTAIN WORK PERMITS THAT ARE REQUIRED PRIOR TO CONSTRUCTION.
- LOCATION, ELEVATION, AND DIMENSIONS OF EXISTING UTILITIES, STRUCTURES, AND OTHER FEATURES ARE SHOWN IN ACCORDANCE WITH THE BEST INFORMATION AVAILABLE AT THE TIME OF THE PREPARATION OF THESE PLANS, BUT DO NOT PURPORT TO BE ABSOLUTELY CORRECT. VERIFY THE LOCATION, ELEVATION, AND DIMENSIONS OF ALL EXISTING UTILITIES, STRUCTURES, AND OTHER FEATURES AFFECTING THE WORK.
- ALL DIMENSIONS IN THESE PLANS ARE MEASURED IN FEET AND INCHES EITHER HORIZONTALLY OR VERTICALLY UNLESS OTHERWISE NOTED.
- PLAN ELEVATIONS ARE IN FEET AND REFER TO NAVD 1988 DATUM. VERTICAL DATUM CONVERSION, NGVD29 TO NAVD88 = -0.856
- PROVIDE AND MAINTAIN TURBIDITY BARRIERS IN ACCORDANCE WITH PERMITS.

#### MARINE NAVIGATION

- 1. MAINTAIN VISIBLE AND FUNCTIONAL EXISTING SIGNS AT ALL TIMES DURING CONSTRUCTION. AT THE APPROVAL OF THE ENGINEER TEMPORARILY RELOCATE EXISTING SIGNS TO FACILITATE CONSTRUCTION. RETURN ALL RELOCATED SIGNS TO THEIR ORIGINAL LOCATION AFTER CONSTRUCTION
- MARINE TRAFFIC CONSTRUCTION SIGNS ARE TO BE PLACED AT THE ENTRACE OF THE PARKING LOT AND AT THE CHANNEL ENTRACE PRIOR TO THE BOAT RAMP FOR INCOMING MARINE TRAFFIC. PLACEMENT OF THE SIGNS IS TO BE SUCH THAT THEY ARE CLEARLY VISIBLE TO APPROACHING TRAFFIC. BARGES LEFT IN WATER IN LOW-LIGHT CONDITIONS SHALL BE ILLUMINATED SO AS TO BE VISIBLE TO MARINE TRAFFIC.
- NOTIFY LT. CLARK SANFORD AT THE USCG SECTOR ST. PETERSBURG AT 813-228-2191 EXT. 8105 PRIOR TO THE COMMENCEMENT OF CONSTRUCTION ACTIVITIES. IN ADVANCE OF ACTIONS DURING CONSTRUCTION OR DEMOLITION WHICH POTENTIALLY AFFECT WATERWAY USERS AND PRIOR TO THE PLACEMENT OF ANY FLOATING CONSTRUCTION EQUIPMENT IN THE WATERWAY. NOTIFY NO LESS THAN 60 DAYS IN ADVANCE OF ACTIONS WHICH COULD POTENTIALLY AFFECT THE WATERWAY. KEEP THE CHANNEL OPEN TO WATERWAY TRAFFIC AT ALL TIMES.

- TIMBER: UNLESS OTHERWISE NOTED, ALL SAWN LUMBER AND TIMBER PILES EXCEPT BENT CAPS AND STRINGERS SHALL BE GRADE NO. 2 SOUTHERN YELLOW PINE OR BETTER. BENT CAPS AND STRINGERS SHALL BE NO. 1 SOUTHERN YELLOW PINE OR BETTER.
- DECKING: ALL DECKING SHALL BE A UV-RESISTANT ENGINEERED COMPOSITE MATERIAL WEARDECK OR EQUAL. COLOR OF DECKING SHALL BE "SADDLE".
- HURRICANE FASTENERS: STAINLESS STEEL AISI TYPE 316 W/ UPLIFT CAPACITY OF 360 LBF. EACH MINIMUM.
- ANCHOR BOLTS: STAINLESS STEEL AISI TYPE 316.
- ANCHOR BOLT ADHESIVE: TYPE F ADHESIVE EPOXY MATERIAL.

#### UTILITIES

- PROVIDE TWO WORKING DAYS NOTICE TO UTILITY AGENCY/OWNER'S (UAO IN ORDER TO LOCATE AND IDENTIFY THEIR EXISTING UNDERGROUND FACILITIES PRIOR TO CONSTRUCTION, AS ESTABLISHED BY THE "UNDERGROUND FACILITY DAMAGE PREVENTION AND SAFETY ACT".
- COORDINATE CONSTRUCTION SCHEDULING WITH UTILITY AGENCY/OWNER'S. MEET WITH UAO'S PRIOR TO THE PRE-CONSTRUCTION CONFERENCE TO ADJUST THEIR SCHEDULES TO COINCIDE WITH THE CONSTRUCTION SCHEDULE.

#### **EXISTING STRUCTURE**

- REMOVAL OF EXISTING STRUCTURES SHALL COMPLY WITH SECTION 110-7 OF THE SPECIFICATIONS. IF PILES ARE UNABLE TO BE PULLED CLEANLY, CUT PILES 2'-0" BELOW MUDLINE. PROPERLY DISPOSE OF TREATED TIMBER PER SPECIFICATIONS. WORK IS TO BE PAID FOR UNDER PAY ITEM 110-82, "REMOVE & DISPOSE OF STRUCTURAL TIMBER."
- ORIGINAL STRUCTURE YEAR BUILT IS UNKNOWN. MAJORITY OF STRUCTURE WAS RECONSTRUCTED IN 2006. 2006 EXISTING PLANS ARE PROVIDED AND ARE FOR INFORMATIONAL PURPOSES ONLY.

#### MONITOR EXISTING STRUCTURES

MONITOR SETTLEMENT AND VIBRATIONS ON EXISTING STRUCTURES PER SPECIFICATIONS SECTION 108.

#### PILE INSTALLATION NOTES

- ALL 8" Ø TIMBER DOCK PILES AND 10" Ø TIE PILES SHALL BE DRIVEN. JETTING IS NOT ALLOWED WITHOUT APPROVAL OF THE ENGINEER.
- VERIFY THE LOCATION OF ALL UTILITIES AND NOTIFY ALL INVOLVED UTILITY COMPANIES PRIOR TO EXCAVATION, PILE DRIVING OR CONSTRUCTION TO AVOID DAMAGE. ENSURE THAT ACTIVE UTILITIES ARE PROPERLY MAINTAINED AND PROTECTED DURING CONSTRUCTION.
- FOR DETAILS REGARDING SPT SOIL BORINGS, SEE "SOIL PROFILES" SHEET.
- PRIOR TO PILE DRIVING OPERATIONS, INFORM THE ENGINEER IF ANY PROPOSED PILE LOCATION INTERFERES WITH EXISTING PILE, AND PILE WAS UNABLE TO BE CLEANLY REMOVED.
- DRIVE PILES TO THE NOMINAL BEARING RESISTANCE IN ACCORDANCE WITH STANDARD SPECIFICATION 455 AND AS FOLLOWS,

### FACTORED DESIGN LOAD + NET SCOUR RESISTANCE + DOWN DRAG

- NOMINAL BEARING RESISTANCE = 7 TONS BASED ON FACTORED DESIGN LOAD = 8 KIPS AND Ø = 0.65.
- ESTIMATED PILE TIP DEPTH BELOW MUDLINE VARIES (9 FT. TO 22 FT.). REFUSAL MAY BE ENCOUNTERED PRIOR TO THESE DEPTHS IF A DENSER SOIL LAYER IS ENCOUNTERED.
- SELECT THE APPROPRIATE HAMMER TO ACHIEVE DESIGN REQUIREMENTS SHOWN IN THE PLANS AND SUBMIT A PILE INSTALLATION PLAN PRIOR TO MOBILIZATION.
- RESTRICT PILE DRIVING TO DAYTIME HOURS.
- 10. WEATHERED LIMESTONE WAS ENCOUNTERED WITHIN BORINGS. EXCAVATIONS/PREFORMING INTO AND/OR THROUGH THESE MATERIALS WILL BE DIFFICULT AND REQUIRE NON-CONVENTIONAL CONSTRUCTION TECHNIQUES AND SPECIALIZED EQUIPMENT. LIMESTONE IS POROUS AND WILL BE DIFFICULT TO DEWATER.
- 11. ARTESTIAN CONDITIONS SHOULD BE EXPECTED. TOOLS AND CONSTRUCTION METHODS SHALL INCLUDE THE ABILITY TO HANDLE A POTENTIOMETRIC HEAD ELEVATION OF +10 FT. (NGVD) AT NO
- 12. CONTACT THE ENGINEER IF PRACTICAL REFUSAL IS MET BEFORE 10 FEET OF EMBEDMENT IS ACHIEVED.

#### PILE WRAP

- INSTALL PILE WRAP PER MANUFACTURER'S RECOMMENDATIONS.
- 2. PILE WRAP: 0.03" BLACK, UV-RESISTANT POLYETHYLENE MATERIAL

#### *MISCELLANEOUS*

- CLEAT: 8" STANDARD MOUNT CLEAT, STAINLESS STEEL
- SAFETY LADDERS: 7 STEP RETRACTABLE WITH 2" STEP WIDTH, ALUMINUM
- PILE CAPS: BLACK, CONICAL SHAPED, PVC MATERIAL
- SECURITY GATE: 6 FT. HEIGHT W/ GATE LOCK. HOT DIP GALVANIZED STEEL W/ BLACK POWDER COAT FINISH. PROVIDE ORNAMENTAL GATE POSTS WITH MATCHING MATERIAL AND BLACK POWDER COAT FINISH TO GATE. DURAGATE DGT-GGFW FLAT TOP GARDEN GATE OR EQUAL.

REVISIONS DATE BY DATE 60% SUBMITTAL NOT FOR CONSTRUCTION

DAVID R. JOHNSON, P.E. 15310 AMBERLY DRIVE, SUITE 200 BCS 01-24 DRJ 01-2



TWA NO. GENERAL NOTES (1 OF 2) SHEET NO. SAFETY HARBOR MARINA REPLACEMENT S - 0.3

P:\Projects22\22-00709.001 Marina Basin - Dock Repair\ CADD\struct\B1 GeneralNotes01.dgr

P.E. NO.: 79354

TAMPA, FL 33647

DRMP, INC.

- 1. ALL MEMBERS SHALL BE AIR DRIED TO LESS THAN 19% MOISTURE CONTENT, GRADED IN ACCORDANCE WITH THE SPIB GRADE RULES, SECTION 4, AND MAY HAVE ANY OR ALL OF THE CHARACTERISTICS OF THIS GRADE.
- ALL DECKING SHALL BE CONTINUOUS UNLESS OTHERWISE NOTED IN THE PLANS.
- ALL BOLT HOLES THROUGH TIMBERS TO BE AN EXTRA 1/16" IN DIAMETER RELATIVE TO THE BOLT DIAMETER.
- MEMBERS WITH WANE OF 3/8" OR MORE MAY BE GROUNDS FOR REJECTION, REMOVAL, AND REPLACEMENT.
- INSTALL DECKING PER MANUFACTURER RECOMMENDATIONS.
- TREAT ALL WOOD SURFACES EXPOSED TO VIEW WITH A FINISH & SEAL WATER REPELLENT. COLOR OF REPELLENT SHALL MATCH COLOR OF COMPOSITE DECKING.
- BEAMS, STRINGER, AND RAILS SHALL BE CONTINUOUS OVER SINGLE SPANS UNLESS OTHERWISE NOTED IN THE PLANS
- FIELD PRESERVATIVE CHEMICALS SHALL BE APPLIED TO ALL FIELD CUTS AND DRILLED HOLES TO MAINTAIN TIMBER PRESSURE TREATMENT INTEGRITY.
- PILES SHALL BE PRESSURE PRESERVATIVE TREATED WITH CCA TO 2.5 PCF RETENTION. TIMBER PILES SHALL CONFORM TO ASTM STANDARD D-25 FOR PHYSICAL CHARACTERISTICS AND QUALITY. SIZE SHALL BE 1" TAPER IN 10 LINEAR FEET.
- 10. PILES SHALL FOLLOW SPECIFICATION SECTION 953.
- SAWN LUMBER SHALL BE PRESSURE PRESERVATIVE TREATED WITH ACQ TO 0.6 PCF RETENTION. INSTALL WITH NATURAL CAMBER BOWED UP WHEN POSSIBLE.

#### **FASTENERS**

- 1. ALL CONNECTIONS SHALL BE IN ACCORDANCE WITH FLORIDA BUILDING CODE TABLE 2304.10.1 EXCEPT AS SHOWN OR NOTED BELOW:
  - A) PICKETS TO RAILS TWO, #8x21/2" WOOD SCREWS
  - RAILS TO RAILING POST ONE, 1/4" ⊘ THRU-BOLT
  - RAIL CAP TO RAILING POST FOUR, #10x3" WOOD SCREWS
  - BLOCKING TO STRINGERS FOUR, #10x3" WOOD SCREWS, TOE-NAILED
  - DECK BOARDS TO STRINGERS THREE, #10x3" WOOD SCREWS PER SUPPORT, FACE SCREWED
- WOOD SCREWS SHALL BE STAINLESS STEEL AND IN ACCORDANCE WITH ANSI/ASME STANDARD B18.6.1.
- BOLTS SHALL BE IN ACCORDANCE WITH ANSI/ASME STANDARD B18.2.1.
- PRE-DRILL ALL CONNECTIONS WITH WOOD SCREWS TO AVOID SPLITTING OF THE CONNECTED MEMBERS.
- ALL THRU-BOLTS EXPOSED TO HUMAN CONTACT SHALL BE CUT OFF AND GROUND SMOOTH, FLUSH WITH THE NUT.
- "O-GEE" WASHERS SHALL BE USED FOR ALL TIMBER SIDE CONNECTOR SIZES EQUAL TO OR GREATER THAN 1/2" ∅.
- HURRICANE ANCHOR SHALL BE ATTACHED WITH NAILS (8D). WHENEVER POSSIBLE ALL ANCHORS SHALL BE PLACED IN THE LEAST VISIBLE MANNER TO THE PUBLIC.
- 9/32" O HOLE SHALL BE DRILLED PRIOR TO LAG SCREW INSTALLATION.
- ALL THROUGH NAILS SHALL BE BENT ON PROTRUDING SIDE.
- INSTALL ADHESIVE ANCHORS PER MANUFACTURER'S RECOMMENDATIONS AND SPECIFICATIONS SECTION 416 FOR HOLE DIAMETER AND CLEANING TECHNIQUE.

#### **ENVIRONMENTAL COMMITMENTS**

- USE A RAMP-UP PROCEDURE DURING THE INSTALLATION OF PILES. THIS PROCEDURE ALLOWS FOR A GRADUAL INCREASE IN NOISE LEVELS IN ORDER TO GIVE SENSITIVE SPECIES AMPLE TIME TO FLEE PRIOR TO INITIATION OF FULL NOISE LEVELS. THIS APPROACH CAN ALSO REDUCE THE LIKELIHOOD OF ANY SECONDARY OR SUB-LETHAL EFFECTS FROM SOUND IMPULSES ASSOCIATED WITH PILE DRIVING.
- COMPLY WITH NOAA PROTECTED SPECIES CONSTRUCTION CONDITIONS DURING CONSTRUCTION.
- COMPLY WITH THE FOLLOWING PROTECTED SPECIES CONSTRUCTION CONDITIONS REGARDING SEA TURTLES AND SMALLTOOTH SAWFISH:
  - INSTRUCT ALL PERSONNEL ASSOCIATED WITH THE PROJECT OF THE POTENTIAL PRESENCE OF THESE SPECIES AND THE NEED TO AVOID COLLISIONS WITH SEA TURTLES AND SMALLTOOTH SAWFISH. ALL CONSTRUCTION PERSONNEL ARE RESPONSIBLE FOR OBSERVING WATER-RELATED ACTIVITIES FOR THE PRESENCE OF THESE SPECIES.
  - ADVISE ALL CONSTRUCTION PERSONNEL THAT THERE ARE CIVIL AND CRIMINAL PENALTIES FOR HARMING, HARASSING, OR KILLING SEA TURTLES AND SMALLTOOTH SAWFISH, WHICH ARE PROTECTED UNDER THE ENDANGERED SPECIES ACT OF 1973.

#### ENVIRONMENTAL COMMITMENTS (CONT'D.)

- SILTATION BARRIERS SHALL BE MADE OF MATERIAL IN WHICH SEA TURTLES OR SMALLTOOTH SAWFISH CANNOT BECOME ENTANGLED, SHALL BE PROPERLY SECURED, AND SHALL BE REGULARLY MONITORED TO AVOID PROTECTED SPECIES ENTRAPMENT. BARRIERS MAY NOT BLOCK SEA TURTLE OR SMALLTOOTH SAWFISH ENTRY TO OR EXIT FROM DESIGNATED CRITICAL HABITAT WITHOUT PRIOR AGREEMENT FROM THE NATIONAL MARINE FISHERIES SERVICE'S PROTECTED RESOURCES DIVISION, ST. PETERSBURG, FLORIDA.
- ALL VESSELS ASSOCIATED WITH THE CONSTRUCTION PROJECT SHALL OPERATE AT "NO WAKE/IDLE" SPEEDS AT ALL TIMES WHILE IN THE CONSTRUCTION AREA AND WHILE IN WATER DEPTHS WHERE THE DRAFT OF THE VESSEL PROVIDES LESS THAN A FOUR-FOOT CLEARANCE FROM THE BOTTOM. ALL VESSELS WILL PREFERENTIALLY FOLLOW DEEP-WATER ROUTES (E.G., MARKED CHANNELS) WHENEVER POSSIBLE.
- IF A SEA TURTLE OR SMALLTOOTH SAWFISH IS SEEN WITHIN 100 YARDS OF THE ACTIVE DAILY CONSTRUCTION OPERATION OR VESSEL MOVEMENT, ALL APPROPRIATE PRECAUTIONS SHALL BE IMPLEMENTED TO ENSURE ITS PROTECTION. THESE PRECAUTIONS SHALL INCLUDE CESSATION OF OPERATION OF ANY MOVING EQUIPMENT CLOSER THAN 50 FEET OF A SEA TURTLE OR SMALLTOOTH SAWFISH. OPERATION OF ANY MECHANICAL CONSTRUCTION EQUIPMENT SHALL CEASE IMMEDIATELY IF A SEA TURTLE OF SMALLTOOTH SAWFISH IS SEEN WITHIN A 50-FT. RADIUS OF THE EQUIPMENT. ACTIVITIES MAY NOT RESUME UNTIL THE PROTECTED SPECIES HAS DEPARTED THE PROJECT AREA OF ITS OWN VOLITION.
- ANY COLLISION WITH AND/OR INJURY TO A SEA TURTLE OR SMALLTOOTH SAWFISH SHALL BE REPORTED IMMEDIATELY TO THE NATIONAL MARINE FISHERIES SERVICES PROTECTED RESOURCES DIVISION (727-824-5312) AND THE LOCAL AUTHORIZED SEA TURTLE STRANDING/RESCUE ORGANIZATION.
- 4. THE PERMITTEE SHALL COMPLY WITH THE FOLLOWING CONDITIONS INTENDED TO PROTECT MANATEES FROM DIRECT PROJECT EFFECTS:
  - A) INSTRUCT ALL PERSONNEL ASSOCIATED WITH THE PROJECT OF THE POTENTIAL PRESENCE OF MANATEES AND MANATEE SPEED ZONES, AND THE NEED TO AVOID COLLISIONS WITH AND INJURY TO MANATEES. ADVISE ALL CONSTRUCTION PERSONNEL THAT THERE ARE CIVIL AND CRIMINAL PENALTIES FOR HARMING, HARASSING, OR KILLING MANATEES, WHICH ARE PROTECTED UNDER THE MARINE MAMMAL PROTECTION ACT, THE ENDANGERED SPECIES ACT, AND THE FLORIDA MANATEE SANCTUARY ACT.
  - ALL VESSELS ASSOCIATED WITH THE CONSTRUCTION PROJECT SHALL OPERATE AT "IDLE SPEED/NO WAKE" AT ALL TIMES WHILE IN THE IMMEDIATE AREA AND WHILE IN WATER WHERE THE DRAFT OF THE VESSEL PROVIDES LESS THAN A FOUR-FOOT CLEARANCE FROM THE BOTTOM. ALL VESSELS WILL FOLLOW ROUTES OF DEEP WATER WHENEVER POSSIBLE.
  - SILTATION BARRIERS SHALL BE MADE OF MATERIAL IN WHICH MANATEES CANNOT BECOME ENTANGLED, SHALL BE PROPERLY SECURED, AND SHALL BE REGULARLY MONITORED TO AVOID PROTECTED SPECIES ENTRAPMENT. BARRIERS MUST NOT IMPEDE MANATEE MOVEMENT.
  - ALL ON-SITE PROJECT PERSONNEL ARE RESPONSIBLE FOR OBSERVING WATER-RELATED ACTIVITIES FOR THE PRESENCE OF MANATEE(S). ALL IN-WATER OPERATIONS, INCLUDING VESSELS, MUST BE SHUTDOWN IF A MANATEE(S) COMES WITHIN 50 FEET OF THE OPERATION. ACTIVITIES WILL NOT RESUME UNTIL THE MANATEE(S) HAS MOVED BEYOND THE 50-FOOT RADIUS OF THE PROJECT OPERATION, OR UNTIL 30 MINUTES ELAPSES IF THE MANATEE(S) HAS NOT REAPPEARED WITHIN 50 FEET OF THE OPERATION. ANIMALS MUST NOT BE HERDED AWAY OR HARASSED INTO LEAVING.
  - ANY COLLISION WITH OR INJURY TO A MANATEE SHALL BE REPORTED IMMEDIATELY TO THE FLORIDA FISH AND WILDLIFE CONSERVATION COMMISSION (FWC) HOTLINE AT 1-888-404-3922. COLLISION AND/OR INJURY SHOULD ALSO BE REPORTED TO THE U.S. FISH AND WILDLIFE SERVICE IN JACKSONVILLE (1-904-731-3336) FOR NORTH FLORIDA OR IN VERO BEACH (1-722-562-3909) FOR SOUTH FLORIDA, AND EMAILED TO FWC AT IMPERILEDSPECIES@MYFWC.COM.
  - TEMPORARY SIGNS CONCERNING MANATEES SHALL BE POSTED PRIOR TO AND DURING ALL IN-WATER PROJECT ACTIVITIES. ALL SIGNS ARE TO BE REMOVED UPON COMPLETION OF THE PROJECT. TEMPORARY SIGNS THAT HAVE ALREADY BEEN APPROVED FOR THIS USE BY THE FWC MUST BE USED. ONE SIGN WHICH READ "CAUTION: BOATERS" MUST BE POSTED. A SECOND SIGN MEASURING AT LEAST 81/2" BY 11" EXPLAINING THE REQUIREMENTS FOR "IDLE SPEED/NO WAKE" AND THE SHUT DOWN OF IN-WATER OPERATIONS MUST BE POSTED IN A LOCATION PROMINENTLY VISIBLE TO ALL PERSONNEL ENGAGED IN WATER-RELATED ACTIVITIES. THESE SIGNS CAN BE VIEWED AT HTTP://WWW.MYFWC.COM/WILDLIFEHABITATS/MANATEE SIGN VENDORS.HTM. QUESTIONS CONCERNING THESE SIGNS CAN BE FORWARDED TO THE EMAIL ADDRESS LISTED ABOVE.

REVISIONS DATE BY DESCRIPTION DATE 60% SUBMITTAL NOT FOR CONSTRUCTION

15310 AMBERLY DRIVE, SUITE 200

DAVID R. JOHNSON, P.E.

P.E. NO.: 79354

TAMPA, FL 33647

DRMP, INC.

BCS 01-24 SAFETY DRJ 01-2 HARBOR DRJ 01-24

SAFETY HARBOR MARINA REPLACEMENT

GENERAL NOTES (2 OF 2)

SHEET NO.

TWA NO.

5-04

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	BID ITEMS FOR SAFETY HARBOR MARINA REPLACEI	MENI	
ITEM NO.	DESCRIPTION	UNIT	QUANTITY
	CIVIL	-	1
101-1	MOBILIZATION	LS	1
102-1	MAINTENANCE OF TRAFFIC	LS	1
104-10	SEDIMENT BARRIER	LF	130
104-11	FLOATING TURBIDITY BARRIER	LF	260
110-1-1	CLEARING & GRUBBING	LS	1
110-82	REMOVE & DISPOSE OF STRUCTURAL TIMBER	MB	44.5
350-5	CLEANING & SEALING JOINT - CONCRETE PAVEMENT	LF	30
515-2311	PEDESTRIAN / BICYCLE RAILING, ALUMINUM ONLY, 42" TYPE 1	LF	21
550-10-220	FENCING, TYPE B, 5.1'-6.0', STANDARD	LF	130
550-60-222	FENCE GATE, TYPE B, DOUBLE 6.1'-12.0' OPENING	EA	1
700-1-11	SINGLE POST SIGN, F&I GROUND MOUNT, UP TO 12SF	EA	4
700-1-50	SINGLE POST SIGN, RELOCATE	EA	1
999-90	SECURITY GATE, 6FT.	EA	1
999-91	CLEATS	EA	53
999-92	SAFETY LADDER	EA	21
	STRUCTURES	I .	
470-1	TREATED STRUCTURAL TIMBER	MB	8.8
999-93	TREATED TIMBER PILING (8 IN. DIAMETER)	LF	5,610
999-94	TREATED TIMBER PILING (10 IN. DIAMETER)	LF	1,239
999-95	PILE WRAPS	EA	283
999-96	PILE CAP	EA	227
999-97	COMPOSITE DECKING (ALTERNATIVE 1)	SF	4,696
470-1	TIMBER DECKING (ALTERNATIVE 2)	MB	7.0

#### BID ITEM NOTES


- 1. POST-INSTALLED ANCHORS LABOR AND MATERIAL IS CONSIDERED INCIDENTAL TO PAY ITEM 470-1, "TREATED STRUCTURAL TIMBER ."
- 2. ALL HARDWARE LABOR AND MATERIAL IS CONSIDERED INCIDENTAL TO PAY ITEM 470-1, "TREATED STRUCTURAL TIMBER." TIMBER BLOCKING IS CONSIDERED INCIDENTAL TO PAY ITEM 470-1, "TREATED STRUCTURAL TIMBER."
- 3. PAYMENT FOR NEOPRENE SHIM IS CONSIDERED INCIDENTAL TO PAY ITEM NO. 470-1, "TREATED STRUCTURAL TIMBER".
- 4. LABOR & MATERIAL FOR INSTALLING SECURITY GATE IS TO BE PAID FOR UNDER PAY ITEM 999-90, "SECURITY GATE, 6 FT.".
- 5. LABOR & MATERIAL FOR INSTALLING CLEATS IS TO BE PAID FOR UNDER PAY ITEM 999-91, "CLEATS".
- 6. LABOR & MATERIAL FOR INSTALLING SAFETY LADDERS IS TO BE PAID FOR UNDER PAY ITEM 999-92, "SAFETY LADDER".
- 7. LABOR & MATERIAL FOR INSTALLING DOCK PILES IS TO BE PAID FOR UNDER PAY ITEMS 999-93, "TREATED TIMBER PILING 8 IN. DIAMETER"
- 8. LABOR & MATERIAL FOR INSTALLING TIE PILES IS TO BE PAID FOR UNDER PAY ITEM 999-94, "TREATED TIMBER PILING 10 IN. DIAMETER".
- 9. LABOR & MATERIAL FOR INSTALLING PILE WRAPS IS TO BE PAID FOR UNDER PAY ITEM 999-95, "PILE WRAPS".
- 10. LABOR & MATERIAL FOR INSTALLING PILE CONICAL CAPS IS TO BE PAID FOR UNDER PAY ITEM 999-96, "PILE CAPS".
- 11. LABOR & MATERIAL FOR INSTALLING COMPOSITE DECKING (ALTERNATIVE 1) IS TO BE PAID FOR UNDER PAY ITEM 999-97, "COMPOSITE DECKING".


		REVIS	SIONS		
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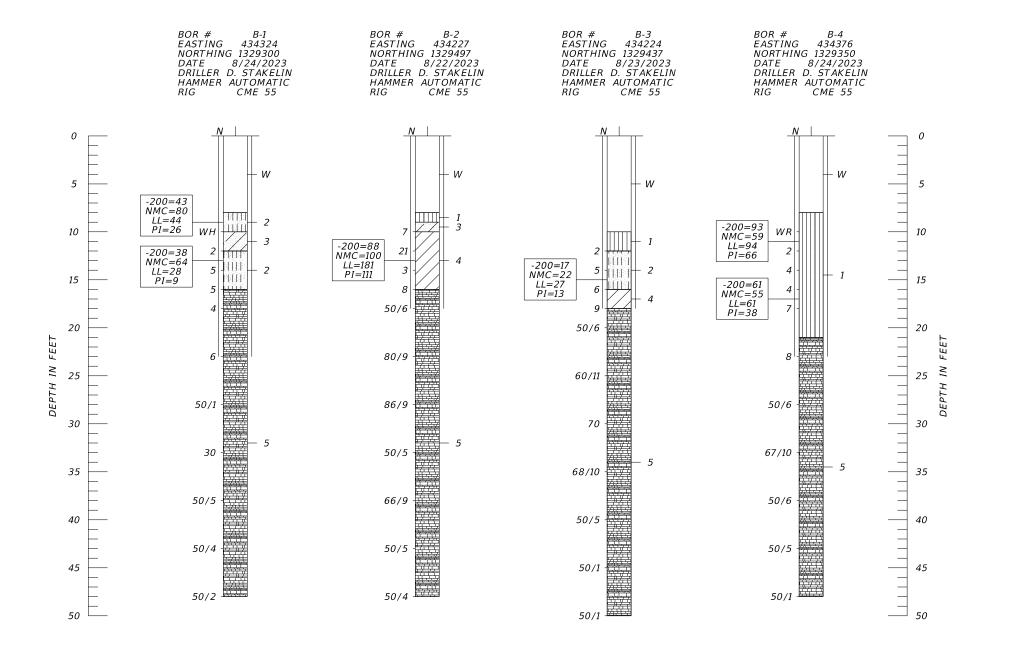
DAVID R. JOHNSON, P.E.
P.E. NO.: 79354
DRMP, INC.
15310 AMBERLY DRIVE, SUITE 200
TAMPA, FL 33647




	SUMMARY OF QUANTITIES						
		SAFETY HARBOR MARINA REPLACEMENT	S-05				



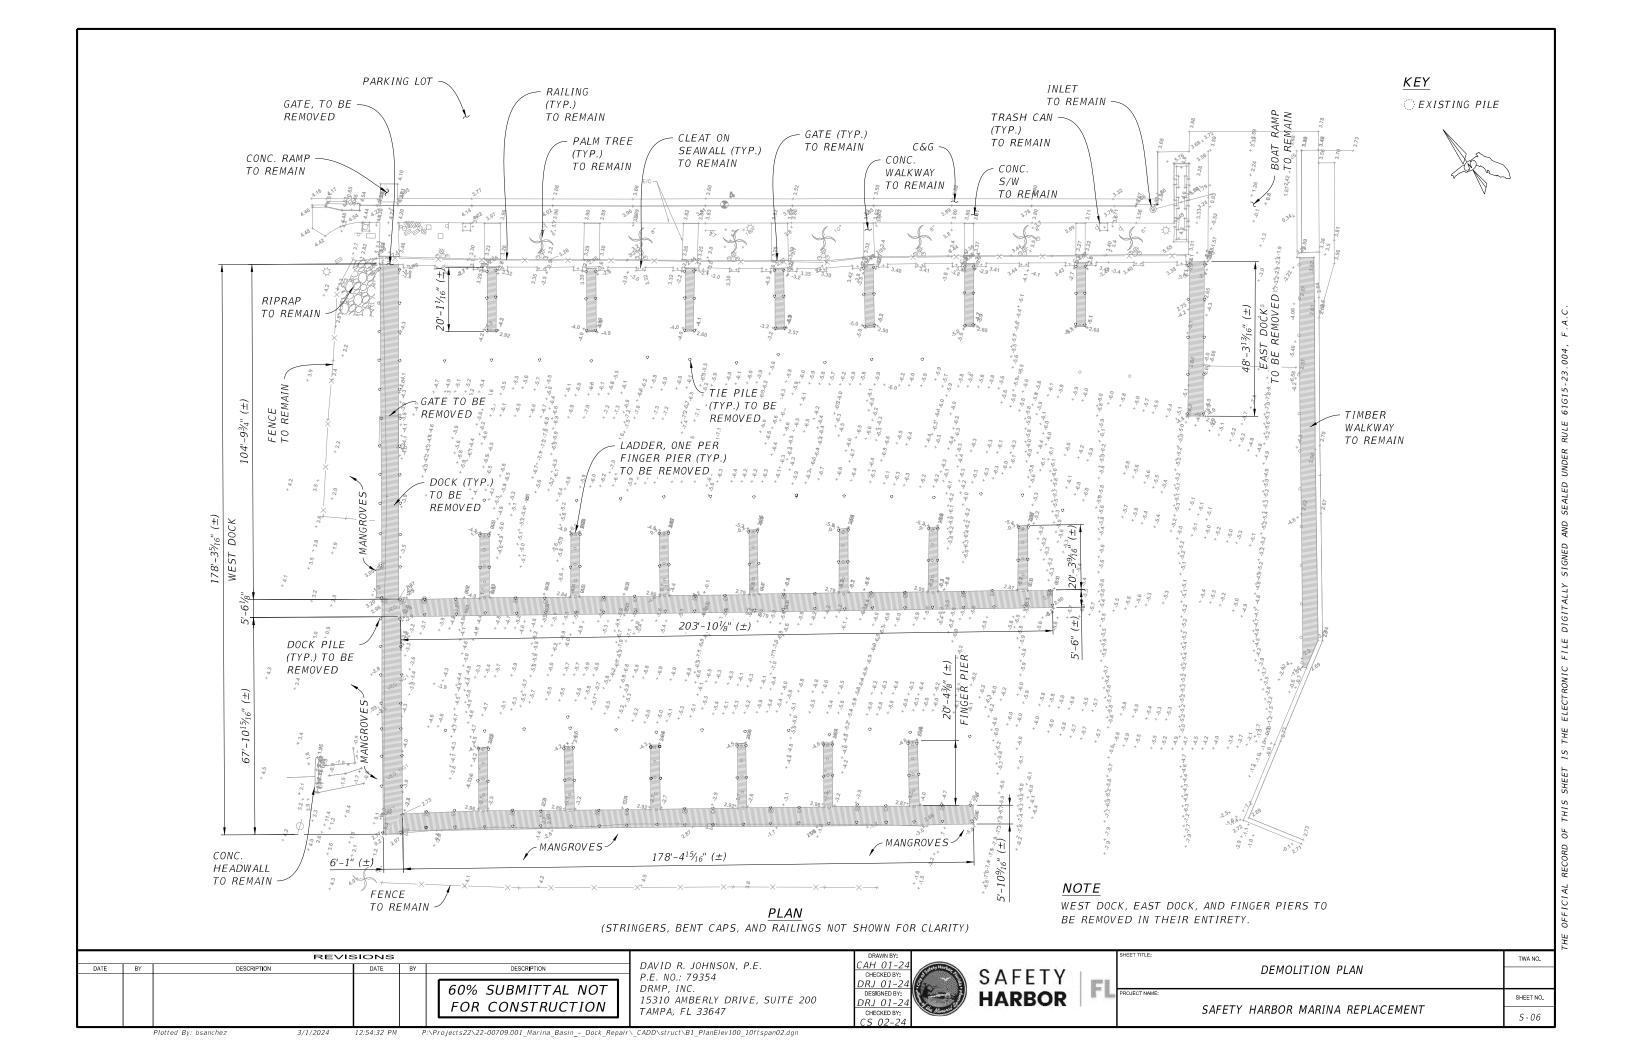

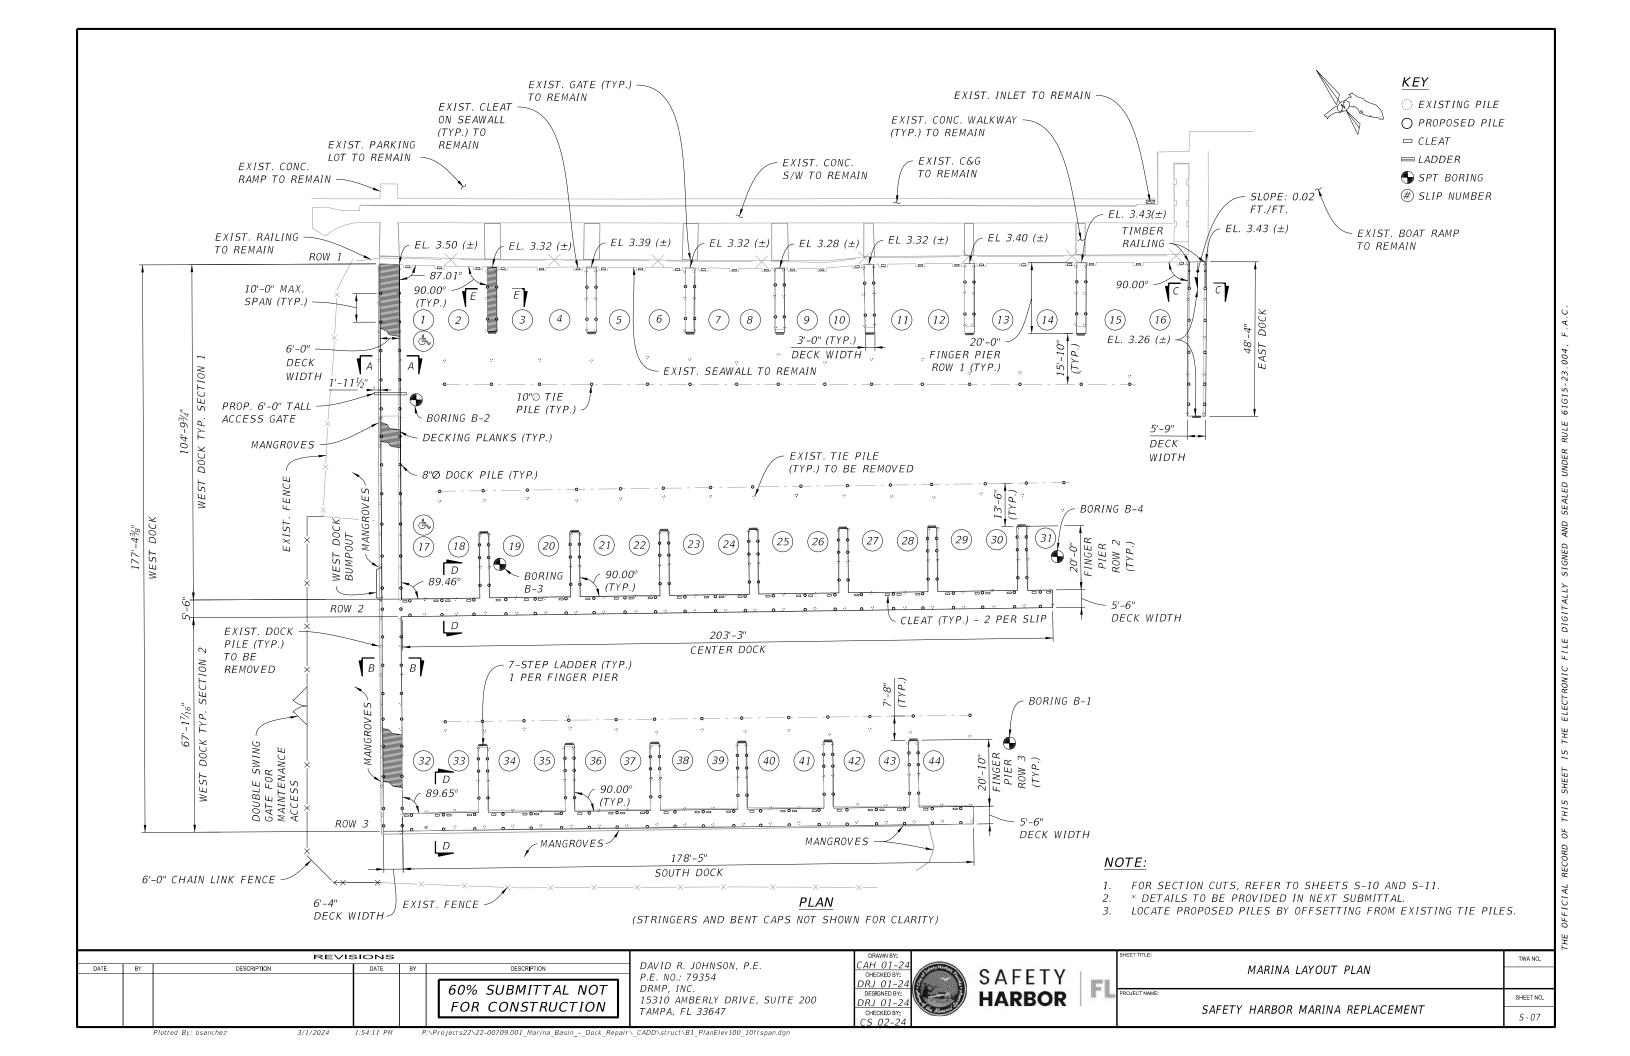


#### *LEGEND*

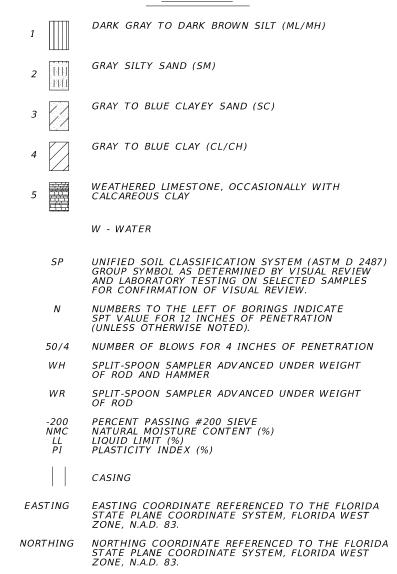

	SAFETY HAMMER	AUTOMATIC HAMMER		
GRANULAR MATERIALS-	SPT N-VALUE	SPT N-VALUE		
RELATIVE DENSITY	(BLOWS/FT.)	(BLOWS/FT.)		
VERY LOOSE	LESS THAN 4	LESS THAN 3		
LOOSE	4 to 10	3 to 8		
MEDIUM DENSE	10 to 30	8 to 24		
DENSE	30 to 50	24 to 40		
VERY DENSE	GREATER THAN 50	GREATER THAN 40		
SILTS AND CLAYS	SPT N-VALUE	SPT N-VALUE		
CONSISTENCY	(BLOWS/FT.)	(BLOWS/FT.)		
VERY SOFT	LESS THAN 2	LESS THAN 1		
SOFT	2 to 4	1 to 3		
FIRM	4 to 8	3 to 6		
STIFF	8 to 15	6 to 12		
VERY STIFF	15 to 30	12 to 24		
HARD	GREATER THAN 30	GREATER THAN 24		

				DANIEL R. RUEL, P.E.	DRAWN BY:			SHEET TITLE:		TWA NO.		
DATE	BY	DESCRIPTION	DATE	BY	DESCRIPTION	P.E. LICENSE NUMBER 82404	BMG 02/24 CHECKED BY: DRR 02/24		SAFETY		SOIL PROFILES	
						TIERRA, INC. 7351 TEMPLE TERRACE HIGHWAY	DESIGNED BY: BMG-02/24		HARBOR	PROJECT NAME:		SHEET NO.
						TAMPA, FLORIDA 33637	CHECKED BY: DRR 02/24	CHECKED BY:			SAFETY HARBOR MARINA REPLACEMENT	S-08
		Plotted By: bsanchez 3/1/2024	4:36:31 PM		P:\Projects22\22-00709.001_Marina_BasinDock_Repai	r\_CADD\geotech\B1Boring01.dgn						

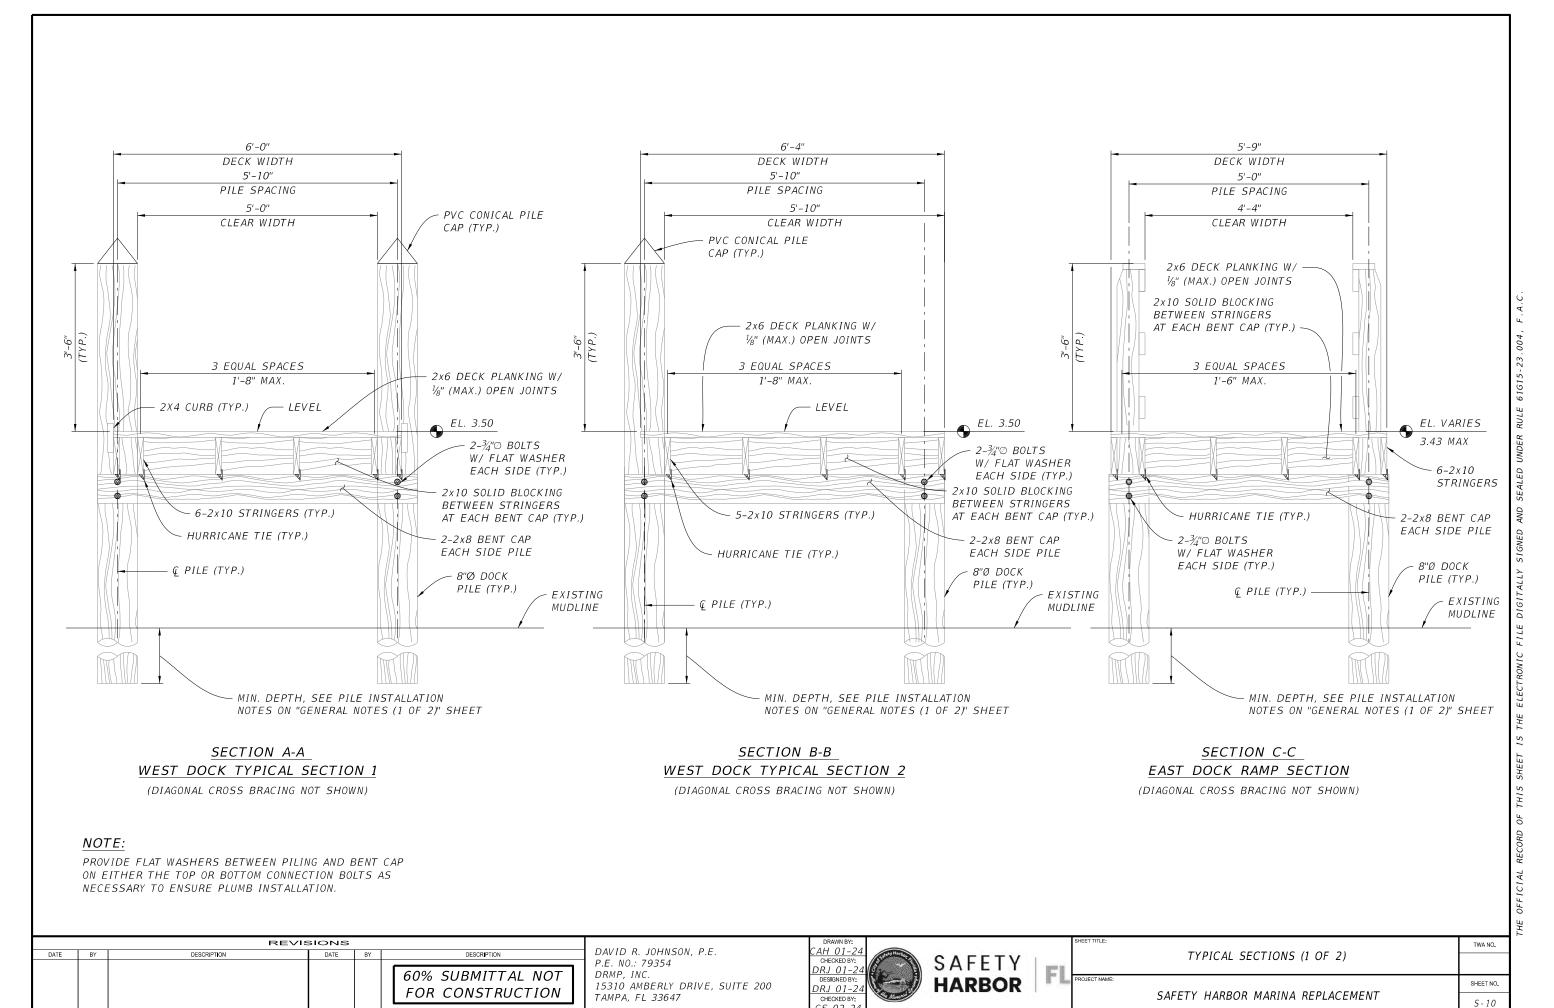

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rojects22\22-00709.001\_Marina\_Basin\_-\_Dock\_Repair\\_CADD\struct\B1\_Sections.dq

- 2x6 DECK PLANKING W/ 1/8" (MAX.) OPEN JOINTS

€L. 3.50

- 2-¾"○ BOLTS

W/ FLAT WASHER EACH SIDE (TYP.)

2x10 SOLID BLOCKING

BETWEEN STRINGERS

EACH SIDE PILE

8"Ø DOCK

MIN. DEPTH, SEE PILE INSTALLATION

NOTES ON "GENERAL NOTES (1 OF 2)" SHEET

PILE (TYP.)

AT EACH BENT CAP (TYP.) 2-2x8 BENT CAP

EXISTING

MUDLINE



SECTION E-E FINGER PIER TYPICAL SECTION

3'-0"

DECK WIDTH

2'-10" PILE SPACING

2'-0"

CLR. WIDTH

LEVEL

3'-6" (TYP.)

4-2x10 STRINGERS (TYP.) -

HURRICANE TIE (TYP.)

& PILE (TYP.) -

2-¾"⊘ B0LTS W/ FLAT WASHER

EACH SIDE (TYP.) -

PVC CONICAL PILE CAP (TYP.)

2x6 DECK PLANKING

EL. VARIES FOR ROW 1

2x10 SOLID BLOCKING

BETWEEN STRINGERS

8"Ø DOCK

PILE (TYP.)

 $W/\frac{1}{8}$ " (MAX.) OPEN JOINTS

EL .3.50 FOR ROW 2 & 3

AT EACH BENT CAP (TYP.)

MIN. DEPTH, SEE PILE INSTALLATION

NOTES ON "GENERAL NOTES (1 OF 2)" SHEET

- 2-2x8 BENT CAP

EACH SIDE PILE

EXISTING

TWA NO.

SHEET NO.

S - 11

MUDLINE

## SECTION D-D CENTER DOCK TYPICAL SECTION

5'-6"

DECK WIDTH

4'-6" PILE SPACING

4'-6"

CLEAR WIDTH

3 EQUAL SPACES 1'-6" MAX.

- LEVEL

— € PILE (TYP.)

(SOUTH DOCK IS SIMILAR) (DIAGONAL CROSS BRACING NOT SHOWN)

#### *NOTE:*

PROVIDE FLAT WASHERS BETWEEN PILING AND BENT CAP ON EITHER THE TOP OR BOTTOM CONNECTION BOLTS AS NECESSARY TO ENSURE PLUMB INSTALLATION.

	REVISIONS												
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DAVID R. JOHNSON, P.E. P.E. NO.: 79354 DRMP, INC. 15310 AMBERLY DRIVE, SUITE 200 TAMPA, FL 33647 CAH 01-24 CHECKED BY: DRJ 01-24 DRJ 01-24





PVC CONICAL PILE CAP -

5-2x10 STRINGERS (TYP.)

HURRICANE TIE (TYP.)

(TYP.)

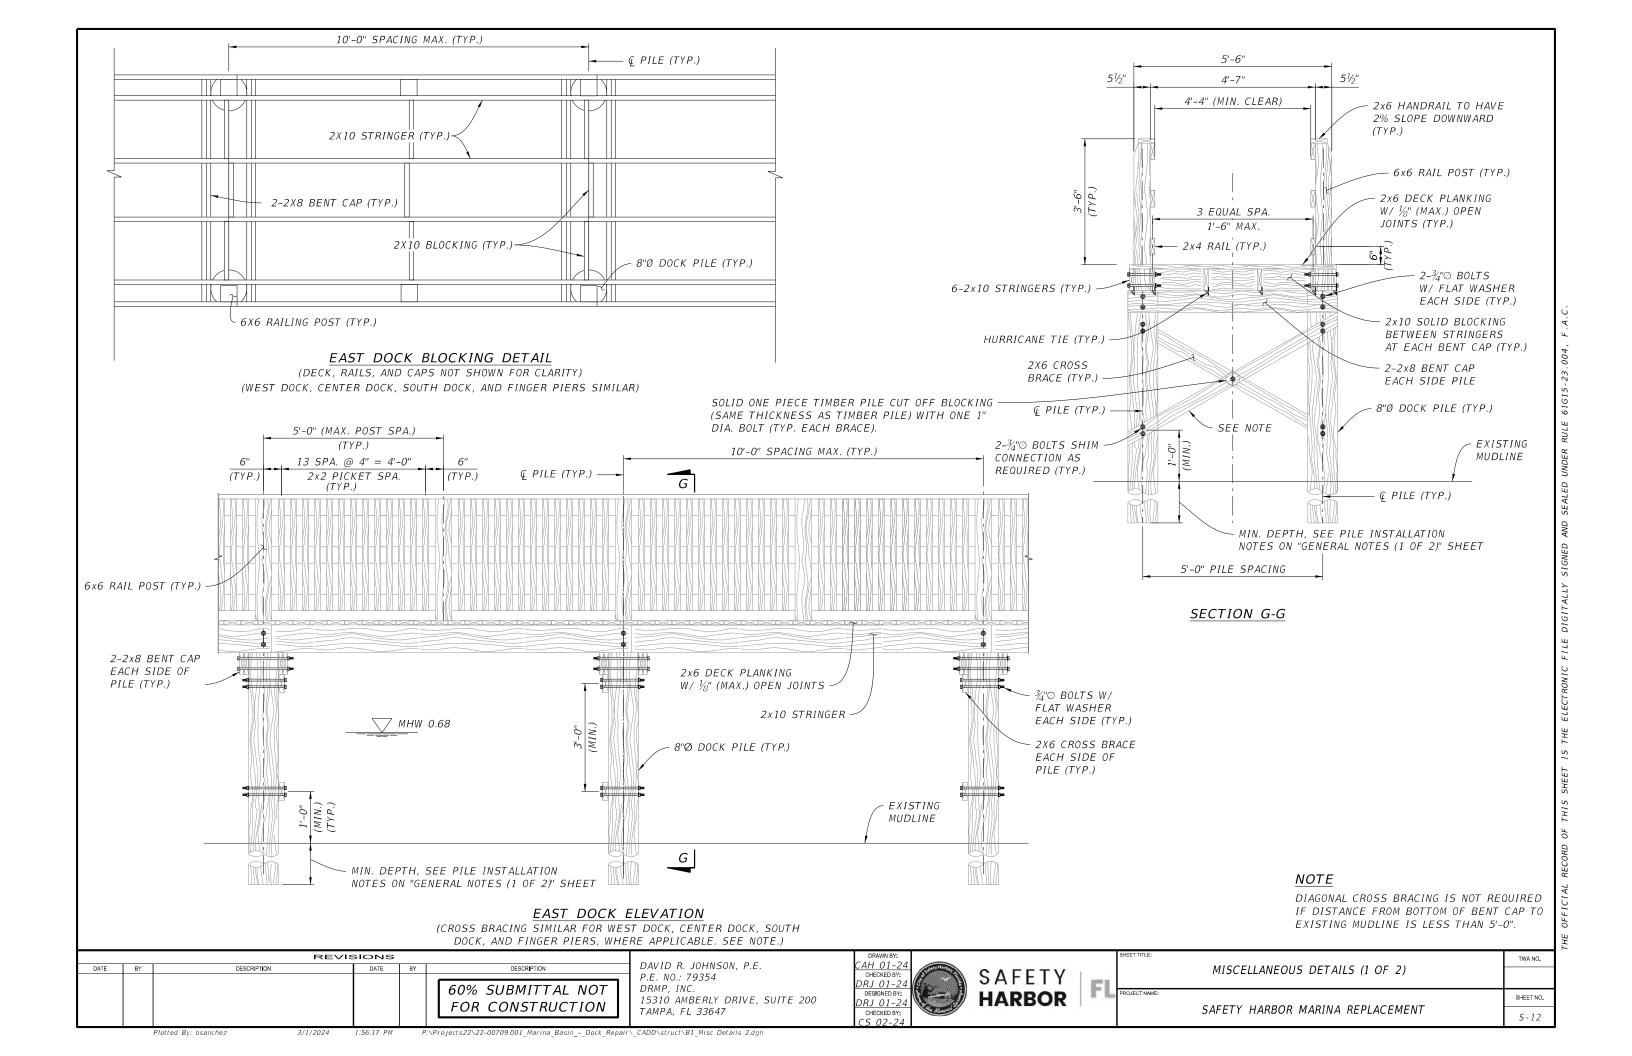

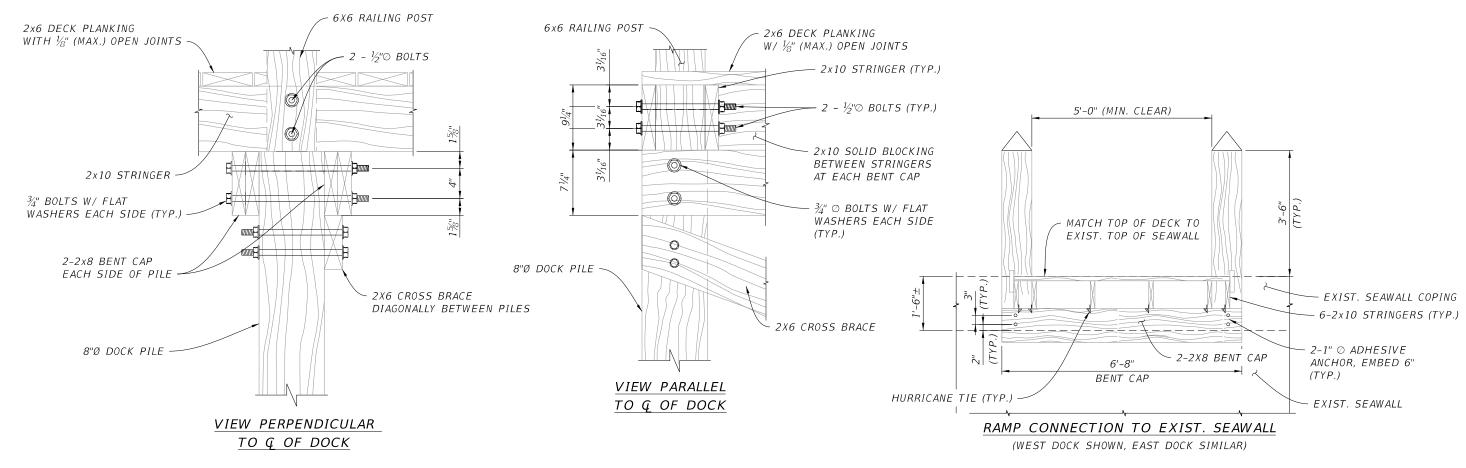

#### HANDRAIL POST / GIRDER CONNECTION DETAILS

NOTE:

PROVIDE FLAT WASHERS BETWEEN THE RAILING POST AND PILING ON EITHER THE TOP OR BOTTOM CONNECTION BOLTS AS NECESSASRY TO ENSURE PLUMB INSTALLATION OF RAILING.

	REVISIONS											
DATE	BY	DESCRIPTION	DATE	BY	DESCRIPTION							
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DAVID R. JOHNSON, P.E. P.E. NO.: 79354 DRMP, INC. 15310 AMBERLY DRIVE, SUITE 200 TAMPA, FL 33647

DRAWN BY:		
CAH 01-24	tesy Hardy	- <u> </u>
CHECKED BY:	(3)	SAFETY
DRJ 01-24		SAILII
DESIGNED BY:	\$ }	HADDOD
DRJ 01-24	(8)	HARBOR
CHECKED BY:	Manager	
CS 02-21		

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an a	PROJECT NAME:	SHEET NO.
	SAFETY HARBOR MARINA REPLACEMENT	S - 13

- 2. DURING THE CONSTRUCTION OF STRUCTURES REQUIRING EXCAVATION, THE CONTRACTOR SHALL PLACE APPROVED BARRIERS OR OTHER APPROVED DEVICES AROUND SUCH STRUCTURES TO PREVENT EROSION AND THE MIGRATION OF SEDIMENT TO POINTS OUTSIDE THE CONSTRUCTION AREA. THE APPROVED BARRIERS OR OTHER APPROVED DEVICES SHALL BE PLACED IN ACCORDANCE WITH REQUIREMENTS OF FLORIDA STORM WATER EROSION AND SEDIMENTATION CONTROL INSPECTOR'S MANUAL, 2018, STATE OF FLORIDA EROSION AND SEDIMENT CONTROL DESIGNER AND REVIEWER MANUAL, LATEST EDITION OR AS DIRECTED BY THE ENGINEER.
- 3. REQUIRED EROSION CONTROL MEASURES MUST REMAIN INTACT THROUGHOUT CONSTRUCTION. FAILURE TO INSTALL OR PROPERLY MAINTAIN REQUIRED EROSION CONTROL WILL RESULT IN ENFORCEMENT ACTION. ALL EROSION CONTROL MEASURES, SAND, SILT, AND DEBRIS SHALL BE REMOVED FROM ALL STRUCTURES AFTER CONSTRUCTION HAS BEEN COMPLETED AND PRIOR TO CITY FINAL WALK-THROUGH.
- 4. THE CONTRACTOR SHALL PROVIDE AND MAINTAIN SILT/TURBIDITY BARRIERS TO CONTROL EROSION AND SEDIMENT FROM TAKING PLACE OUTSIDE THE PROJECT LIMITS. THE SILT/TURBIDITY BARRIERS SHALL BE PLACED IN ACCORDANCE WITH REQUIREMENTS OF FLORIDA STORMWATER EROSION AND SEDIMENTATION CONTROL INSPECTOR'S MANUAL, 2018, STATE OF FLORIDA EROSION AND SEDIMENT CONTROL DESIGNER AND REVIEWER MANUAL, LATEST EDITION, THROUGHOUT THE DURATION OF THE PROJECT AND ALL ASPECTS OF CONSTRUCTION. ALL DAMAGED OR INEFFECTIVE EROSION CONTROL DEVICES SHALL BE REPLACED AT NO ADDITIONAL COST TO THE CITY.
- 5. EROSION CONTROL PLAN ANY MODIFICATIONS TO THIS PLAN MUST BE SIGNED AND SEALED BY A PROFESSIONAL ENGINEER REPRESENTING THE CONTRACTOR. THESE MODIFICATIONS MUST BE APPROVED BY THE CITY AND THE PERMITTING AGENCY. NO CONTRACT DELAYS WILL BE ALLOWED FOR SUCH MODIFICATIONS OR APPROVALS.
- 6. APPROVED BARRIERS (OR OTHER APPROVED SEDIMENT CONTROL DEVICES) THESE SHALL BE PLACED AT THE BASE OF ANY SLOPE WHERE A RAINFALL EVENT COULD ERODE A SLOPE AND TRANSPORT SEDIMENTS OFF-SITE. APPROVED BARRIERS SHALL BE DOUBLE STAKED IN ACCORDANCE WITH FLORIDA STORMWATER EROSION AND SEDIMENTATION CONTROL INSPECTOR'S MANUAL, 2018, AND STATE OF FLORIDA EROSION AND SEDIMENT CONTROL DESIGNER AND REVIEWER MANUAL, LATEST EDITION. ANY DAMAGED OR INEFFECTIVE APPROVED BARRIERS ARE TO BE REPLACED WITH NEW ONES. THE LOCATION AND INSTALLATION OF APPROVED BARRIERS SHALL BE AS DIRECTED BY THE PROJECT ENGINEER.
- 7. STOCKPILED MATERIALS SHALL BE PROTECTED BY COVER, APPROVED BARRIERS OR OTHER APPROVED SEDIMENT CONTROL DEVICES.
- 8. ALL DISTURBED AREAS SHALL BE STABILIZED WITHIN 3 DAYS AFTER 1/2" RAIN EVENT DISTURBANCE.

- 9. IF WIND EROSION BECOMES SIGNIFICANT DURING CONSTRUCTION, THE CONTRACTOR SHALL STABILIZE THE AFFECTED AREA USING SPRINKLING, IRRIGATION, OR OTHER ACCEPTABLE METHODS.
- 10. THE EROSION CONTROL DEVICE QUANTITIES SHOWN ON THE BID FORMS ARE ESTIMATES OF THE ACTUAL QUANTITIES THAT MAY BE ENCOUNTERED DURING CONSTRUCTION. IT IS THE RESPONSIBILITY OF THE CONTRACTOR TO SPECIFY ACTUAL QUANTITIES AND COSTS ASSOCIATED WITH THIS SPECIFIC EROSION CONTROL IMPLEMENTATION SCHEDULE. EROSION CONTROL ITEMS MAY BE ADDED OR DELETED FROM THE PAY ITEM LIST AS THE EROSION CONTROL IMPLEMENTATION SCHEDULE PROVIDED BY THE CONTRACTOR IS MODIFIED TO MEET SITE SPECIFIC CONDITIONS.
- 11. ALL EROSION CONTROL FENCES. BARRIERS, AND SILTATION DEVICES SHALL BE ERECTED PRIOR TO ANY LAND ALTERATIONS, SHALL BE MAINTAINED IN GOOD WORKING ORDER DURING CONSTRUCTION, AND REMOVED FOLLOWING SOIL STABILIZATION AND FINAL DRESSING. STOCKPILE AREAS SHALL INCLUDE SILT FENCING AROUND THE PERIMETER.
- 12. THE CONTRACTOR SHALL NOT RESTRICT OR BLOCK THE EXISTING DRAINAGE FLOW OVERLAND OR WITHIN RESHAPED SWALES. FLOW WITHIN EXISTING DRAINAGE PIPES SHALL BE MAINTAINED AT ALL TIMES. STORM WATER WILL BE CONVEYED VIA EXISTING SWALES, DITCHES, OR PROPOSED DITCHES, EXISTING AND PROPOSED STORM SEWERS.
- 13. THERE IS TO BE NO DISCHARGE (I.E. PUMPING, SHEET FLOW, SWALE, DITCH, ETC.) INTO EXISTING DITCHES OR CANALS WITHOUT THE USE OF SETTLING PONDS. IF THE CONTRACTOR DESIRES TO DISCHARGE INTO EXISTING DITCHES OR CANALS A SETTLING POND PLAN PREPARED BY THE CONTRACTOR MUST BE SUBMITTED TO AND APPROVED BY THE ENGINEER OF RECORD AND LOCAL REGULATORY AGENCY PRIOR TO CONSTRUCTION.

REVISIONS DATE BY DESCRIPTION DATE DESCRIPTION 60% SUBMITTAL NOT FOR CONSTRUCTION


DAVID R. JOHNSON, P.E. P.E. NO.: 79354 DRMP, INC. 15310 AMBERLY DRIVE, SUITE 200 TAMPA, FL 33647

BCS 01-2 SAFETY DRJ 01-2 HARBOR

SAFETY HARBOR MARINA REPLACEMENT


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	LEGEND												
SYMBOL	DESCRIPTION	MOUNTING/REMARKS	SYME	BOL	DE:	SCRIPTION	N	MOUNTING/REMARKS					
	LIGHTING CABINET: DENOTED BY LABEL	SURFACE, TOP 78" AFF OR AS REQUIRED BY MANUFACTURER		MATIONS:									
	DEVICE AS NOTED	AS NOTED	A A/E AF	AMPS OR AMPERE ARCHITECT/ENGINEER AMPERE FRAME	FC FL/ FO		NEMA	NATIONAL ELECTRICAL CODE NATIONAL ELECTRICAL MANUFACTURERS					
	BRANCH CIRCUIT PANELBOARD: 240 VAC	TOP 78" AFF	AFCI	ARC-FAULT CIRCUIT INTERRUPTER	FT GC	FOOT (FEET) GENERAL CONTRACTOR	NFPA	ASSOCIATION NATIONAL FIRE PROTECTION					
	CIRCUIT BREAKER	TOP 78" AFF	AFF AFG	ABOVE FINISHED FLOOR ABOVE FINISHED GRADE		CI GROUND-FAULT CIRCUIT	NO	ASSOCIATION NORMALLY OPEN NOT TO SCALE					
	ELECTRICAL EQUIPMENT: DENOTED BY LABEL	AS NOTED	AHJ	AUTHORITY HAVING JURISDICTION AMPERE INTERRUPTING	GN HO		OB P	OUTLET BOX POLE					
凸	ELECTRIC UTILITY METER/CABINET	AS REQUIRED BY UTILITY COMPANY	AL	CAPACITY ALUMINUM	HP HP	HORSEPOWER S HIGH PRESSURE SODIUM	PB	PUBLIC ADDRESS PULL BOX					
$\sim$ $\sim$	CIRCUIT/CONDUIT OR CABLE TURNING UP/RISER	TWO WIRES: *	ANSI ASD	AMERICAN NATIONAL STANDARDS INSTITUTE ADJUSTABLE SPEED DR	HV HZ VE IG	HIGH VOLTAGE HERTZ ISOLATED GROUND	PNL	PHASE PANELBOARD (PANEL) RECEPTACLE					
<b>~</b> > <b>⊸</b>	CIRCUIT/CONDUIT OR CABLE TURNING DOWN/DROP	NEUTRAL WIRE (TYP)	AT	AMPERE TRIP AUTOMATIC TRANSFER	IN JB	INCH (INCHES) JUNCTION BOX	SCC	SHORT CIRCUIT CAPACITY SQUARE FOOT (FEET)					
$\sim$	CIRCUIT HOME RUN TO PANELBOARD INDICATED	PHASE WIRE (TYP)  THREE WIRES, ETC.	AUTO	SWITCH AUTOMATIC	kcr kV	mil THOUSAND CIRCULAR MIL KILOVOLT	SPEC SPD SS SWBD SWGR TR TYP U UL UON UPS	SPECIFICATION SURGE PROTECTIVE DEVICE					
$\sim$	CIRCUIT/CONDUIT FLEXIBLE CONNECTION	EQUIPMENT GROUND WIRE	AWG BLDG BFG	AMERICAN WIRE GAUGE BUILDING BELOW FINISHED GRADE BREAKER CONDUIT CIRCUIT BREAKER CIRCUIT COMMUNICATIONS CURRENT TRANSFORMER COPPER	kV. kW kW	KILOWATT		STAINLESS STEEL SWITCHBOARD SWITCHGEAR					
	CIRCUIT/CONDUIT OR CABLE CONCEALED IN CEILING OR WALL	*MIN 2 #12 + #12 EG - 1/2" C	BRKR C		LEI LP:	D LIGHT EMITTING DIODE		TAMPER RESISTANT TYPICAL					
	CIRCUIT/CONDUIT OR CABLE UNDERGROUND OR UNDER FLOOR	FOR ALL POWER AND LIGHTING RACEWAYS UON OR SPECIFIED	CKT		LTO	SYSTEM G LIGHTING		UNKNOWN CIRCUIT UNDERWRITERS					
'EQUIP'	EQUIPMENT LABEL	REFER TO RESPECTIVE SCHEDULE	СТ		LTi LV MA	LOW VOLTAGE		LABORATORY UNLESS OTHERWISE NOTED UNINTERRUPTIBLE POWER					
PNL-CIR	PANELBOARD-CIRCUIT DESIGNATION	REFER TO PANEL SCHEDULE	*C *F	DEGREES CELSIUS DEGREES FAHRENHEIT	MC MC	A MINIMUM CIRCUIT AMPACITY B MAIN CIRCUIT BREAKER		SUPPLY UTILITY					
<b># #</b>	KEYED NOTES	REFER TO LIKE-NUMBERED NOTES	DP	DISCONNECT DISTRIBUTION PANELBO DISCONNECT SWITCH	ARD MC		VA	VOLT OR VOLTAGE VOLT AMPERE VOLTAGE DROP					
LOCAL C AUTHORI SHALL G THE ARC 1. NFF	M WORK IN COMPLIANCE WITH THE LATEST EDITION OF ALL APPLICATIONS, REGULATIONS AND STANDARDS, TO INCLUDE THOSE LISTE TY HAVING JURISDICTION. WHERE DIFFERENCES MAY OCCUR THE OVERN. IN CASE OF CONFLICT PROVIDE WRITTEN NOTIFICATION ACHITECT/OWNER.  PA 70: NATIONAL ELECTRICAL CODE (2020)  PA 70E: STANDARD FOR ELECTRICAL SAFETY IN THE WORKPLACE	CABLE, FEDERAL, STATE AND  BELOW, ADOPTED BY THE  MORE STRINGENT REQUIREMENTS  ND OBTAIN A DECISION FROM	EC EG ELEC ELEV EMER EPO EPS EXIST	DRAWING ELECTRICAL CONTRACTO EQUIPMENT GROUND ELECTRIC OR ELECTRICA ELEVATOR EMERGENCY EMERGENCY POWER OFF EMERGENCY POWER SUI EXISTING FIRE ALARM	L MIN MC MC	METAL HALIDE  Z MEGAHERTZ  N MINIMUM  O MAIN LUGS ONLY  CP MAXIMUM OVERCURRENT PROTECTION  S MANUAL TRANSFER SWITCH NEUTRAL NOT APPLICABLE	VFD W WP WR WT XFER XFMR	VARIABLE FREQUENCY DRIVE WATT OR WIRE WEATHERPROOF WEATHER RESISTANT WATERTIGHT TRANSFER TRANSFORMER EXPLOSION RATED					
4. NFF OPE 5. FBC	PA 101: LIFE SAFETY CODE (2021) PA 241: STANDARD FOR SAFEGUARDING CONSTRUCTION, ALTERATERATIONS (2022) C: FLORIDA BUILDING CODE (2023) HA PART 1910: OCCUPATIONAL SAFETY AND HEALTH STANDARDS		OBJECT STATE LINETYPES:  EXISTING OBJECT OR CONSTRUCTION:  EXISTING OBJECT OR CONSTRUCTION TO BE DEMOLISHED:  NEW OBJECT OR CONSTRUCTION TO BE PROVIDED:										
	HA PART 1926: SAFETY AND HEALTH REGULATIONS FOR CONSTR	D EX	OBJECT STATE SUBSCRIPTS:  D EXISTING OBJECT TO BE DEMOLISHED   M EXISTING OBJECT TO BE REMOVED & RELOCATED EXISTING OBJECT TO REMAIN   R RELOCATED EXISTING OBJECT										

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SAFETY **HARBOR** AVE CHECKED BY: AVE

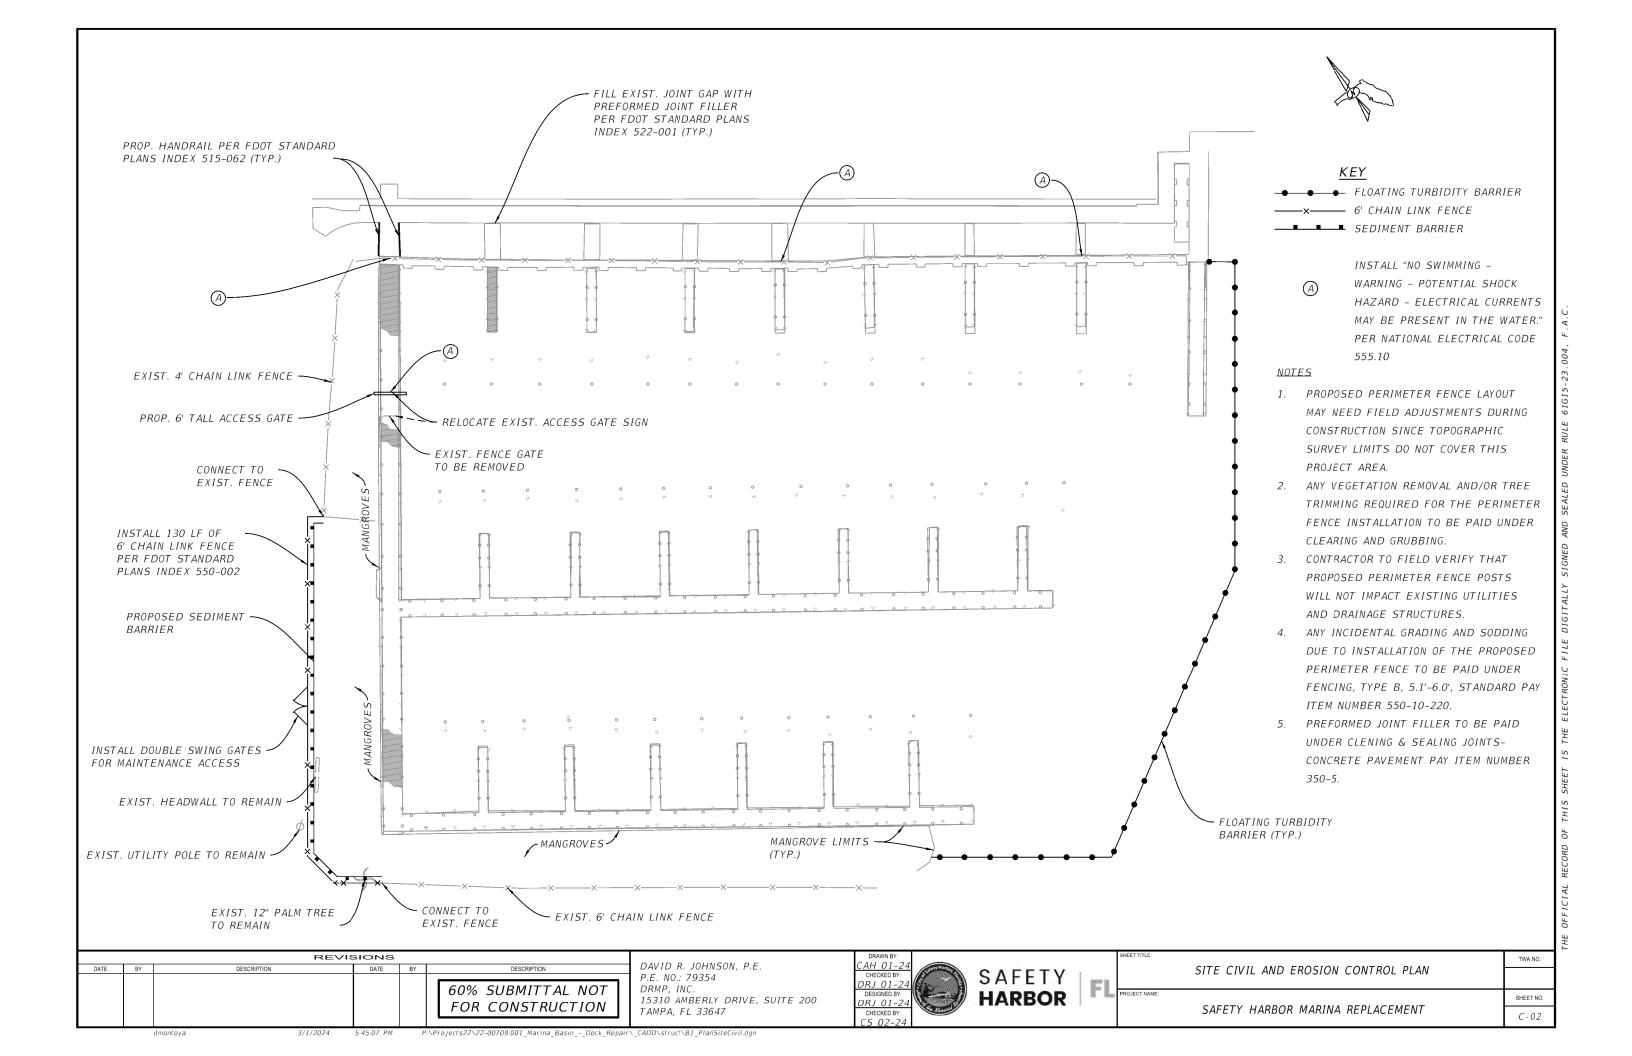ELECTRICAL LEGEND

SHEET NO.

SAFETY HARBOR MARINA REPLACEMENT

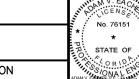E-01

TWA NO.

# # DRAWING NOTES (SHEETS E-03 - E-04)

- 1. EXISTING EQUIPMENT RACK. REFER TO THE POWER ONE-LINE DIAGRAM ON SHEET E-06 FOR ADDITIONAL INFORMATION AND REQUIREMENTS.
- 2. EXISTING PANELBOARD AND ASSOCIATED FEEDER AND BRANCH CIRCUIT CONDUCTORS AND CONDUITS TO BE REMOVED AND REPLACED WITH NEW.
- 3. EXISTING MARINA RECEPTACLE PEDESTAL AND ASSOCIATED DEVICES, CONDUCTORS, AND CONDUITS TO BE REMOVED AND REPLACED WITH NEW.
- 4. EXISTING 240/120 V, 1φ, 3W, 150 A MCB PANELBOARD TO REMAIN.
- 5. EXISTING LIGHTING CONTROL CABINET TO REMAIN.
- 6. ENCLOSED CIRCUIT BREAKER. REFER TO POWER ONE-LINE DIAGRAM FOR ADDITIONAL INFORMATION.
- 7. MARINA PEDESTAL. REFER TO SCHEDULE ON SHEET E-10.

# DRAWING GENERAL NOTES (SHEETS E-03 - E-04)

- A. REFER TO SPECIFICATIONS FOR ADDITIONAL INFORMATION AND REQUIREMENTS.
- B. REFER TO MECHANICAL DRAWINGS FOR ADDITIONAL INFORMATION.
- C. REFER TO CIVIL DRAWINGS FOR ADDITIONAL INFORMATION.
- D. REFER TO POWER ONE-LINE DIAGRAM FOR ADDITIONAL INFORMATION AND REQUIREMENTS.
- E. MAXIMUM 3 QUARTER TURNS (TOTAL 270°) CONDUIT BENDS BETWEEN JUNCTION/PULL BOXES.
- F. MAINTAIN MINIMUM 12" SEPARATION BETWEEN ELECTRICAL AND OTHER UTILITIES/INFRASTRUCTURE.
- G. COORDINATE WITH EXISTING UNDERGROUND UTILITIES AND CONDITIONS. HAND DIG TRENCHES AS REQUIRED.
- H. SAW CUT AND PATCH PAVEMENT AS REQUIRED. COORDINATE WORK WITH OWNER.
- I. ALL CONDUCTORS SHALL BE TYPE XHHW-2.
- J. ALL EXPOSED CONDUITS SHALL BE UV RESISTANT, SCHEDULE 80 PVC.
- K. ALL FASTENERS, ANCHORS, STRAPS, HARDWARE, STRUT-CHANNEL, ETC. SHALL BE STAINLESS STEEL (TYPE 316).
- L. THE ELECTRICAL DATUM PLANE SHALL BE 2 FEET ABOVE THE HIGHEST TIDE LEVEL.
- M. ALL ELECTRICAL EQUIPMENT AND DEVICES SHALL BE LOCATED ABOVE THE ELECTRICAL DATUM PLANE.
- N. ELECTRICAL EQUIPMENT AND DEVICES LOCATED ON THE DOCK SHALL BE MINIMUM 12" ABOVE THE DECK BUT SHALL NOT BE LOCATED BELOW THE ELECTRICAL DATUM PLANE.
- O. CONDUITS ROUTED UNDER THE DOCK SHALL BE SECURELY FASTENED TO THE STRUCTURE MAXIMUM EVERY 6' USING LISTED, 2-HOLE, STAINLESS STEEL (TYPE 316) CONDUIT STRAPS.
- P. PROVIDE SAFETY SIGNS PER NEC 555.10.

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BY DESCRIPTION DATE BY DESCRIPTION SPECIFICATIONS COMPLY WITH THE MINIMUM BUILDING CODES.

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SAFETY HARBOR

FL PROJECT

ELECTRICAL PLAN NOTES

ELECTRICAL TEAN NOTES

SHEET NO. *E-02* 


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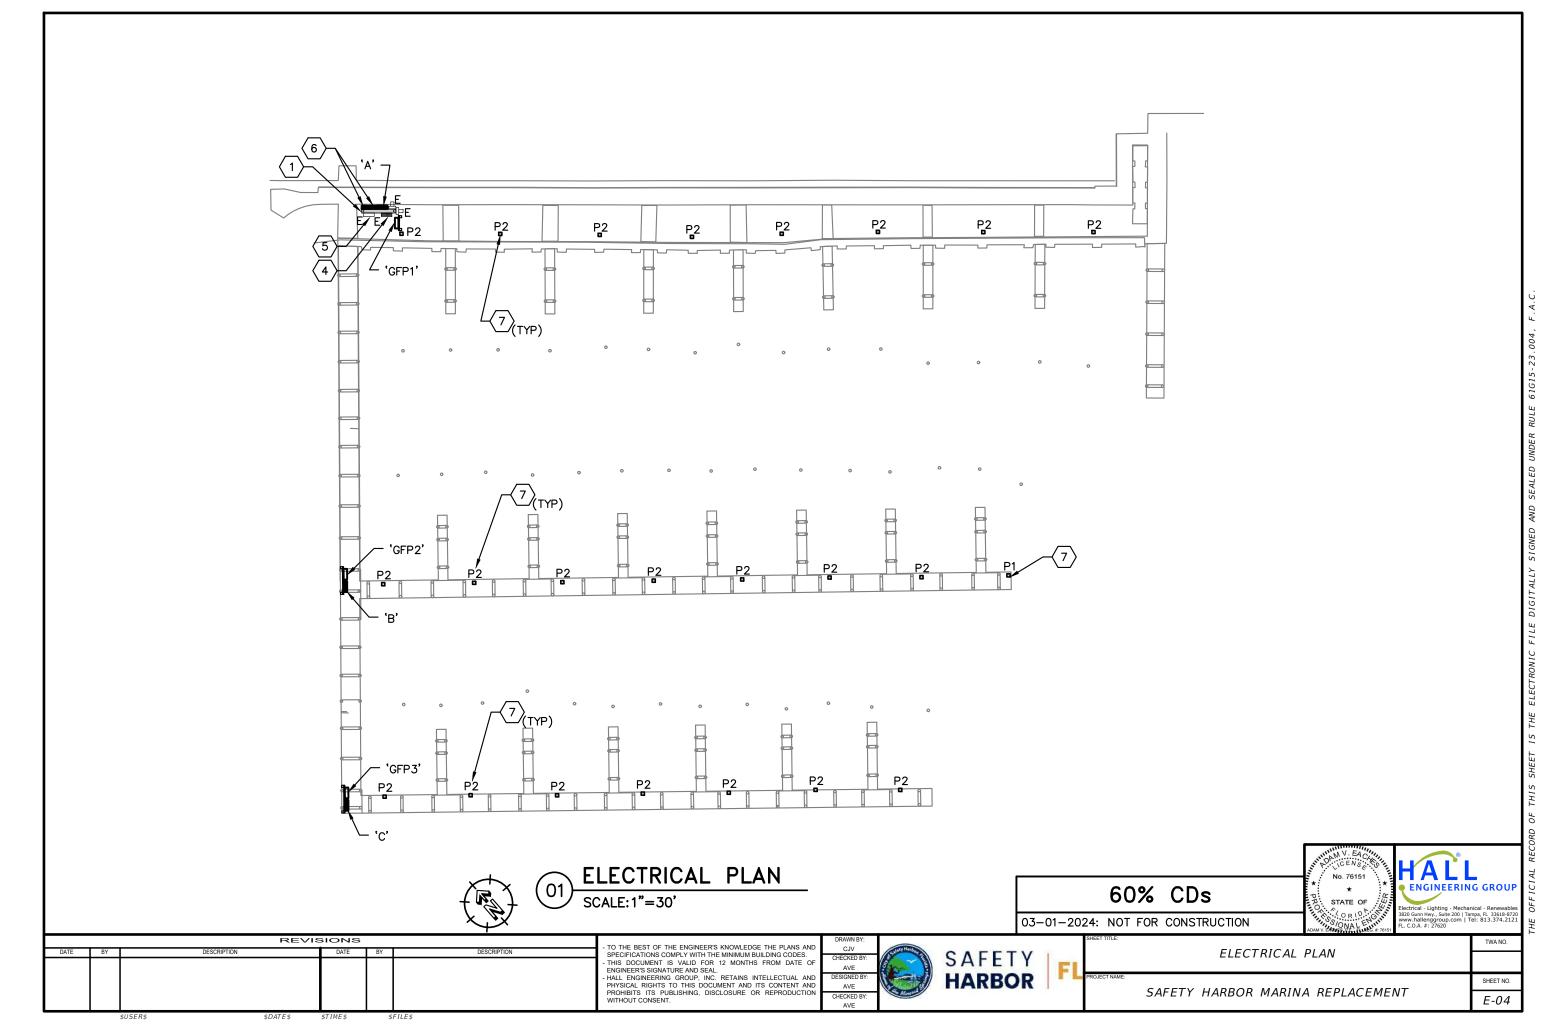
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# DRAWING NOTES (SHEET E-06)

- EXISTING EQUIPMENT RACK.
- EXISTING WIREWAY.
- EXISTING UTILITY METER.
- REPLACE EXISTING 240/120 V, 1¢, 3W, 150 A MCB PANELBOARD WITH NEW: REFER TO PANEL SCHEDULE.
- REPLACE EXISTING ENCLOSED CIRCUIT BREAKER WITH NEW 240 V 16, 3W, 225 A, SHUNT-TRIP CIRCUIT BREAKER IN STAINLESS STEEL (TYPE 316) ENCLOSURE.
- NEW EQUIPMENT RACK: MINIMUM 5" X 5" CONCRETE POSTS WITH STAINLESS STEEL (TYPE 316) STRUT CHANNEL. SIZE AS REQUIRED.
- NEW EQUIPMENT RACK MOUNTED TO DOCK PILES; STAINLESS STEEL (TYPE 316) STRUT CHANNEL. SIZE AS REQUIRED.
- GROUND FAULT MONITORING PANEL; BENDER, MARINAGUARD MG-T OR ENGINEER APPROVED EQUAL.
- GROUND FAULT MONITORING PANEL WILL MONITOR THE FEEDERS TO PANELBOARDS "A", "B" AND "C" AS WELL AS THE BRANCH CIRCUIT CONDUCTORS SERVING SLIPS 1-16; GROUND FAULT PROTECTION SHALL BE SET TO 100 mA MAX.
- 10. GROUND FAULT MONITORING PANEL WILL MONITOR THE BRANCH CIRCUIT CONDUCTORS SERVING SLIPS 17-31; GROUND FAULT PROTECTION SHALL BE SET TO 100 mA MAX.
- GROUND FAULT MONITORING PANEL WILL MONITOR THE BRANCH CIRCUIT CONDUCTORS SERVING SLIPS 32-44; GROUND FAULT PROTECTION SHALL BE SET TO 100 mA MAX.
- 12. REPLACE EXISTING 240/120 V, 16, 3W, 225 A MLO PANELBOARD WITH NEW; REFER TO PANEL SCHEDULE.
- 13. REPLACE EXISTING CONDUIT AND CONDUCTORS AS FOLLOWS: 3 #4/0 + #4 EG 2 1/2" C.
- 14. REPLACE EXISTING CONDUIT AND CONDUCTORS AS FOLLOWS: 3 #250 KCMIL + #3 EG 3" C.
- 15. SPD; PQ PROTECTION, MODEL #PQC160-240V OR ENGINEER APPROVED EQUAL.
- 16. FEEDS PANEL "B".
- 17. FEEDS PANEL "C".
- 18. EXISTING GROUNDING ELECTRODE SYSTEM.
- 19. GROUNDING ELECTRODE SYSTEM.
- 20. PROVIDE (1) SPARE 2 1/2" C.
- 21. PROVIDE (1) SPARE 3" C.

# DRAWING GENERAL NOTES (SHEET E-06)

- REFER TO SPECIFICATIONS FOR ADDITIONAL INFORMATION AND REQUIREMENTS.
- MAXIMUM 3 QUARTER TURNS (TOTAL 270°) CONDUIT BENDS BETWEEN JUNCTION/PULL BOXES.
- MAINTAIN MINIMUM 12" SEPARATION BETWEEN ELECTRICAL AND OTHER UTILITIES/INFRASTRUCTURE.
- COORDINATE WITH EXISTING UNDERGROUND UTILITIES AND CONDITIONS. HAND DIG TRENCHES AS REQUIRED.
- SAW CUT AND PATCH PAVEMENT AS REQUIRED. COORDINATE WORK WITH OWNER.
- ALL CONDUCTORS SHALL BE TYPE XHHW-2.
- ALL EXPOSED CONDUITS SHALL BE UV RESISTANT, SCHEDULE 80 PVC.
- ALL FASTENERS, ANCHORS, STRAPS, HARDWARE, STRUT-CHANNEL, ETC. SHALL BE STAINLESS STEEL (TYPE 316).
- THE ELECTRICAL DATUM PLANE SHALL BE 2 FEET ABOVE THE HIGHEST TIDE LEVEL.
- ALL ELECTRICAL EQUIPMENT AND DEVICES SHALL BE LOCATED ABOVE THE ELECTRICAL DATUM PLANE.
- ELECTRICAL EQUIPMENT AND DEVICES LOCATED ON THE DOCK SHALL BE MINIMUM 12" ABOVE THE DECK BUT SHALL NOT BE LOCATED BELOW THE ELECTRICAL DATUM PLANE.
- CONDUITS ROUTED UNDER THE DOCK SHALL BE SECURELY FASTENED TO THE STRUCTURE MAXIMUM EVERY 6' USING LISTED, 2-HOLE, STAINLESS STEEL (TYPE 316) CONDUIT STRAPS.

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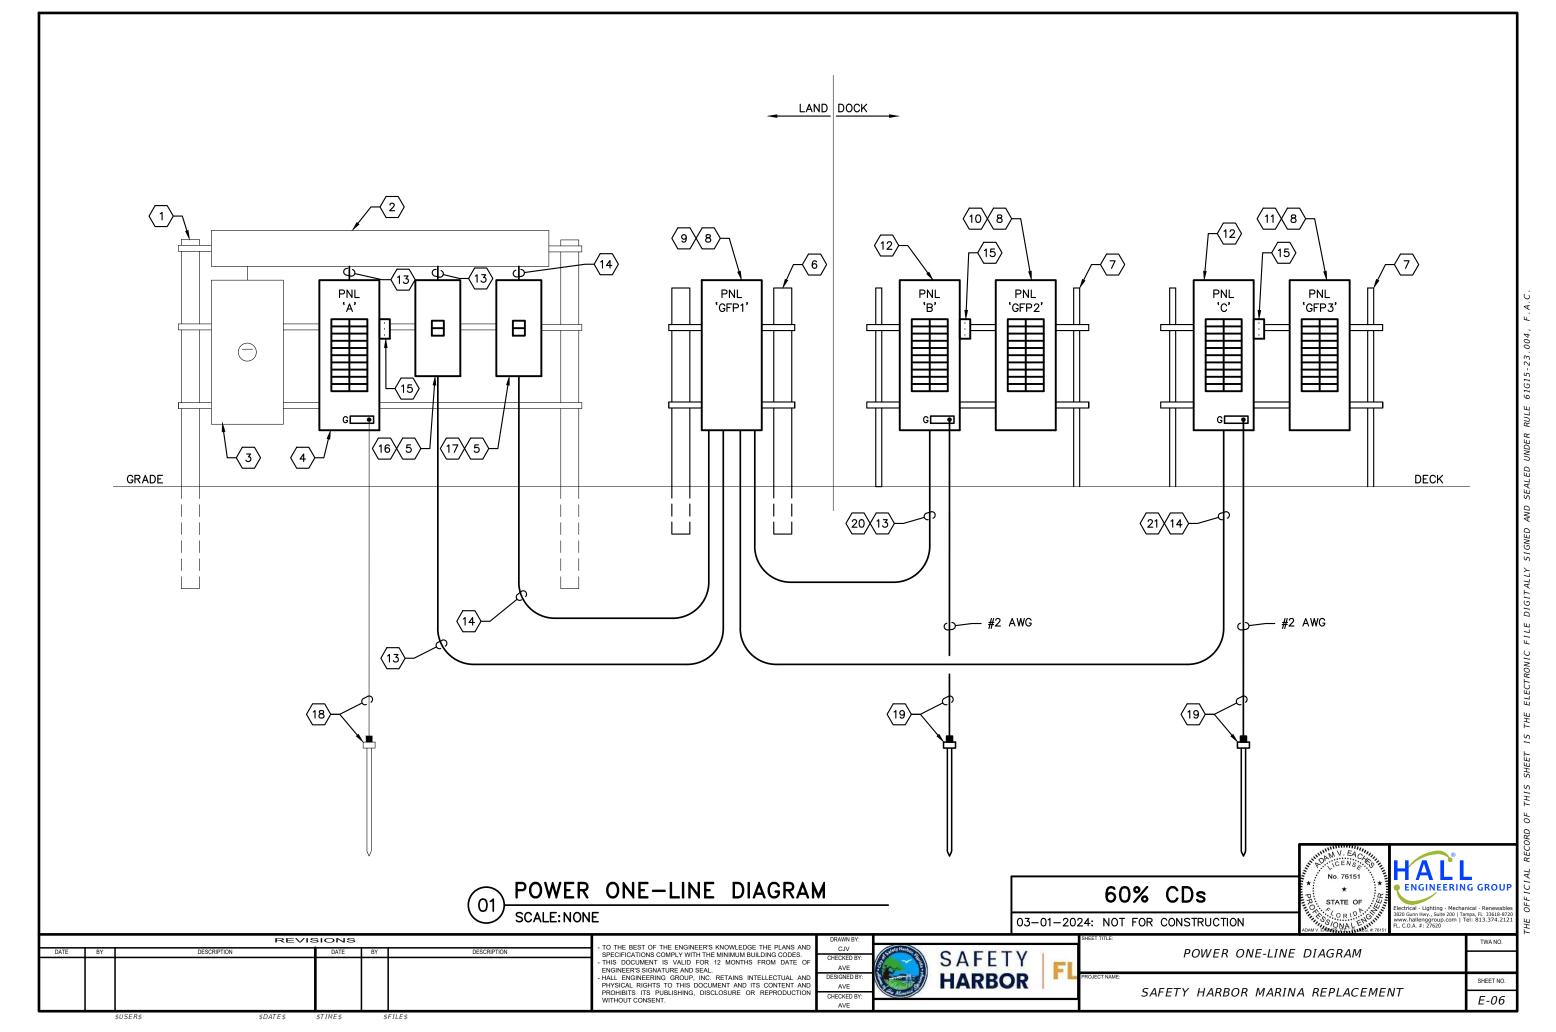
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SAFETY **HARBOR** AVE

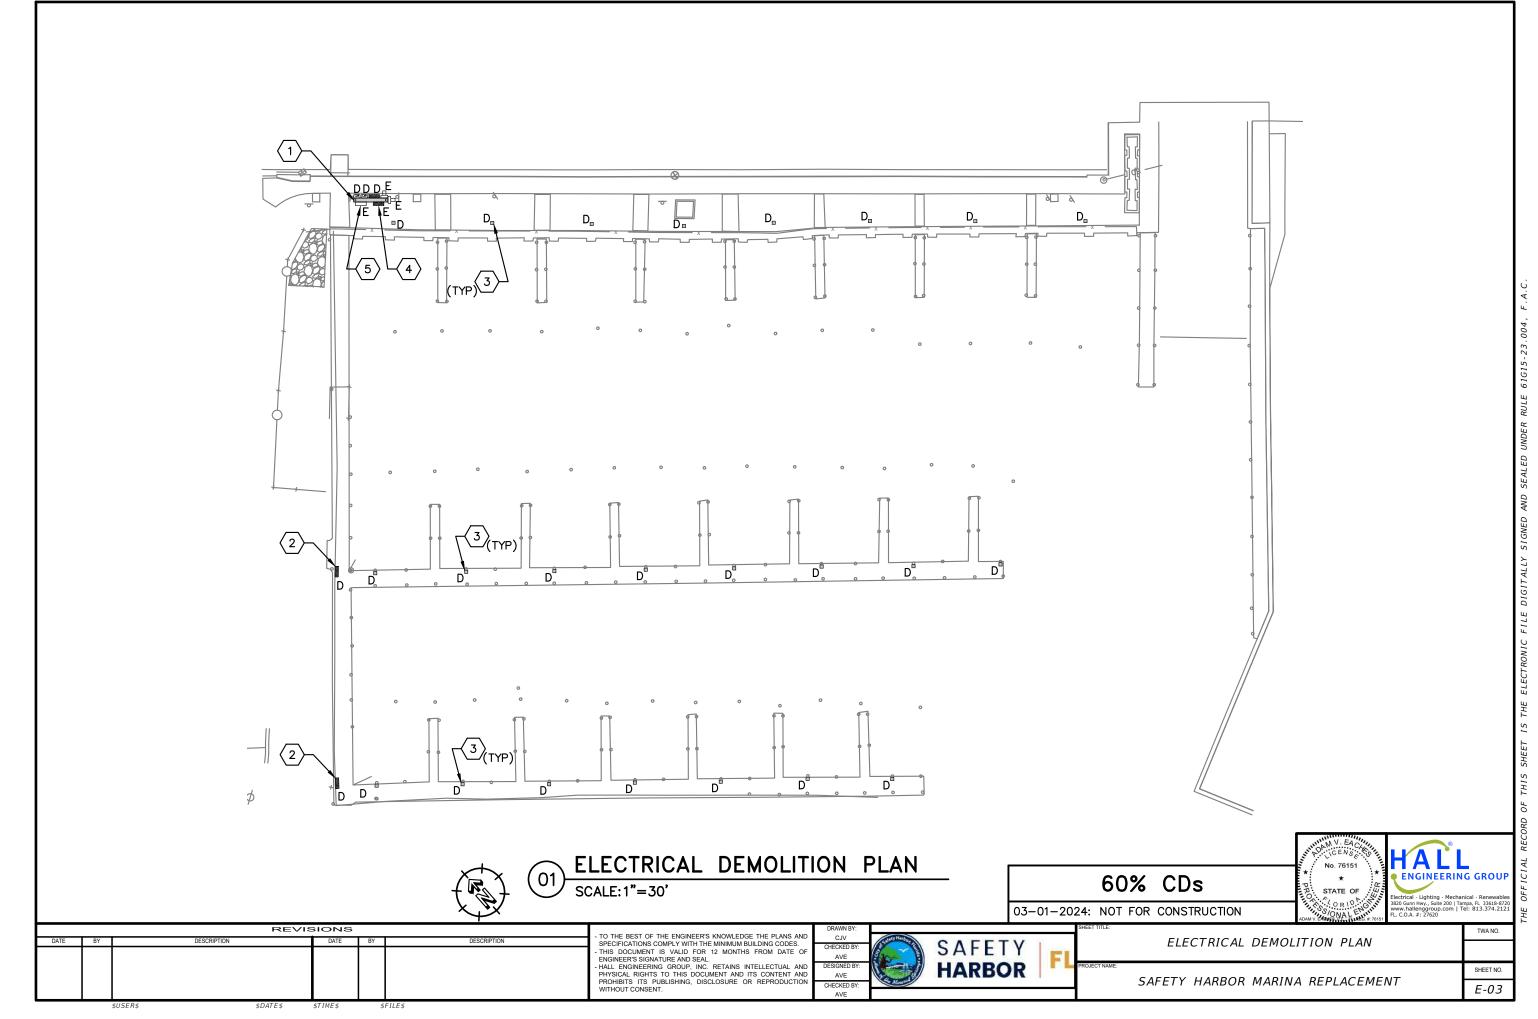POWER ONE-LINE DIAGRAM NOTES

SAFETY HARBOR MARINA REPLACEMENT

SHEET NO. E-05



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Feb.29.2024
E-07 Panel Schedule A.dwg
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'rojects\2307C Safety
Z:\2023 P

		PAN	<b>NELBO</b>	DARD	A	4	SCHI	EDUL	E.			
VOLTAGE (L-L/L-N): 240 / 120 V PHASE: 1					WIRES: 3 MAII			IN TYPE:	мсв		MAIN OC DEVICE (2): 225 A	
	BUS RATING: 225 A		RATING:	10,000 /	A A	ENC	OSURE T	YPE (1):	NEMA		MOUNTING: SURFACE	=
FE	ED-THRU LUGS: NO	SUB-FE	ED LUGS:	NO		IS	DLATED G	ND BUS:	NO		NEUTRAL BUS: YES	
KT	DECODIDATION	BR	EAKER		PHASE LO	ADS (VA)		BREA	KER		DECODIDATION	CK.
NO	DESCRIPTION	POLE	TRIP	,	4	E	3	TRIP	POLE	1	DESCRIPTION	NC
1 SLIP	1 & 2 (2)	2	30	3,600	0			20	2	SPD		2
3 "						3,600	0			"		4
	JNT-TRIP)			0	3,600			30	2	SLIP 9	& 10 (2)	6
7 SLIP	3 & 4 (2)	2	30			3,600	3,600			"		8
9 "				3,600	0						T-TRIP)	10
	JNT-TRIP)					0	3,600	30	2	SLIP 1	1 & 12 (2)	12
	5 & 6 (2)	2	30	3,600	3,600					"		14
15 "						3,600	0				T-TRIP)	16
	JNT-TRIP)			0	3,600			30	2	SLIP 1	3 & 14 (2)	18
	7 & 8 (2)	2	30			0	3,600			"		20
21 "				3,600	0					<u> </u>	T-TRIP)	22
	JNT-TRIP)					3,600	3,600	30	2	SLIP 1	5 & 16 (2)	24
	CONTROL POWER	1	20	300	3,600					"		26
27 SPAC						_	0			<u> </u>	T-TRIP)	28
29 SPAC				_	_					SPACE		30
31 SPA						_	_			SPACE		32
33 SPA				_	_					SPACE		34
35 SPA			ļ			_	_			SPACE		36
37 SPA				_	_					SPACE		38
39 SPAC						_	_			SPACE		40
41 SPA	∍Ľ.		TOTAL	- 20		28,	200			SPACE		42

LOAD CLASSIFICATION	CONNECTED (VA)	DEMAND FACTOR	DEMAND (VA)
EXTERIOR LIGHTING	0	1.25	0
INTERIOR LIGHTING	0	1.25	0
RECEPTACLE (1st 10 k)	0	1.00	0
RECEPTACLE (Over 10 k)	0	0.50	0
AIR HANDLERS	0	1.00	0
ELECTRIC HEAT	0	1.00	0
COOLING	0	1.00	0
EQUIPMENT/MOTORS	300	1.00	300
LARGEST MOTOR	0	1.25	0
SHORE POWER RECPTS	57,600	0.70	40,320
TOTAL	57,900		40,620

PANEL SUMMARY					
CONNECTED	241 A				
DEMAND	169 A				
SPARE CAPACITY	6 %				

### NOTES:

- PROVIDE STAINLESS STEEL (TYPE 316) ENCLOSURE.
- PROVIDE SHUNT-TRIP CIRCUIT BREAKER.

60% CDs 03-01-2024: NOT FOR CONSTRUCTION





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CHECKED BY:		SAFETY
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DESIGNED BY:		HARBOR
AVE	3	HARDUR
CHECKED BY:	Minor	
AVE		

PANEL SCHEDULE A

SHEET NO.

SAFETY HARBOR MARINA REPLACEMENT

E-07

TWA NO.

\$TIME\$

			PAN	IELBO	DARD	E	3	•
	VOLTAGE (L-L/L-N): 240 / 120	_		PHASE:		WIRES:		
	BUS RATING: 225 A				10,000 A	4	ENC	LC
	FEED-THRU LUGS: NO	5	SUB-FEE	D LUGS:			IS	
CKT	DESCRIPTION		BRE	AKER	F	PHASE LO	DADS (VA)	<u>)                                    </u>
NO			POLE	TRIP	P	4	E	3
1	SLIP 17 & 18 (2)		2	30	3,600	0		
3	"						3,600	
5	(SHUNT-TRIP)				0	3,600		
7	SLIP 19 & 20 (2)		2	30			3,600	Γ
9	"				3,600	0		П
11	(SHUNT-TRIP)						0	Γ
13	SLIP 21 & 22 (2)		2	30	3,600	3,600		П
15	"						3,600	Γ
17	(SHUNT-TRIP)				0	3,600		П
19	SLIP 23 & 24 (2)		2	30			0	Г
21	n				3,600	0		
23	(SHUNT-TRIP)						3,600	Г
25	GFP2 CONTROL POWER		1	20	300	1,800		П
27	SPACE						_	Г
29	SPACE				_	_		ı
31	SPACE						_	Г
33	SPACE				_	_		ı
35	SPACE						_	Г
37	SPACE				_	_		I
39	SPACE						_	Г
41	SPACE				_	_		ı
				TOTAL	27,	300	27,	0
Ì	LOAD CL	ASSIFICAT	ION	CONNEC	TED (VA)	DEMAND	FACTOR	Γ
Ì	EXTERIOR LIGH	HTING			0		1.25	L
	INTERIOR LIGH				0		1.25	L
	RECEPTACLE (	<u>, , , , , , , , , , , , , , , , , , , </u>			0		1.00 0.50	H
	AIR HANDLERS	•	()		0		1.00	H
	ELECTRIC HEA				0		1.00	r
	COOLING				0		1.00	
1	EQUIPMENT/M				300		1.00	Ĺ
1	LARGEST MOT				54,000		1.25	H
	SHORE POWER	KECPIS			54,000		0.70	L

PANEL SUMM	ARY
CONNECTED	226 A
DEMAND	159 A
SPARE CAPACITY	12 %

MAIN OC DEVICE: 225 A

**NEUTRAL BUS: YES** 

DESCRIPTION

MOUNTING: SURFACE

CKT NO

2

4

6

8

10

12 14

16

18

20

22

24

26

28

30

32

34 36

38

40

42

- PROVIDE STAINLESS STEEL (TYPE 316) ENCLOSURE.
- PROVIDE SHUNT-TRIP CIRCUIT BREAKER.

60% CDs 03-01-2024: NOT FOR CONSTRUCTION





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54,300

27,000

**SCHEDULE** 

ISOLATED GND BUS: NO

3,600

3,600

3,600

1,800

DEMAND (VA)

300

37,800

38,100

ENCLOSURE TYPE (1): NEMA 4X

MAIN TYPE: MCB

TRIP

20

30

30

30

30

BREAKER

POLE

2

2

SPD

SLIP 25 & 26 (2)

SLIP 27 & 28 (2)

SLIP 29 & 30 (2)

(SHUNT-TRIP)

(SHUNT-TRIP)

(SHUNT-TRIP)

(SHUNT-TRIP)

SLIP 31 (2)

SPACE

SPACE

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SAFETY **HARBOR** AVF

PANEL SCHEDULE B

SHEET NO. E-08

TWA NO.

SAFETY HARBOR MARINA REPLACEMENT

		PAN	ELBC	ARD	(	2	SCH	EDUL	.E			
	VOLTAGE (L-L/L-N): 240 / 120	v	PHASE:	1	WIRES:	3	МА	IN TYPE:	мсв		MAIN OC DEVICE: 225 A	
	BUS RATING: 225 A	MIN AIC	RATING:	10,000 /	À	ENCL	OSURE T	YPE (1):	NEMA	4X	MOUNTING: SURFACE	
	FEED-THRU LUGS: NO	SUB-FEE	D LUGS:	NO		ISC	DLATED G	ND BUS:	NO		NEUTRAL BUS: YES	
CKT	DECODIDATION	BRE	AKER	f	PHASE LO	ADS (VA)		BREA	KER		DECODIDION	СКТ
NO	DESCRIPTION	POLE	TRIP	A	4	Е	3	TRIP	POLE	1	DESCRIPTION	NO
1	SLIP 32 & 33 (2)	2	30	3,600	0			20	2	SPD		2
3	"					3,600	0			"		4
5	(SHUNT-TRIP)			0	3,600			30	2	SLIP 40	0 & 41 (2)	6
7	SLIP 34 & 35 (2)	2	30			3,600	3,600			"		8
თ	"			3,600	0					_ `	Γ–TRIP)	10
11	(SHUNT-TRIP)					0	3,600	30	2	SLIP 4:	2 & 43 (2)	12
13	SLIP 36 & 37 (2)	2	30	3,600	3,600					"		14
15	"					3,600	0			(SHUN1	Γ–TRIP)	16
17	(SHUNT-TRIP)			0	1,800			30	2	SLIP 4	4 (2)	18
19	SLIP 38 & 39 (2)	2	30			0	1,800			"		20
21	"			3,600	0					(SHUN1	Γ–TRIP)	22
23	(SHUNT-TRIP)					3,600	_			SPACE		24
25	GFP3 CONTROL POWER	1	20	300	ı					SPACE		26
27	SPACE					_	_			SPACE		28
29	SPACE			ı	ı					SPACE		30
31	SPACE					_	_			SPACE		32
33	SPACE			-	_					SPACE		34
35	SPACE					_	_			SPACE		36
37	SPACE			_	_					SPACE		38
39	SPACE					_	_			SPACE		40
41	SPACE			-	_					SPACE		42
			TOTAL	23,	700	23,4	100					

LOAD CLASSIFICATION	CONNECTED (VA)	DEMAND FACTOR	DEMAND (VA)
EXTERIOR LIGHTING	0	1.25	0
INTERIOR LIGHTING	0	1.25	0
RECEPTACLE (1st 10 k)	0	1.00	0
RECEPTACLE (Over 10 k)	0	0.50	0
AIR HANDLERS	0	1.00	0
ELECTRIC HEAT	0	1.00	0
COOLING	0	1.00	0
EQUIPMENT/MOTORS	300	1.00	300
LARGEST MOTOR	0	1.25	0
SHORE POWER RECPTS	46,800	0.80	37,440
TOTAL	47,100		37,740

PANEL SUMMARY					
CONNECTED	196 A				
DEMAND	157 A				
SPARE CAPACITY	13 %				

### NOTES:

- PROVIDE STAINLESS STEEL (TYPE 316) ENCLOSURE.
- PROVIDE SHUNT-TRIP CIRCUIT BREAKER.

60% CDs 03-01-2024: NOT FOR CONSTRUCTION





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SAFETY **HARBOR** AVE

PANEL SCHEDULE C

E-09

SAFETY HARBOR MARINA REPLACEMENT

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MARINA PEDESTAL SCHEDULE						
TAG	DESCRIPTION					
P1	(1) 30 A, 1 PH, 125 V RECEPTACLE; NEMA L5-30, 1 HOSE BIBB, LED LIGHT, 30 mA GFPE RELAY AND SHUNT-TRIP CIRCUIT BREAKER, NEMA 3R, SS (TYPE 316) PEDESTAL, MEE - MARINA MATE SS OR ENGINEER APPROVED EQUIVALENT.					
P2	(2) 30 A, 1 PH, 125 V RECEPTACLE; NEMA L5-30 (ONE RECEPTACLE PER SIDE), 2 HOSE BIBBS (ONE HOSE BIBB PER SIDE), LED LIGHT, 30 mA GFPE RELAYS AND SHUNT-TRIP CIRCUIT BREAKERS, NEMA 3R, SS (TYPE 316) PEDESTAL, MEE - MARINA MATE SS OR ENGINEER APPROVED EQUIVALENT.					

- RECEPTACLES SHALL BE ENCLOSED IN WET LOCATION LISTED, WHILE-IN-USE WEATHERPROOF ASSEMBLIES.
- 2. RECEPTACLES SHALL BE MARINE GRADE, WEATHER RESISTANT TYPE.
- SUBMIT MARINA PEDESTALS FOR OWNER/ENGINEER REVIEW AND APPROVAL.

60% CDs

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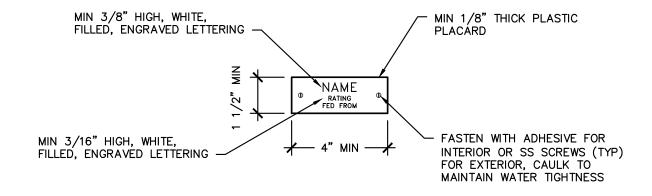
SAFETY HARBOR AVE

MARINA PEDESTAL SCHEDULE


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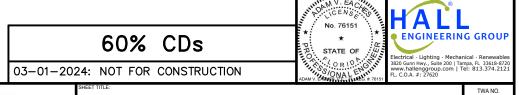
SAFETY HARBOR MARINA REPLACEMENT



PLACARD DETAIL SCALE: N.T.S.



CONDUIT TRENCH DETAIL SCALE: N.T.S.

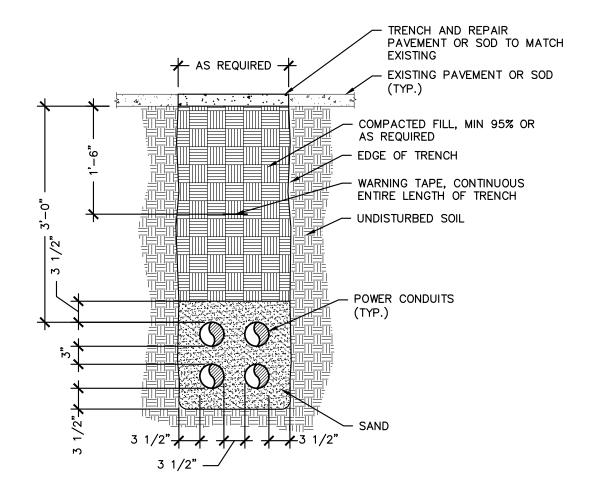

REVISIONS

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SAFETY HARBOR

**DETAILS** SHEET NO.

E-11

SAFETY HARBOR MARINA REPLACEMENT

VALVING AND ALARM REQUIREMENTS TO MINIMIZE POTENTIAL FOR IMPAIRMENTS AND

WATER SOURCE IS FROM EXISTING PUBLIC UTILITY WATER MAIN. THERE ARE NO KNOWN

CONTRACTOR SHALL REEVALUATE WATER SUPPLY AND ENVIRONMENTAL CONDITIONS FOR

EXISTENCE OF MICROBES AND CONDITIONS THAT CONTRIBUTE TO M.I.C. PRIOR TO START

OF CONSTRUCTION. WHERE CONDITIONS ARE FOUND THAT CONTRIBUTE TO M.I.C. THE

CONDITIONS PRESENT THAT CONTRIBUTE TO MICROBIOLOGICAL CORROSION (M.I.C.).

N/A, MANUAL DRY STANDPIPE, SERVING FIXED DOCK IN MARINE ENVIRONMENT.

CONTRACTOR SHALL NOTIFY OWNER AND ENGINEER.

QUALITY AND PERFORMANCE SPECIFICATIONS OF ALL YARD AND INTERIOR FIRE PROTECTION COMPONENTS

ALL NEW YARD AND INTERIOR FIRE PROTECTION EQUIPMENT SHALL BE UL LISTED AND/OR FM APPROVED.

N/A, MANUAL DRY STANDPIPE, SERVING FIXED DOCK IN MARINE ENVIRONMENT.

WATER STORAGE TANK REQUIREMENT

FIRE PUMP REQUIREMENT

UNRECOGNIZED FLOW OF WATER:

N/A, MANUAL DRY STANDPIPE, SERVING FIXED DOCK IN MARINE ENVIRONMENT.

OWNER'S CERTIFICATE FOR STORAGE FACILITIES

PROPERTY IS NOT A STORAGE OCCUPANCY. OWNER'S CERTIFICATE IS NOT REQUIRED.

FLORIDA ADMINISTRATIVE CODE: 61G15-32.004

SCOPE OF WORK

ADDITION / EXTENSION TO AN EXISTING CLASS 1 MANUAL DRY STANDPIPE SYSTEM DESIGNED IN COMPLIANCE WITH THE APPLICABLE NFPA STANDARDS LISTED WITHIN THESE DOCUMENTS.

COMPLIANCE NOTES

ACCEPTANCE TEST CRITERIA

SHALL COMPLY WITH NFPA-14. SPRINKLER SYSTEM SHALL BE PROPERLY INSPECTED AND MAINTAINED IN ACCORDANCE WITH NFPA-25 STANDARD FOR INSPECTION, TESTING, AND MAINTENANCE OF WATER BASED SYSTEM.

HAZARD CLASSIFICATION

CLASSIFICATION: ORDINARY HAZARD (GROUP 1 AND GROUP 2).

APPLICABLE NFPA STANDARDS TO BE APPLIED

FLORIDA BUILDING CODE (8TH EDITION)

FLORIDA FIRE PREVENTION CODE (8TH EDITION)

NFPA 303

NFPA 13 NFPA 14

NFPA 24

NFPA 25

FIRE ALARM SYSTEM

N/A, MANUAL DRY STANDPIPE, SERVING FIXED DOCK IN MARINE ENVIRONMENT.

POINT OF SERVICE

N/A. MANUAL DRY STANDPIPE. SERVING FIXED DOCK IN MARINE ENVIRONMENT.

CLASSIFICATION OF HAZARD OCCUPANCY FOR EACH ROOM OR AREA

ORDINARY HAZARD (GROUP 2): MARINA / DOCK

DESIGN APPROACH

N/A, MANUAL DRY STANDPIPE, SERVING FIXED DOCK IN MARINE ENVIRONMENT.

CHARACTERISTICS OF THE WATER SUPPLY TO BE USED

STREET MAIN IS CIRCULATING. MINIMUM DURATION OF 60-90 MINUTES.

FLOW TEST DATA:

TO BE PREFORMED BY CONTRACTOR, UPON REQUEST BY AHJ.

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FIRE PROTECTION COMPLIANCE NOTES

SAFETY HARBOR MARINA REPLACEMENT

FP-01

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# FIRE PROTECTION SPECIFICATIONS GENERAL PROVISIONS 1.1 PROVIDE ALL LABOR, MATERIAL AND EQUIPMENT FOR A COMPLETE AND PROPERLY OPERATING FIRE PROTECTION SYSTEM. CODES AND STANDARDS: THE FIRE SPRINKLER PROTECTION SYSTEMS INSTALLATION, FLUSHING AND TESTING SHALL COMPLY WITH THE REQUIREMENTS OF NFPA 14, AND ALL LOCAL CODES HAVING JURISDICTION. PIPE THREAD PATTERN: ALL THREADS SHALL BE IN ACCORDANCE WITH LOCAL FIRE DEPARTMENT SPECIFICATIONS AND NFPA 1963. UL/FM APPROVAL: ALL EQUIPMENT, VALVES, COUPLINGS, HANGERS AND DEVICES SHALL BE APPROVED BY UNDERWRITERS' LABORATORY (UL) OR FACTORY MUTUAL (FM) FOR USE IN FIRE PROTECTION SERVICES. LICENSURE: THE FIRE PROTECTION SYSTEMS SHALL BE INSTALLED BY A STATE CERTIFIED FIRE PROTECTION CONTRACTOR. ALL FIRE PROTECTION WORK SHALL BE DONE IN A NEAT AND WORKMAN-LIKE MANNER. CONTRACTOR SHALL SECURE AND PAY FOR ALL PERMITS AND FEES, ETC., 1.7 REQUIRED FOR THE EXECUTION OF THIS WORK. CONTRACTOR SHALL COORDINATE WORK WITH OTHER TRADES BEFORE FABRICATION OR INSTALLATION. OFFSETS AND/OR TRANSITIONS REQUIRED SHALL BE PROVIDED WITHOUT ADDITIONAL COST. CONTRACTOR SHALL COORDINATE AND INSTALL WORK IN A TIMELY MANNER TO PREVENT DELAYS IN THE CONSTRUCTION. CONTRACTOR SHALL BE RESPONSIBLE FOR REPAIR OR REPLACE DAMAGED. EQUIPMENT AND/OR MATERIAL. 2.0 BASIC MATERIALS AND METHODS 2.1 ALL PIPING MATERIALS SHALL HAVE A CORROSION RESISTANCE RATING (CFR) OF 1.0 OR GREATER. HANGERS: ALL HANGER SPACING SHALL COMPLY WITH THE REQUIREMENTS OF NFPA-13. HANGERS TO BE PROTECTED FROM CORROSION (316 STAINLESS STEEL) HYDROSTATIC TESTS: ABOVE GROUND AND BELOW GROUND PIPING SYSTEMS

SHALL BE HYDROSTATICALLY TESTED AT NOT LESS THAN 200 PSI PRESSURE

GREATER, FOR A PERIOD OF 2 HOURS. THE TEST PRESSURE SHALL BE READ

FROM A GAUGE LOCATED AT THE LOW ELEVATION POINT OF THE INDIVIDUAL SYSTEM OR PORTION OF THE SYSTEM BEING TESTED. THE SPRINKLER PIPING

SHALL NOT HAVE LEAKAGE EXCEEDING THE AMOUNTS SPECIFIED IN NFPA 24.

LEAKAGE QUANTITIES SHALL BE DETERMINED BY PUMPING AT THE SPECIFIED

RETEST AS NECESSARY UNTIL ALL SYSTEMS HAVE BEEN TESTED. TEST THE

THE OUTSIDE CONNECTION THE SAME AS THE BALANCE OF THE SYSTEM.

TEST PRESSURE FROM A CALIBRATED CONTAINER. REPAIR LEAKING JOINTS AND

PIPING BETWEEN THE CHECK VALVE IN THE FIRE DEPARTMENT INLET PIPE AND

OR AT 50 PSI IN EXCESS OF THE MAXIMUM PRESSURE, WHICHEVER IS

### FIRE PROTECTION SPECIFICATIONS CONTINUED

#### FIRE PROTECTION VALVES AND ACCESSORIES

- BALL VALVE: TWO INCH (2") AND SMALLER: STANDARD FULL PORT BALL VALVE WITH BRASS BODY CONFORMING TO ASTM584, CHROME PLATED BRASS BALL AND STAINLESS STEEL STEM WITH TFE SEAL RATED FOR 365PSI. ACCEPTABLE MANUFACTURERS. VICTAULIC SERIES 728.
- BUTTERFLY VALVE: TWO INCH (2") AND LARGER IN LIEU OF GATE VALVE: 300 PSI GROOVED ENDS. DUCTILE IRON BODY. ASTM A536 GRADE 65-45-12: DUCTILE IRON DISC, ASTM A536 WITH ELECTROLESS NICKEL COATING CONFORMING TO ASTM B-733; STAINLESS STEEL STEM AND HAND WHEEL OPERATED WITH WEATHER PROOF ACTUATOR RATED TO 300PSI. (STEM SHALL BE OFFSET FROM THE DISC CENTERLINE TO PROVIDE COMPLETE 360-DEGREE CIRCUMFERENTIAL SEATING ON NITRILE SEAT.) VICTAULIC SERIES 705 AND SERIES 765
- CHECK VALVE: TWO INCH (2") TWELVE INCH (12"), DUCTILE IRON BODY, ASTM A-536, GRADE 65-45-12, MINIMUM OF 250 PSI WITH SINGLE DISC MECHANISM INCORPORATING A SPRING ASSISTED FEATURE FOR NON-SLAMMING OPERATION AND CAN BE INSTALLED EITHER VERTICALLY OR HORIZONTALLY. VICTAULIC SERIES 717. AND SERIES 717H.
- ZONE CONTROL VALVES: CAST FROM DUCTILE IRON CONFORMING TO ASTM A-536, GRADE 65-45-12 WITH INTEGRATED MODULE BODY CONSISTING OF A SHUT OFF VALVE, TEST AND DRAIN COMBINATION, FLOW SWITCH, AND PRESSURE GAUGE WITH WORKING PRESSURE OF 300PSI.
  - 1) 1" THROUGH 2": FOR NFPA 13, 13D, AND 13R COMMERCIAL AND RESIDENTIAL REQUIREMENTS. VICTAULIC SERIES 247.
  - 2) 11/4" THROUGH 6": FOR NFPA 13 COMMERCIAL REQUIREMENTS. VICTAULIC SERIES 747M
- TAMPER SWITCH: SPST, NORMALLY CLOSED CONTACTS, DESIGNED TO SIGNAL VALVE IN OTHER THAN FULL OPEN POSITION. ACCEPTABLE MANUFACTURER: POTTER
- FIRE DEPARTMENT CONNECTION:
  - 1) SIAMESE CONNECTION: CAST BRASS, ANGLE BODY, TWO-WAY, SIAMESE CONNECTION. CONNECTION SIZES SHALL BE 4" OUTLET AND TWO (2) AND 21/2" FEMALE INLETS, HAVING NH STANDARD THREADS, FOR THE CONNECTION SIZE INDICATED, AS SPECIFIED IN NFPA 1963. EACH INLET SHALL HAVE A CLAPPER VALVE, AND PLUG AND CHAIN. WHEN REQUIRED PROVIDE AN 18" HIGH CHROME PLATED BRASS SLEEVE AND CHROME PLATED BRASS SIDEWALK PLATE, WITH WORDS "STANDPIPE - FIRE DEPT CONNECTION" OR "AUTO SPKR - FIRE DEPT CONNECTION," OR "AUTO SPKR & STANDPIPE - FIRE DEPT CONNECTION" IN RAISED LETTERS. ACCEPTABLE MANUFACTURER OF FIRE DEPARTMENT CONNECTION IS GUARDIAN FIRE EQUIPMENT, INC.

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FIRE PROTECTION SPECIFICATIONS

SHEET NO. FP-02

TWA NO.

SAFETY HARBOR MARINA REPLACEMENT

- 1. FIRE PROTECTION SYSTEM TO COMPLY WITH NFPA 13, 14, AND STATE FIRE
- 2. FINAL INSPECTION AND APPROVAL BY THE AUTHORITY HAVING JURISDICTION.

PREVENTION CODE.

- 3. CONTRACTOR TO SUBMIT A SET OF WORKING PLANS AS DEFINED IN NFPA-13 TO ENGINEER FOR REVIEW PRIOR TO SUBMITTING WORKING PLANS TO AUTHORITY HAVING JURISDICTION FOR FINAL APPROVAL.
- 4. ALL MATERIAL SHALL BE OF APPROVED QUALITY AND THE WORK SHALL BE DONE IN A THOROUGH AND WORKMANLIKE MANNER. THE WORK, MATERIALS AND TEST SHALL BE IN ACCORDANCE WITH ALL APPLICABLE NFPA REQUIREMENTS.
- 5. PIPE ROUTING SHOWN IS SCHEMATIC ONLY. IT IS THE RESPONSIBILITY OF THIS CONTRACTOR TO PROVIDE ANY ADDITIONAL OFFSETS, ETC. REQUIRED FOR A COMPLETE AND NFPA COMPLIANT INSTALLATION. CONTRACTOR SHALL COORDINATE WITH OTHER TRADES AND SITE TO ENSURE SPRINKLER OPERATION IS NOT OBSTRUCTED AND SPACING IS MAINTAINED PER NEPA-1.3.
- 6. PROVIDE A PERMANENTLY ATTACHED NAME TAG ATTACHED TO THE FIRE DEPARTMENT CONNECTION, STATING NEW AND EXISTING COVERAGE AREAS. METAL (RED WITH WHITE LETTERS)
- 7. COORDINATE PIPING WITH ALL OTHER TRADES (PANELS, UTILITIES, TRANSFORMERS, ETC.) PRIOR TO ANY INSTALLATION. DO NOT ROUTE ANY PIPING OVER ANY ELECTRICAL PANELS UNDER ANY CIRCUMSTANCES.
- 8. FIRE PROTECTION SYSTEM ACCEPTANCE TESTS SHALL BE PERFORMED IN COMPLIANCE WITH THE REQUIREMENTS OF THE ASSOCIATED NFPA CODES.
- 9. FIRE PROTECTION SYSTEM ACCEPTANCE TESTS SHALL BE WITNESSED BY AUTHORITY HAVING JURISDICTION.
- 10. CONTRACTOR SHALL PROVIDE FLUSHING CONNECTIONS AT THE END OF ALL MAINS.
- 11. PIPE SUPPORTS: HANGERS, CLAMPS, RODS AND OTHER ACCESSORIES OF AN APPROVED TYPE AND IN SUFFICIENT NUMBER TO PROPERLY SUPPORT ALL PIPING SHALL BE FURNISHED AND INSTALLED.
- 12. CONTRACTOR SHALL PROVIDE THE OWNER WITH A THREE RING BINDER OF ALL LITERATURE AND INSTRUCTIONS AS PROVIDED BY THE MANUFACTURER DESCRIBING PROPER OPERATION AND MAINTENANCE OF ALL EQUIPMENT AND DEVICES INSTALLED, A COPY OF NFPA-25 "STANDARD FOR THE INSPECTION, TESTING, AND MAINTENANCE OF WATER-BASED FIRE PROTECTION SYSTEMS", AND THE APPROPRIATE CONTRACTOR'S MATERIAL AND TEST CERTIFICATE(S), COMPLETED AND SIGNED, AS INDICATED IN NFPA-13.

#### GENERAL NOTES CONTINUED

- 13. CONTRACTOR SHALL COORDINATE STRUCTURAL SUPPORT AND OPENINGS REQUIRED FOR INSTALLATION OF FIRE PROTECTION SYSTEM WITH STRUCTURAL ENGINEER.
- 14. COORDINATE FIRE PROTECTION PIPING WITH ALL OTHER TRADES. PROVIDE OFFSETS AS REQUIRED FOR THE INSTALLATION AS REQUIRED. FINAL FIELD COORDINATION BETWEEN ALL TRADES SHALL BE COMPLETED PRIOR TO START OF CONSTRUCTION.
- 15. PROVIDE ACCESS PANELS FOR ALL VALVES IN NON-ACCESSIBLE LOCATIONS.
- 16. ALL HANGERS AND FASTENERS SHALL BE 316 STAINLESS STEEL.
- 17. PROVIDE DIALECTIC SEPARATION AS REQUIRED TO PREVENT DISSIMILAR METAL/ GALVANIC CORROSION IN ALL MATERIALS. TWO MATERIALS WITH KNOWN POTENTIAL FOR GALVANIC ACTION SHALL NOT BE USED IN CONNECTION TO ONE ANOTHER..

#### PIPE MATERIAL SPECIFICATION

LOCATION USED	MATERIAL
UNDERGROUND	DR14 (BLUE BRUTE)
IN-BUILDING RISER	NA
FIRE RISER	NA
STANDPIPE	FM APPROVED, DR9 HDPE, UV RESISTANT, 250 PSI, EQUAL TO JM EAGLE
COMMERCIAL	NA
RESIDENTIAL	NA
EXTERIOR / DRY	FM APPROVED, DR9 HDPE, UV RESISTANT, 250 PSI, EQUAL TO JM EAGLE

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FIRE PROTECTION GENERAL NOTES

SAFETY HARBOR MARINA REPLACEMENT

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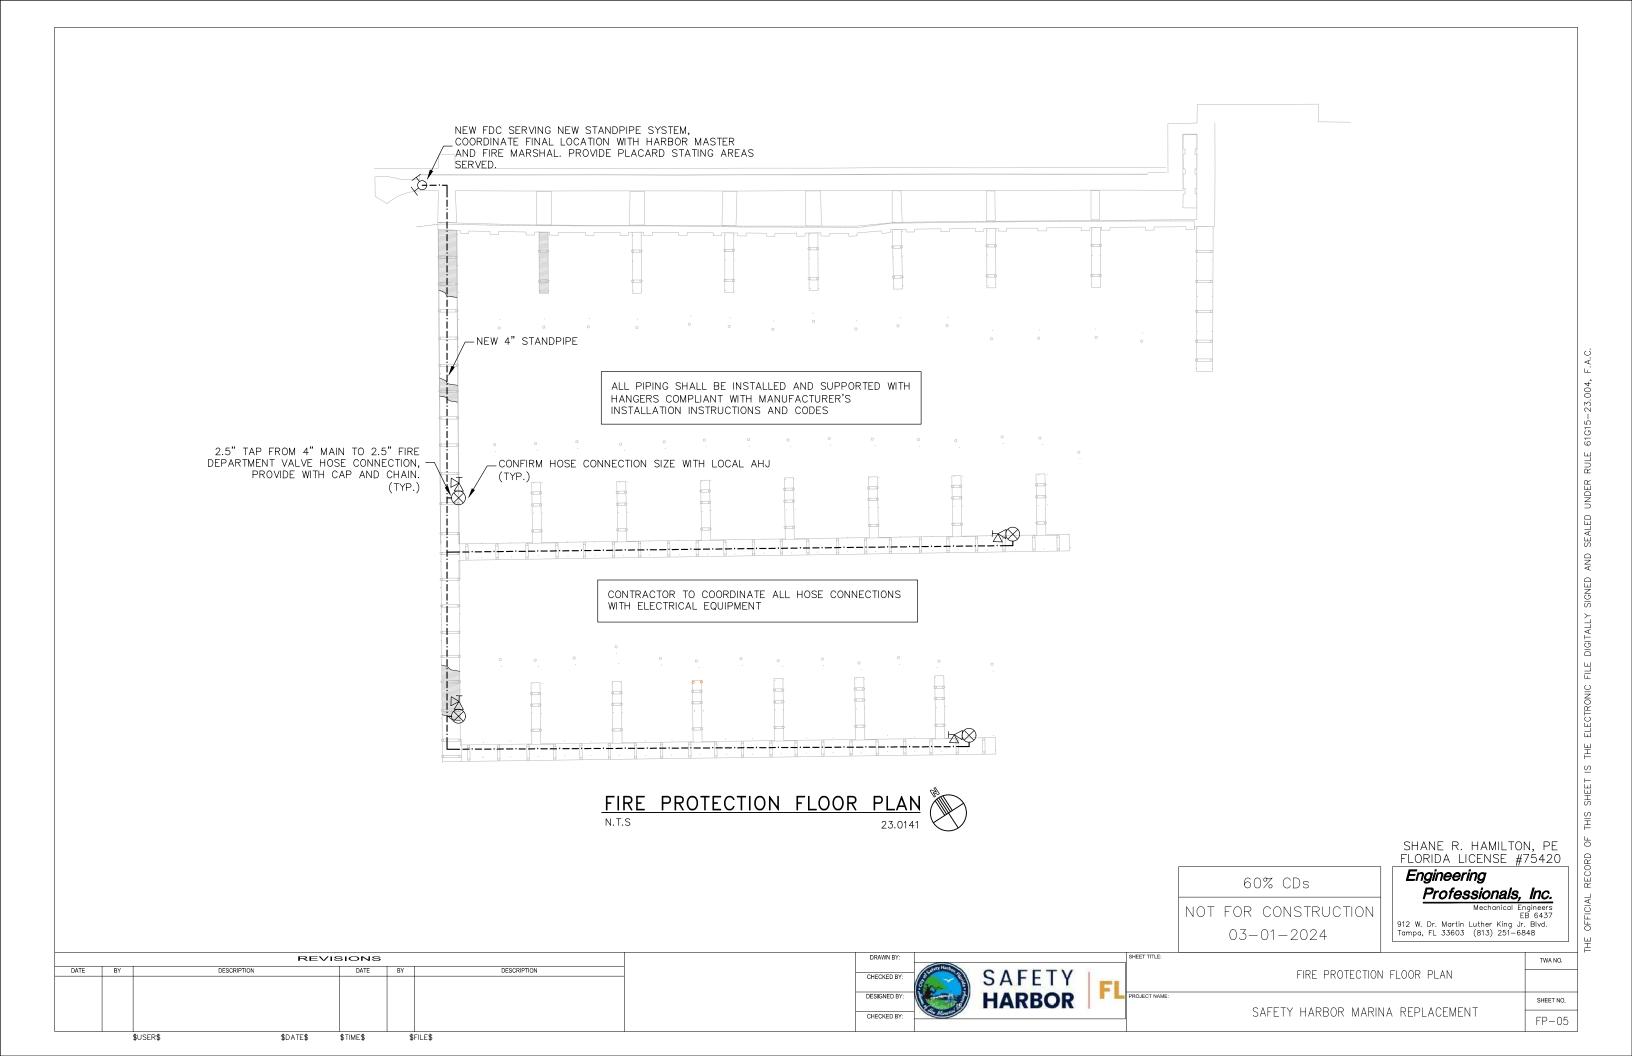
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FP-04

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# PLUMBING LEGEND DESCRIPTION ABBREV. SYMBOL SANITARY PIPING SAN V VENT PIPING COLD WATER PIPING CW EXISTING PIPING TO REMAIN EXISTING PIPING TO BE REMOVED HOSE BIBB HB TFF UP TEE DOWN 90° UP 90° DOWN LEAD FREE BALL VALVE ΒV

### MATERIAL SPECIFICATIONS:

1. DOMESTIC COLD WATER PIPING AND SOLVENT FITTINGS SHALL BE CPVC. ALL AREAS EXPOSED TO SUNLIGHT SHALL BE INSULATED WITH A UV STABLE INSULATION OR CONDUIT. FIELD COORDINATE AREAS OF UV EXPOSURE.

ALL PIPING SHALL BE INSTALLED AND SUPPORTED WITH HANGERS COMPLIANT WITH MANUFACTURER'S INSTALLATION INSTRUCTIONS AND CODES

## PLUMBING FIXTURE SCHEDULE

HB: HOSE BIBB — STAINLESS STEEL HOSE BIBB EQUALS TO SSHB5205. SEE PEDESTAL MANUFACTURER DOCUMENTS FOR DETAILS. 3/4"CW.

# PLUMBING GENERAL NOTES

- ALL PLUMBING WORK SHALL MEET ALL THE REQUIREMENTS OF THE "FLORIDA BUILDING CODE, PLUMBING 8TH EDITION (2023)".
- REVIEW PLANS OF ALL TRADES PRIOR TO BIDDING AND INSTALLATION TO INCLUDE ALL PLUMBING FOR COMPLETE SYSTEMS SHOWN ON THE PLANS AND AS REQUIRED.
- COORDINATE WITH OTHER TRADES TO PREVENT INTERFERENCE.
- ALL CHANGES SHALL BE APPROVED BY THE ENGINEER.
- COORDINATE WITH OTHER TRADE DRAWINGS BEFORE ROUGHING-IN PLUMBING FIXTURES AND EQUIPMENT SUPPLIES.
- THE PLUMBING SUBCONTRACTOR SHALL FURNISH AND INSTALL ALL PLUMBING FIXTURES, UNLESS NOTED OTHERWISE.
- THE PLUMBING SUBCONTRACTOR SHALL INSTALL AND MAKE ALL PLUMBING CONNECTIONS TO OWNER FURNISHED EQUIPMENT.
- VERIFY MOUNTING HEIGHT AND WATER CONNECTION SIZES TO ALL PLUMBING FIXTURES PRIOR TO ROUGH—IN.
- MAKE PROPER COLD WATER PIPING CONNECTIONS TO ALL FIXTURES AND EQUIPMENT EVEN THOUGH ALL FITTINGS AND CONNECTIONS ARE NOT SHOWN.
- VERIFY LOCATION OF EXISTING WATER SERVICE.
- THIS CONTRACTOR TO DO ALL CUTTING AND PATCHING REQUIRED TO INSTALL ANY PORTION OF THIS WORK. PATCH WITH NEW MATERIALS OF THE SAME TYPE THAT WAS REMOVED. REFINISH PATCHED SURFACE TO MATCH EXISTING ADJACENT SURFACES.
- IT IS IN THE INTENT OF THESE DRAWINGS TO COVER ALL WORK AND MATERIAL FOR A FIRST CLASS INSTALLATION. ANY EQUIPMENT, PLUMBING FIXTURE, TRIM HARDWARE AND/OR DEVICES USUALLY UTILIZED IN THE CLASS OF WORK, THOUGH NOT SPECIFICALLY MENTIONED OR SHOWN ON THESE DRAWINGS, BUT WHICH MAY BE NECESSARY FOR THE SATISFACTORY COMPLETION OF THE WORK (AS DETERMINED BY THE ARCHITECT) SHALL BE FURNISHED AND INSTALLED BY THE CONTRACTOR AS PART OF HIS TOTAL WORK.
- ALL HANGERS AND FASTENERS SHALL BE 316 STAINLESS STEEL.

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PLUMBING NOTES, LEGEND, AND SCHEDULE

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