

LANDFILL GAS AND SOLID WASTE SPECIALISTS

CERTIFICATION REPORT

For the:

2020 LANDFILL GAS COLLECTION AND CONTROL SYSTEM EXPANSION - PHASE II

At the:

VISTA LANDFILL APOPKA, FLORIDA



Prepared for:

VISTA LANDFILL, LLC

Vista Landfill

242 W. Keene Road Apopka, FL 32703 (407) 886-2920

Prepared by:

CARLSON ENVIRONMENTAL CONSULTANTS, PC

305 South Main Street Monroe, NC 28112 (704) 283-9765

August 2020



LANDFILL GAS AND SOLID WASTE SPECIALISTS

August 25, 2020

Mr. Craig Pelton Vista Landfill, LLC 242 W. Keene Road Apopka, FL 32703

Subject:

Certification Report - 2020 Phase II GCCS Expansion

Vista Landfill – Apopka, Florida

Dear Mr. Pelton:

Carlson Environmental Consultants, PC (CEC) is submitting this Certification Report for the construction of 2020 System Expansion – Phase II of the Landfill Gas Collection and Control System at Vista Landfill located in Apopka, FL. This certification report documents the construction activities from the beginning of construction of the landfill gas collection system expansion on July 6, 2020 through final completion of the construction project on July 9, 2020. The Certification Report provides a project description, daily field reports, construction photographs, additional construction documentation, and updated site plan.

Based on the CEC's construction logs, photos, and on-site inspections, it is my professional opinion that the project was performed in accordance with permit conditions and the construction drawings and specifications.

CEC appreciate this opportunity to provide landfill gas engineering services to Vista Landfill. Please feel free to contact me at (863) 634-7185 if you have any questions or desire additional information concerning this submittal.



Attachments

cc: Anthony Roman, VLL

Sheree Grant, VLL Amy Nunes, P.E., CEC

PROJECT SUMMARY 2020 GCCS Expansion – Phase II Vista Landfill

Project Timeframe:

Piping Activities: July 6, 2020 through July 9, 2020

Parties Involved:

Site Owner: Vista Landfill, LLC

242 W. Keene Road Apopka, FL 32703 Phone: (407) 886-2920

VLL Gas Operations Manager: Craig Pelton VLL District Manager: Anthony Roman VLL Market Area Engineer: Sheree Grant

Contractor: Carlson Environmental Consultants, PC (CEC)

305 S. Main Street

Monroe, North Carolina 28112 Phone: (704) 283-9765

CEC Construction Superintendent: Tom Gravel

Surveyor: Peavy & Associates Surveying & Mapping, PA

9399 North Lake Buffum Road Ft. Meade, Florida 33841 Phone: (863) 738-4960

Peavey Record Surveyor: Deborah Peavey, P.S.M.

Project Description:

Construction Vista Landfill Phase I Construction Drawings

Drawings: Vista Landfill – Apopka, FL

Sheets 1-7

Dated January 2020

Prepared by Carlson Environmental Consultants, PC

Piping

This piping installation was originally planned to be part of the Phase 1 2020 LFG Expansion project, but given the current fill elevations in Cell 6 it was not able to be completed.

Three horizontal collectors were install in Cells 5 and 6 running north to south; HC-18, HC-19, and HC-20. HC-18 was installed on the west end of these cells with 200' of 6" pipe on the north end, 295' of 6" perforated pipe, and 1 aggregate sump at the low point. HC-19 was installed toward the center of these cells with 250' of 6" pipe on the north end, 360' of 6" perforated pipe, 1 aggregate sump at the low point, and 50' of 6" pipe on the south end with a vertical riser. HC-20 was installed on the east end of Cells 5 and 6 with 360' of 6" pipe on the north end, 390' of 6" perforated pipe, 1 aggregate sump at the low point, and 50' of 6" pipe on the south end with a vertical riser. HC-18 connects to the existing GCCS with a wellhead (HC-18N) in Cell 5 adjacent to EW-20. HC-19 and HC-20 connect to the existing GCCS with wellheads (HC-19N and HC-20N respectively) in Cell 5 adjacent to EW-19. HC-19 and HC-20 have vertical risers on their south ends for future connections.



Department of Environmental Protection

Bob Martinez Center 2600 Blair Stone Road Tallahassee, Florida 32399-2400 DEP Form # 62-701.900(2)

Form Title Certification of Construction Completion of a Solid Waste Management Facility Effective Date May 19, 1994

Certification of Construction Completion of a Solid Waste Management Facility

DEP Construction Permit No: 0165969-030-SO	County:_	Orange
Name of Project: 2020 GCCS Expansion Phase II		
Name of Owner: Waste Management Inc. of Florida		
Name of Engineer: Seth A. Nunes, PE		
Type of Project: Installation of 6" horizontal collectors		
Cost: Estimate \$_68,000	Actual \$	58,000
Site Design Quantity: 2500 ton/day Sit	e Acreage:	102 Acres
Deviations from Plans and Application Approved by No vertical riser on the south end of HC-18. Extended HC		-
Address and Telephone No. of Site: 242 West Keene	Rd, Apopka, FL	32703
Telephone: (407	•	
Name(s) of Site Supervisor: Sheree Grant Cell Phone:	(407) 902-1469	
Date Site inspection is requested: As necessary		
This is to certify that, with the exception of any devia project has been completed in substantial accordan Construction		
	d: November 2, 2	NO 69457 *
Date: 8-75-7020		STATE OF W
31	gnature of Prof	ONAL ENGINE

ATTACHMENT A FDEP NOTIFICATION & CONSTRUCTION DRAWINGS

FDEP NOTIFICATION

From: Seth Nunes

To: "Stephen.Amirault@dep.state.fl.us"; "GloriaJean.Depradine@dep.state.fl.us"; "REarp@apopka.net";

"dep_cd@dep.state.fl.us"

Cc: "Sheree Grant"; "Craig Pelton"; "Parker, Eric (FL)"; Amy Nunes; Jim Christiansen; "Roman, Anthony"

Subject: RE: Vista Landfill - Construction Notification Phase I 2020

Date: Monday, July 6, 2020 8:08:00 PM

Attachments: VISTA PH1 2020 SITE FDEP NOTIFICATION 01-27-2019 - Sealed.pdf

Mr. Amirault:

On behalf of Vista Landfill, LLC (Vista), Carlson Environmental Consultants, PC is submitting this notification for gas collection system expansion at Vista Landfill Class III. In accordance with the 2/26/13 Solid Waste Modification (SO48-0165969-020, which incorporates -18, -21, and -22), Vista is proposing to install the new horizontal consistent with the notification earlier this year.

Construction is scheduled to start this week. Upon completion of construction, Vista will submit a certification of completion to FDEP summarizing the construction. A copy of the updated site plan will be maintained on-site.

Best Regards,

Seth Nunes, P.E.
Principal
Carlson Environmental Consultants, PC
1511 Johnson Ferry Road, Suite 125
Marietta, GA 30062

Office: 678-388-0411 Cell: 863-634-7185

From: Seth Nunes <snunes@cecenv.com>
Sent: Monday, January 27, 2020 4:56 PM

To: Stephen.Amirault@dep.state.fl.us; GloriaJean.Depradine@dep.state.fl.us; REarp@apopka.net; dep_cd@dep.state.fl.us

Cc: Sheree Grant <sgrant@wm.com>; Craig Pelton <cpelton@wm.com>; Parker, Eric (FL)

<EParker1@wm.com>; Amy Nunes <anunes@cecenv.com>; Jim Christiansen

<jchristi@cecenv.com>; Roman, Anthony <ARoman@wm.com>

Subject: Vista Landfill - Construction Notification Phase I 2020

Mr. Amirault:


On behalf of Vista Landfill, LLC (Vista), Carlson Environmental Consultants, PC is submitting this notification for gas collection system expansion at Vista Landfill Class III. In accordance with the 2/26/13 Solid Waste Modification (SO48-0165969-020, which incorporates -18, -21, and -22), Vista is proposing to install new vertical wells in Cell 5 and new horizontals in Cell 6.

Construction is scheduled to start on January 29, 2020. Upon completion of construction, Vista will submit a certification of completion to FDEP summarizing the construction. A copy of the updated site plan will be maintained on-site.

Best Regards,

Seth Nunes, P.E.
Principal
Carlson Environmental Consultants, PC
1511 Johnson Ferry Road, Suite 125
Marietta, GA 30062
Office: 678-388-0411

Cell: 863-634-7185

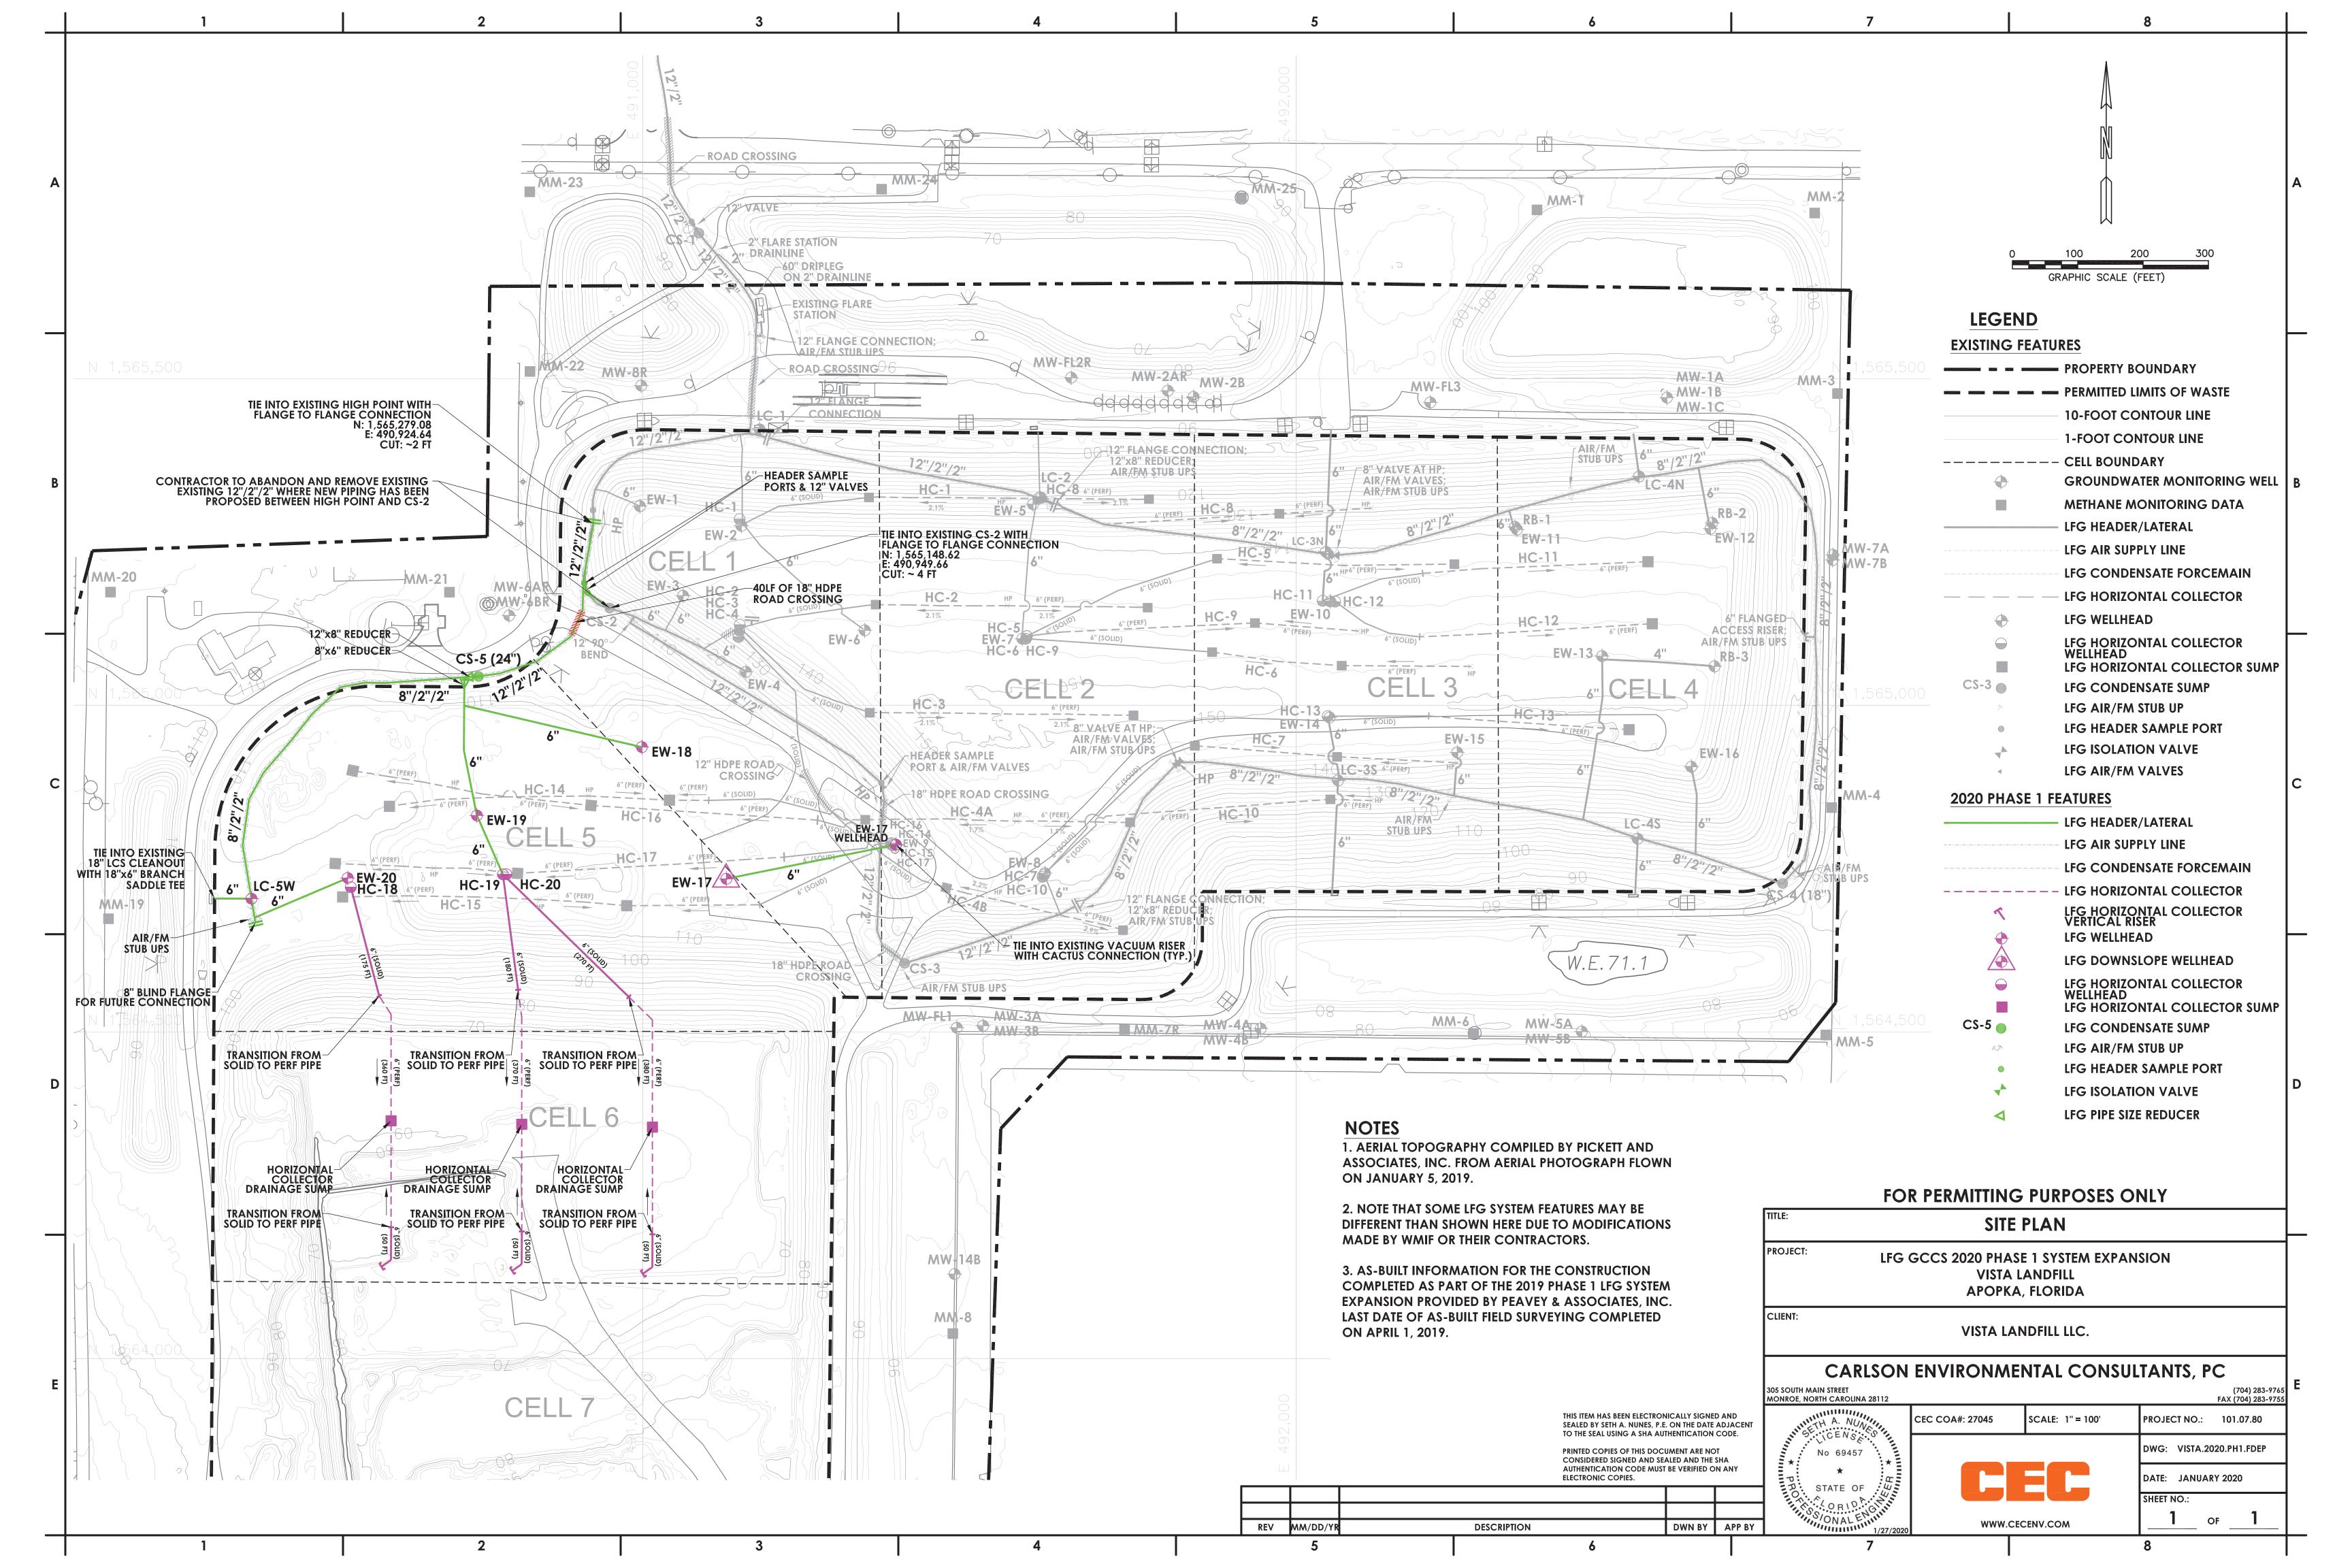



CONSTRUCTION DRAWINGS

LANDFILL GAS COLLECTION AND CONTROL SYSTEM 2020 SYSTEM EXPANSION VISTA LANDFILL - APOPKA, FL



OWNER:

VISTA LANDFILL LLC.

VISTA LANDFILL 242 W. KEENE ROAD APOPKA, FLORIDA 31537 (866) 909-4458

OWNER REPRESENTATIVE: CRAIG PELTON (954) 984-2000

ENGINEER:

CARLSON ENVIRONMENTAL CONSULTANTS, PC

305 SOUTH MAIN STREET MONROE, NORTH CAROLINA 28112 (704) 283-9765

CEC JOB NO. 101.07.80

JANUARY 2020

REV MM/DD/YR

INDEX OF SHEETS

SHEET NO.	DESCRIPTION
1	TITLE SHEET
2	EXISTING CONDITIONS
3	SITE PLAN
4	DETAILS - 1
5	DETAILS - 2
6	DETAILS - 3
7	DETAILS - 4


ISSUED FOR CONSTRUCTION


TTLE:		TITLE	SHEET					
ROJECT:	LFG GCCS 2020 PHASE 1 SYSTEM EXPANSION VISTA LANDFILL APOPKA, FLORIDA							
CLIENT:	VISTA LANDFILL LLC.							
CAR 05 SOUTH MAIN STRE	ET	ENVIRONME	NTAL CON	SULTANTS, PC (704) 283-97 FAX (704) 283-97				
NIGETH A. A	IUNIA NESTA	CEC COA#: 27045	SCALE: NTS	PROJECT NO.: 101.07.80				
No 694	57			DWG: VISTA.2020.PH1.1				
* STATE	OF J		FC	DATE: JANUARY 2020				
ORV	D. A	www.c	ECENV.COM	SHEET NO.:				


SEALED BY SETH A. NUNES, P.E. ON THE DATE


DESCRIPTION


DWN BY APP BY

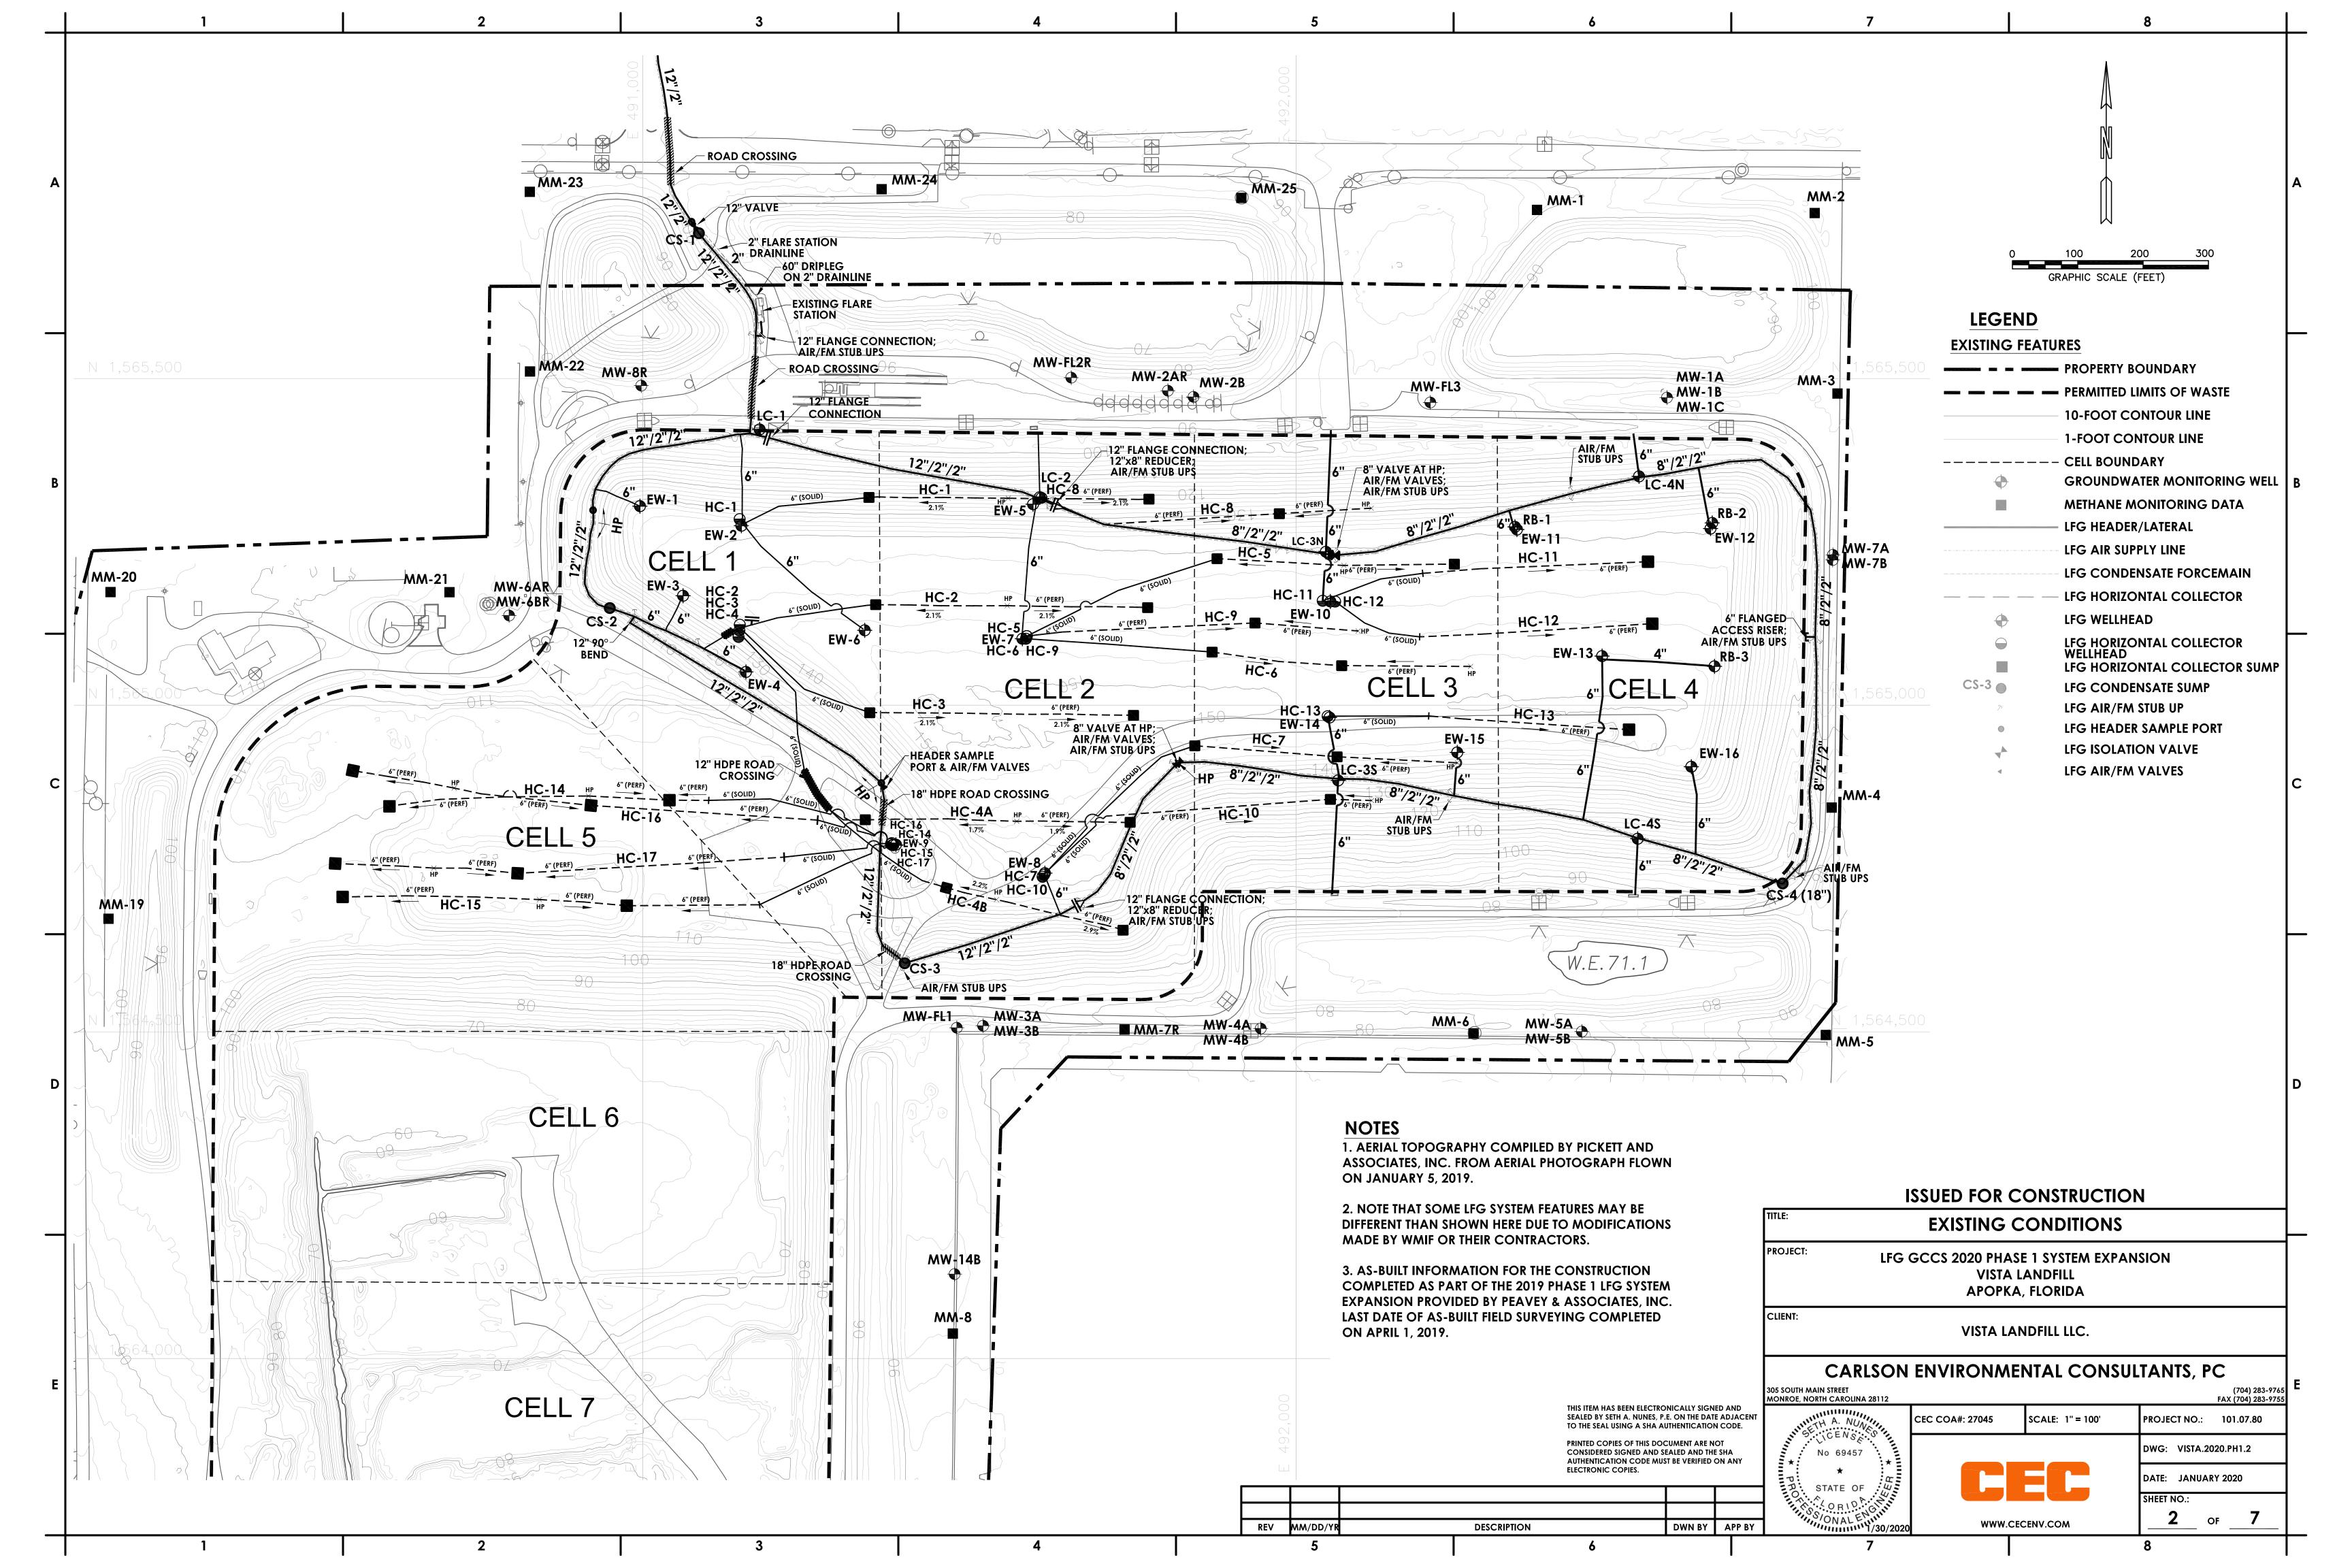


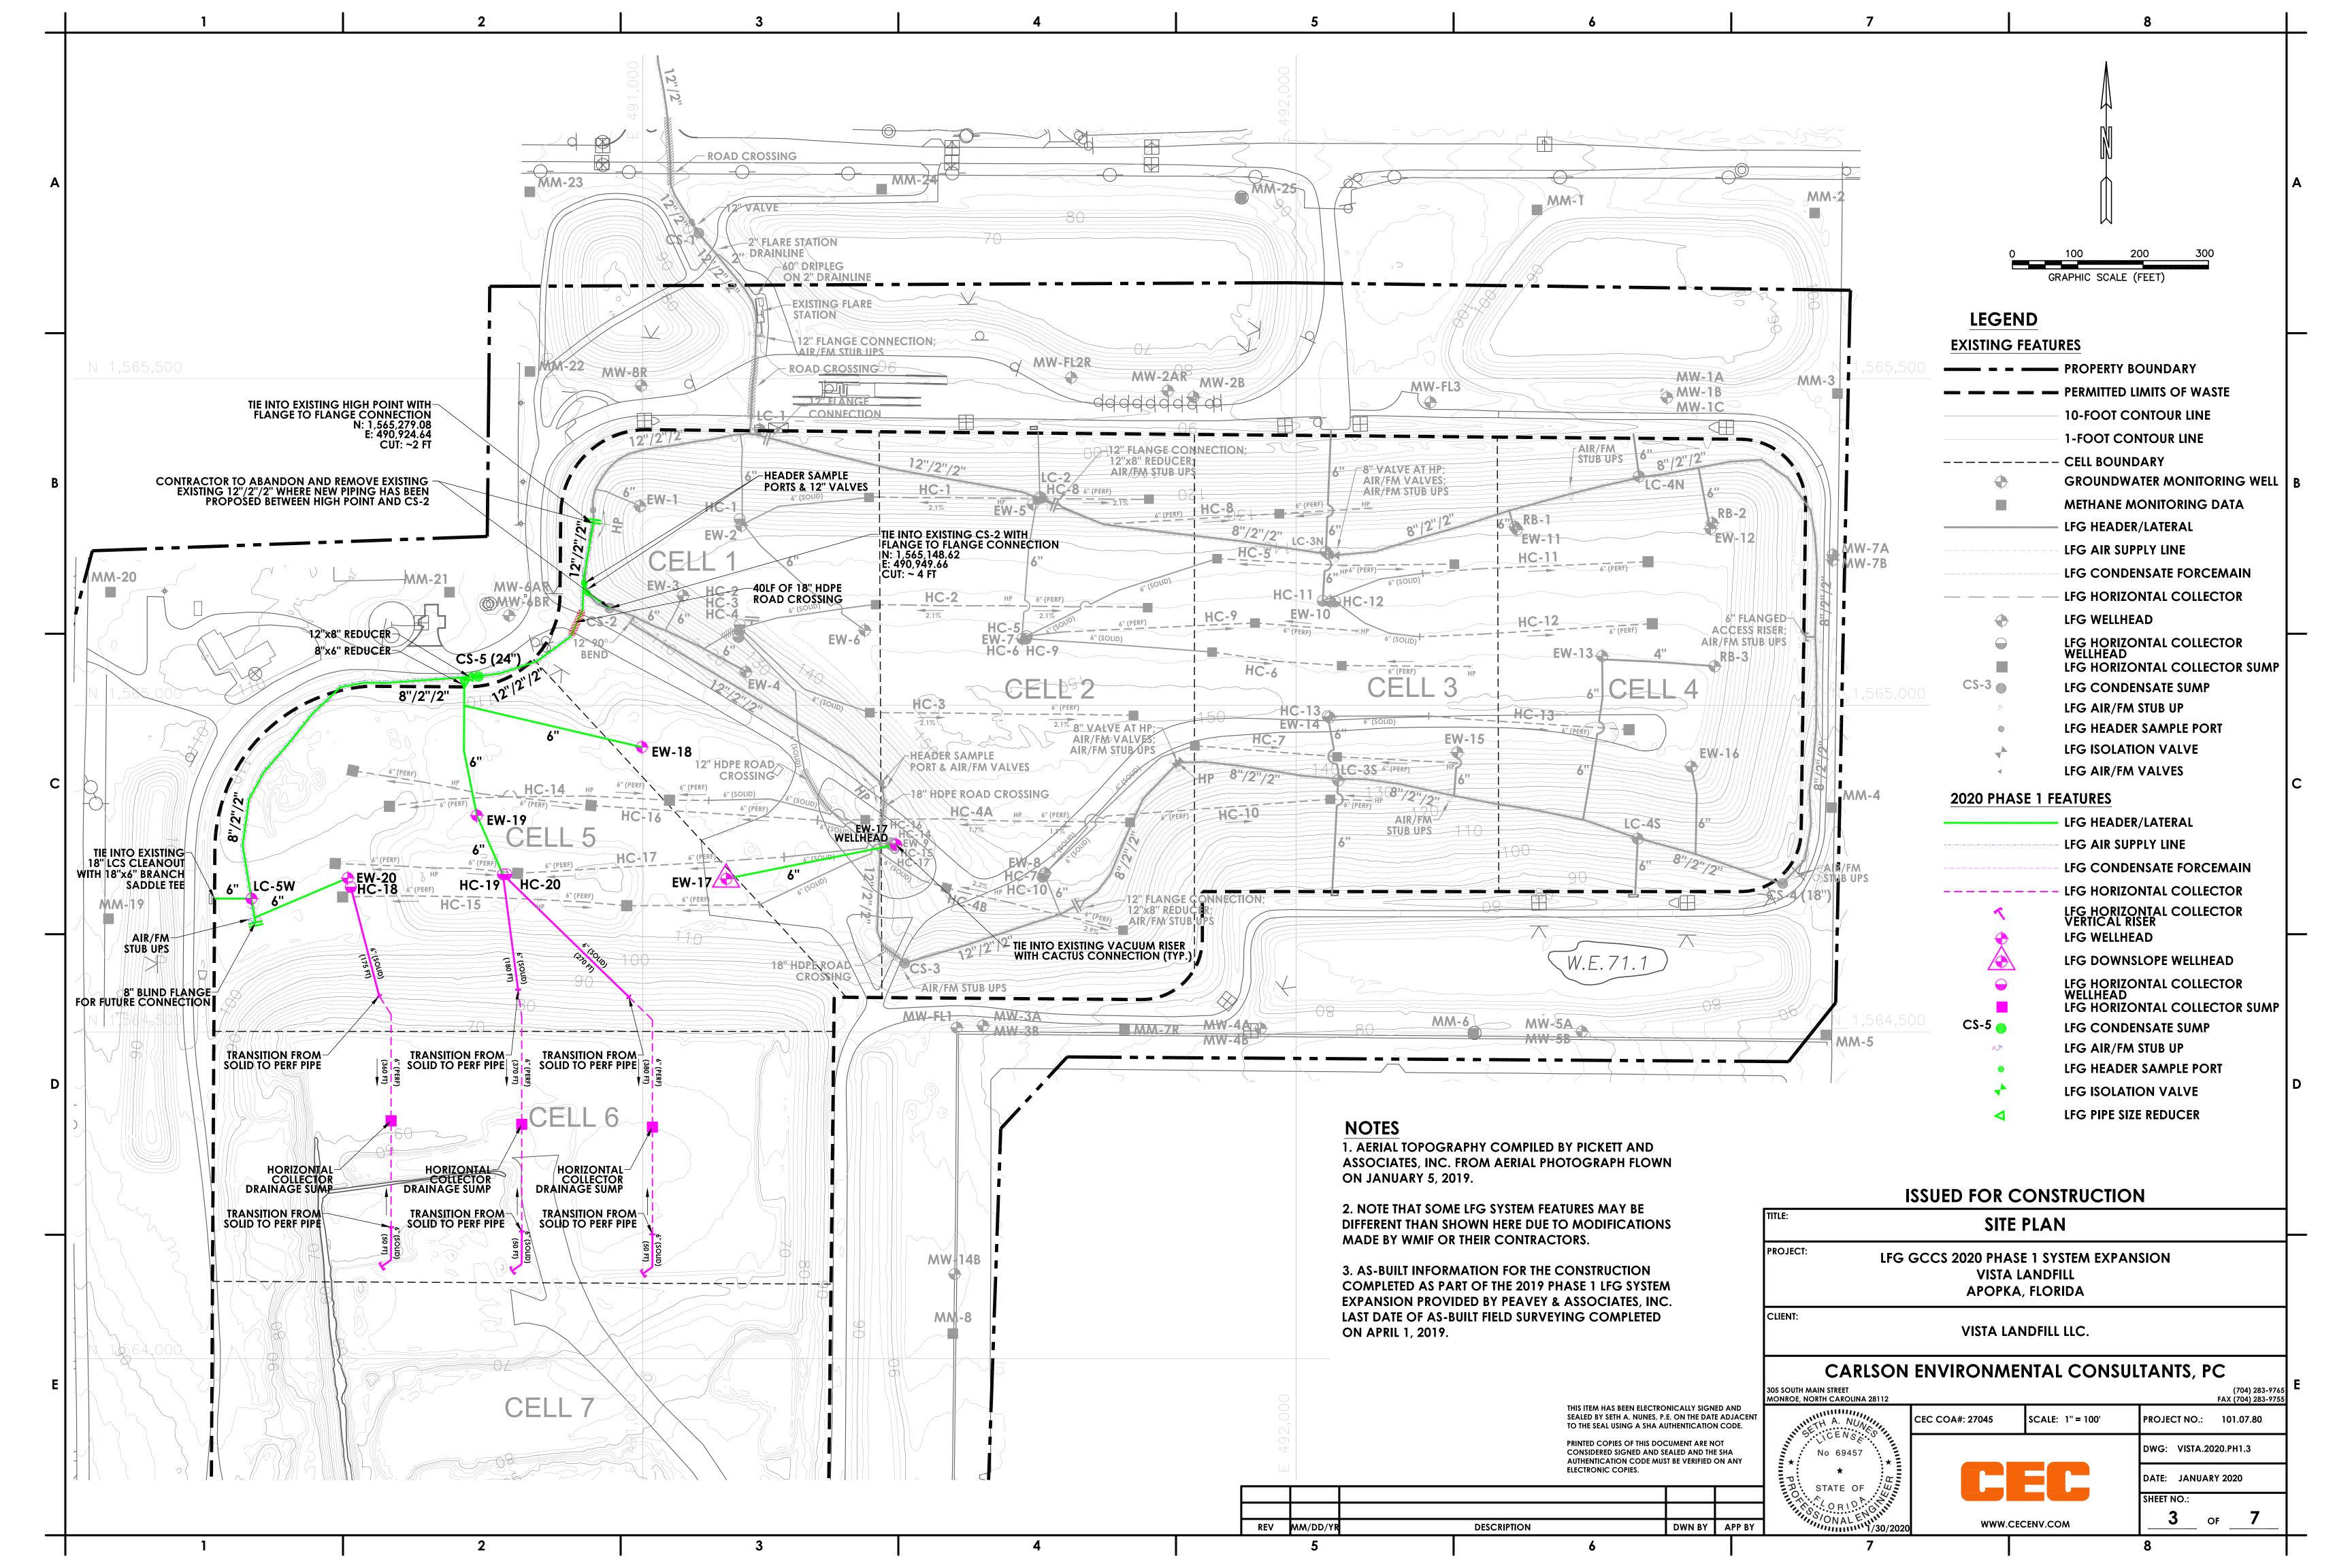

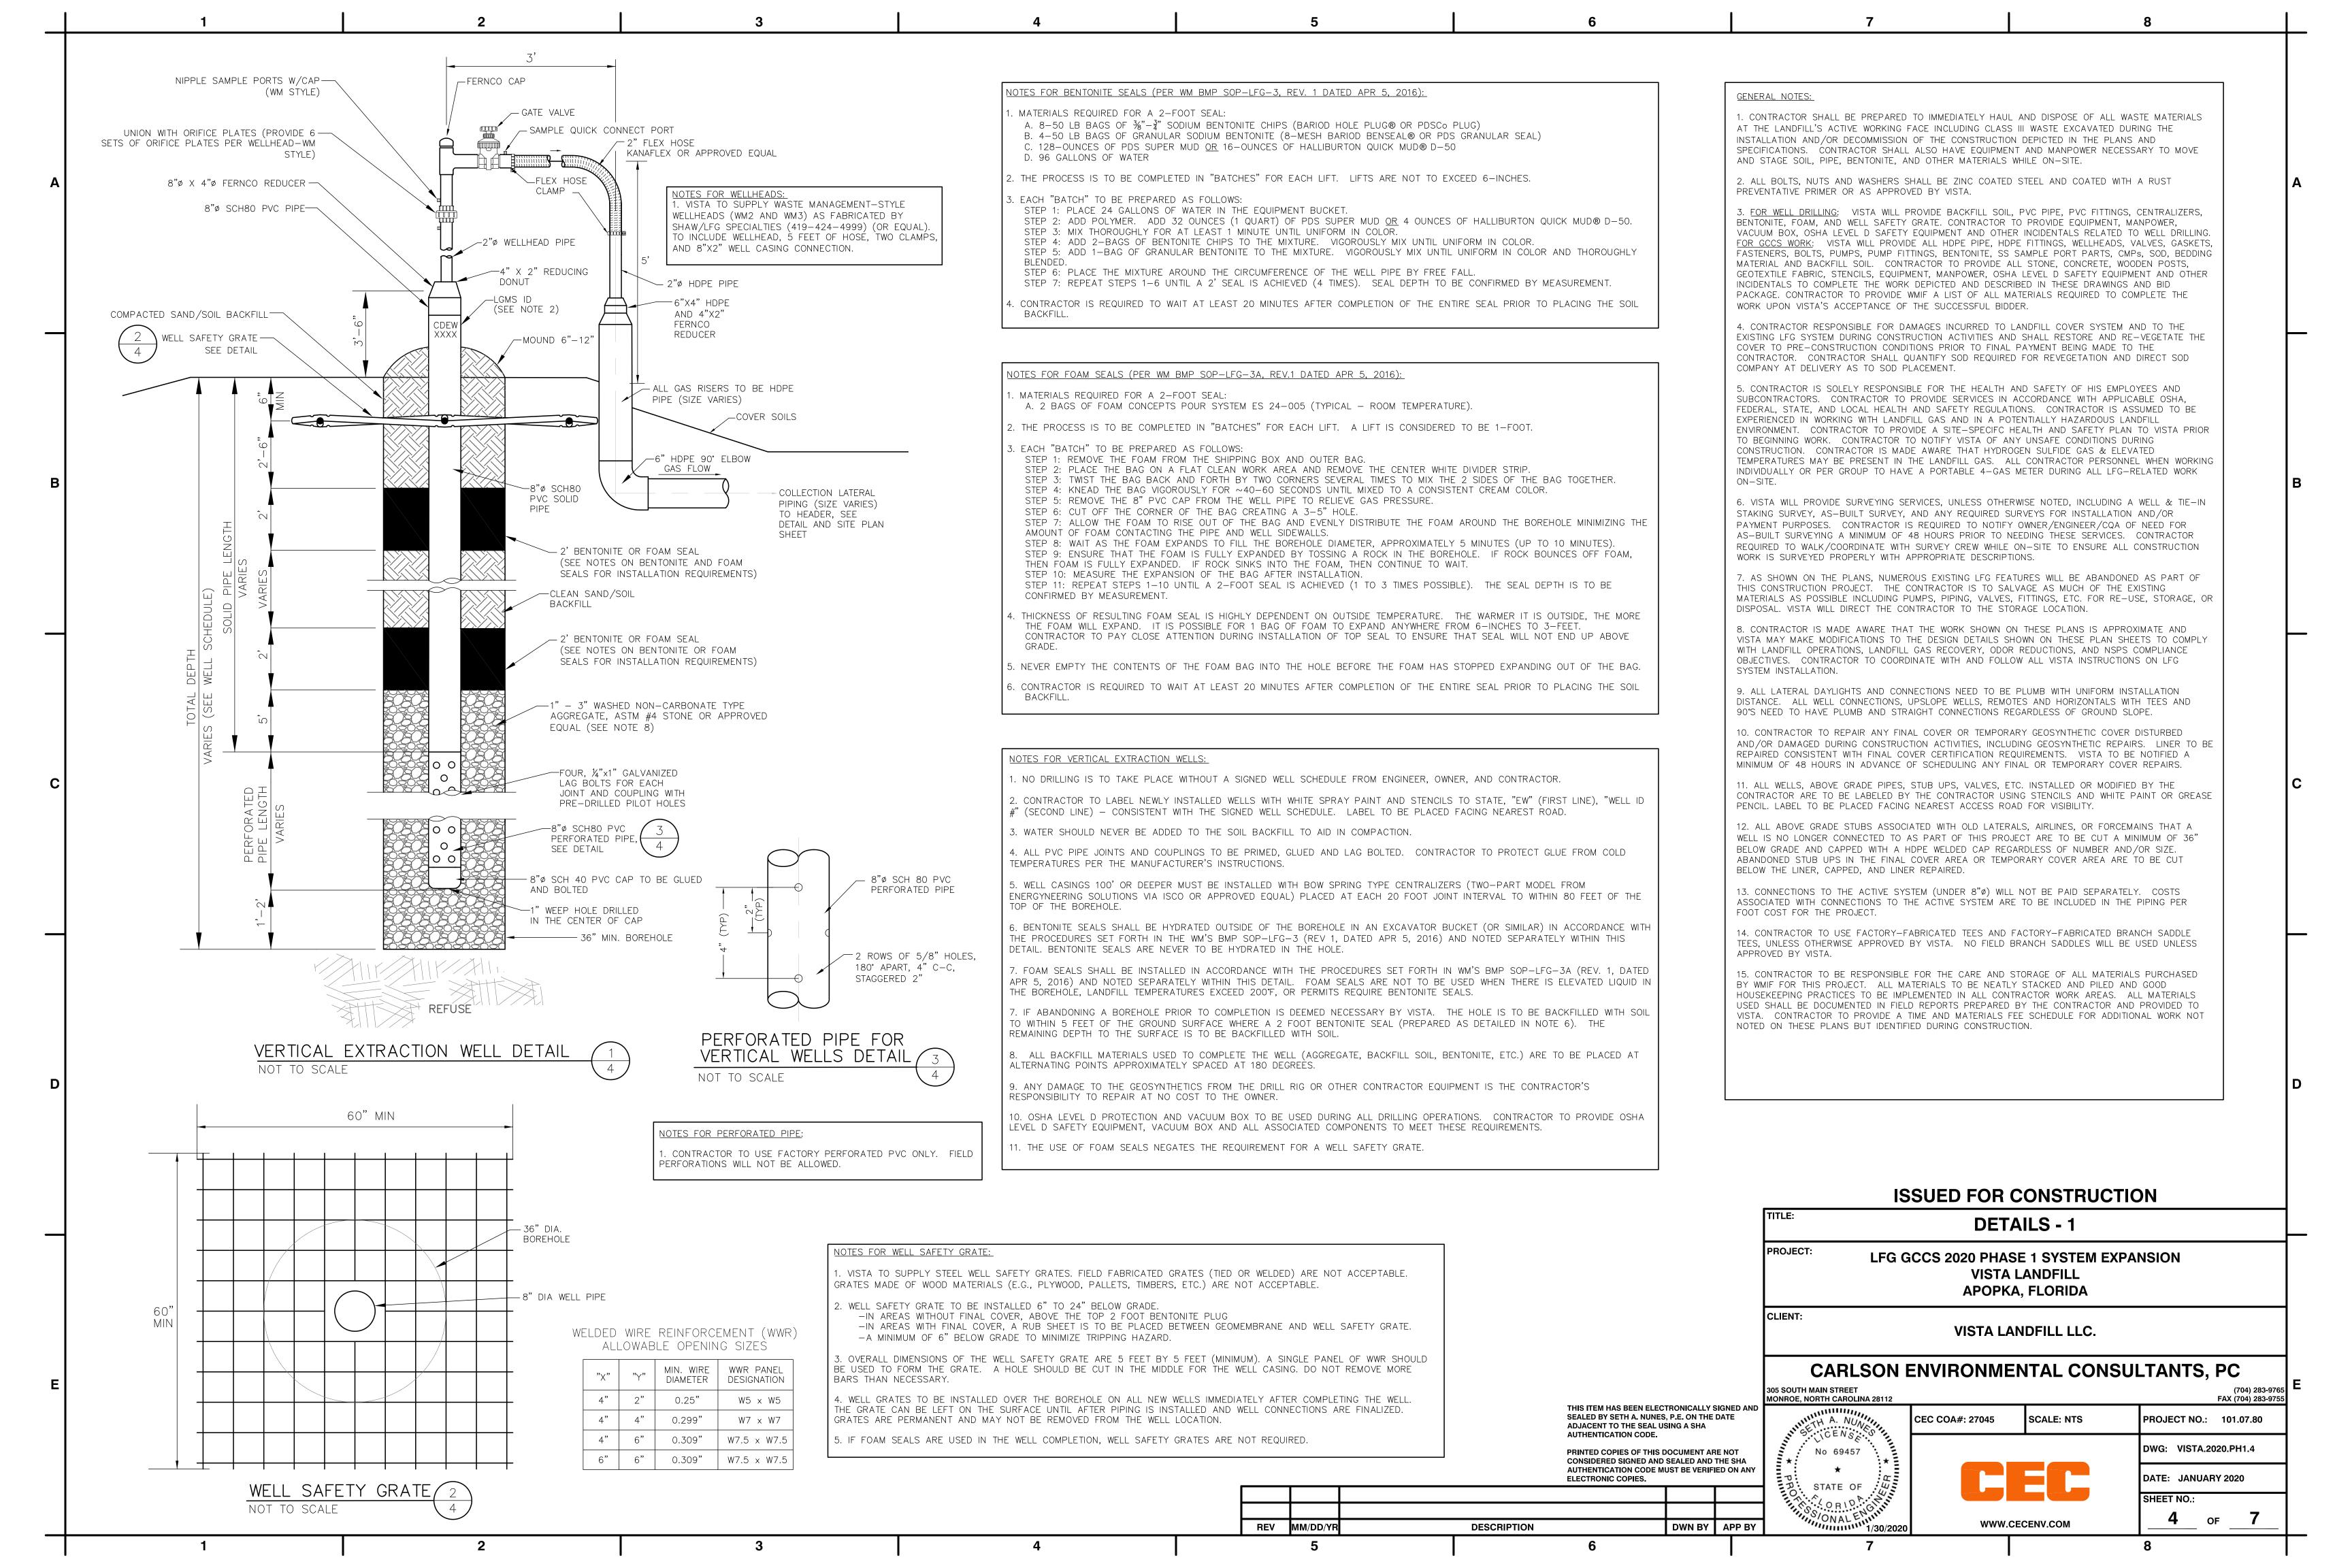

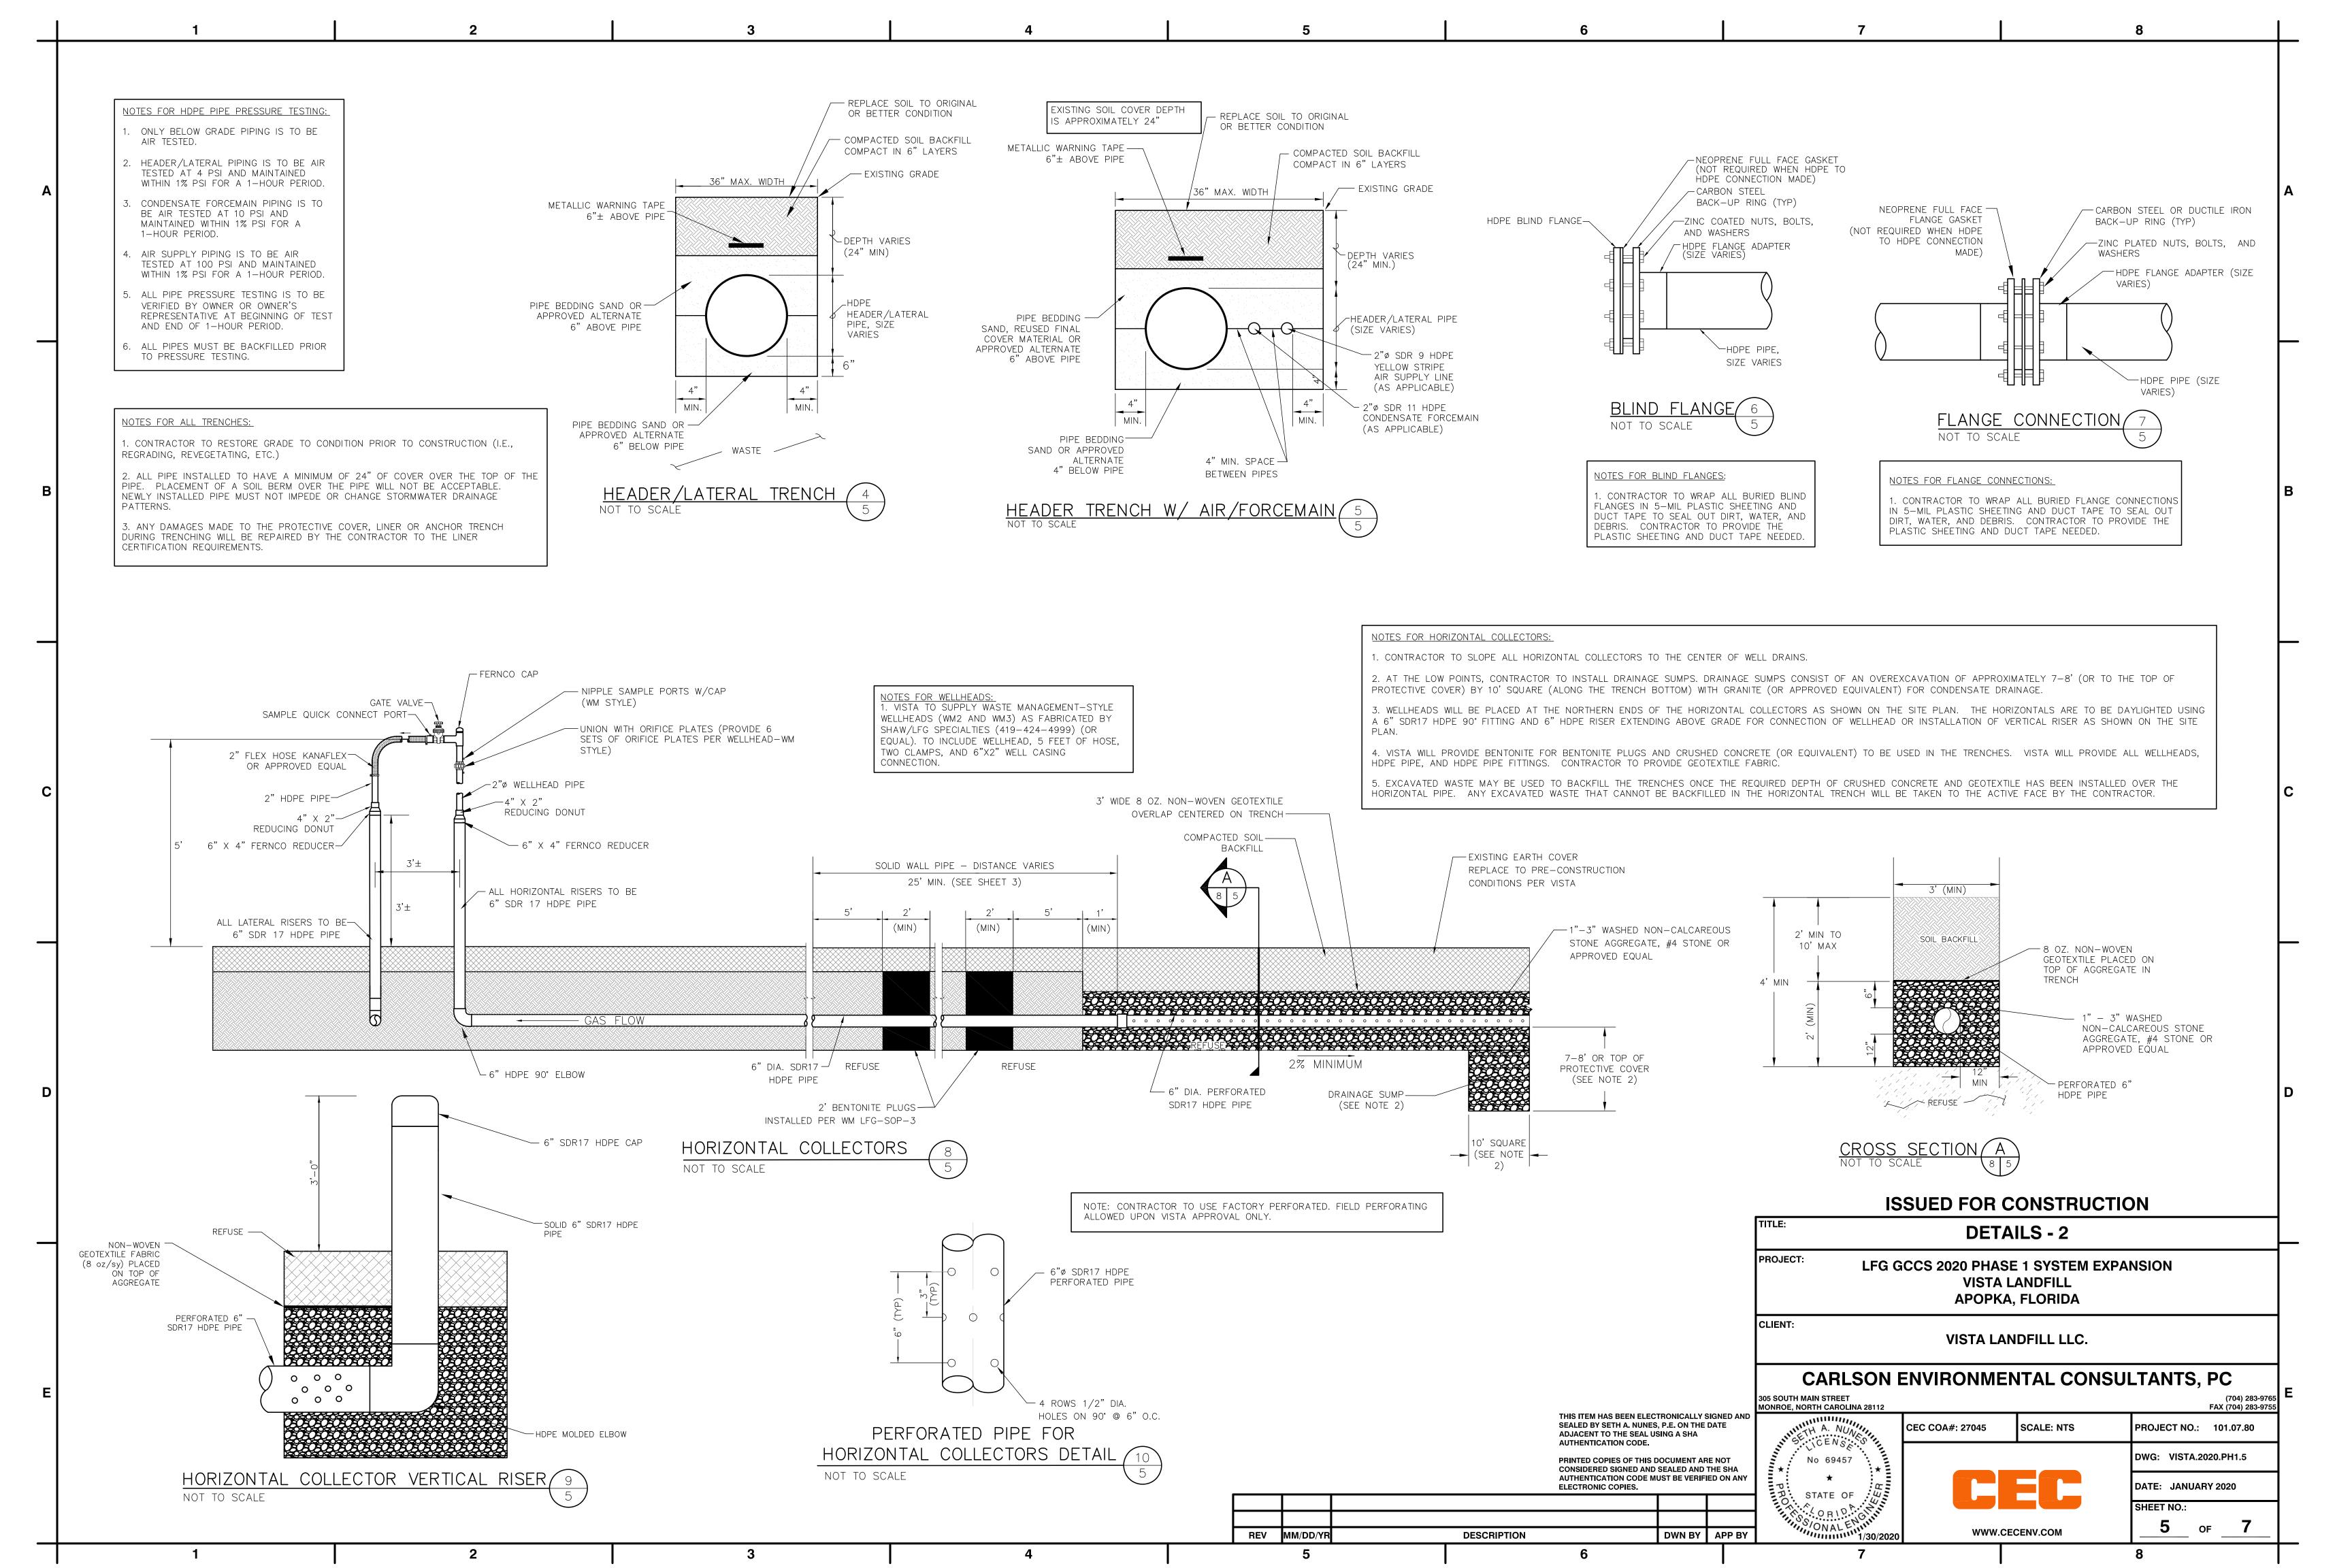

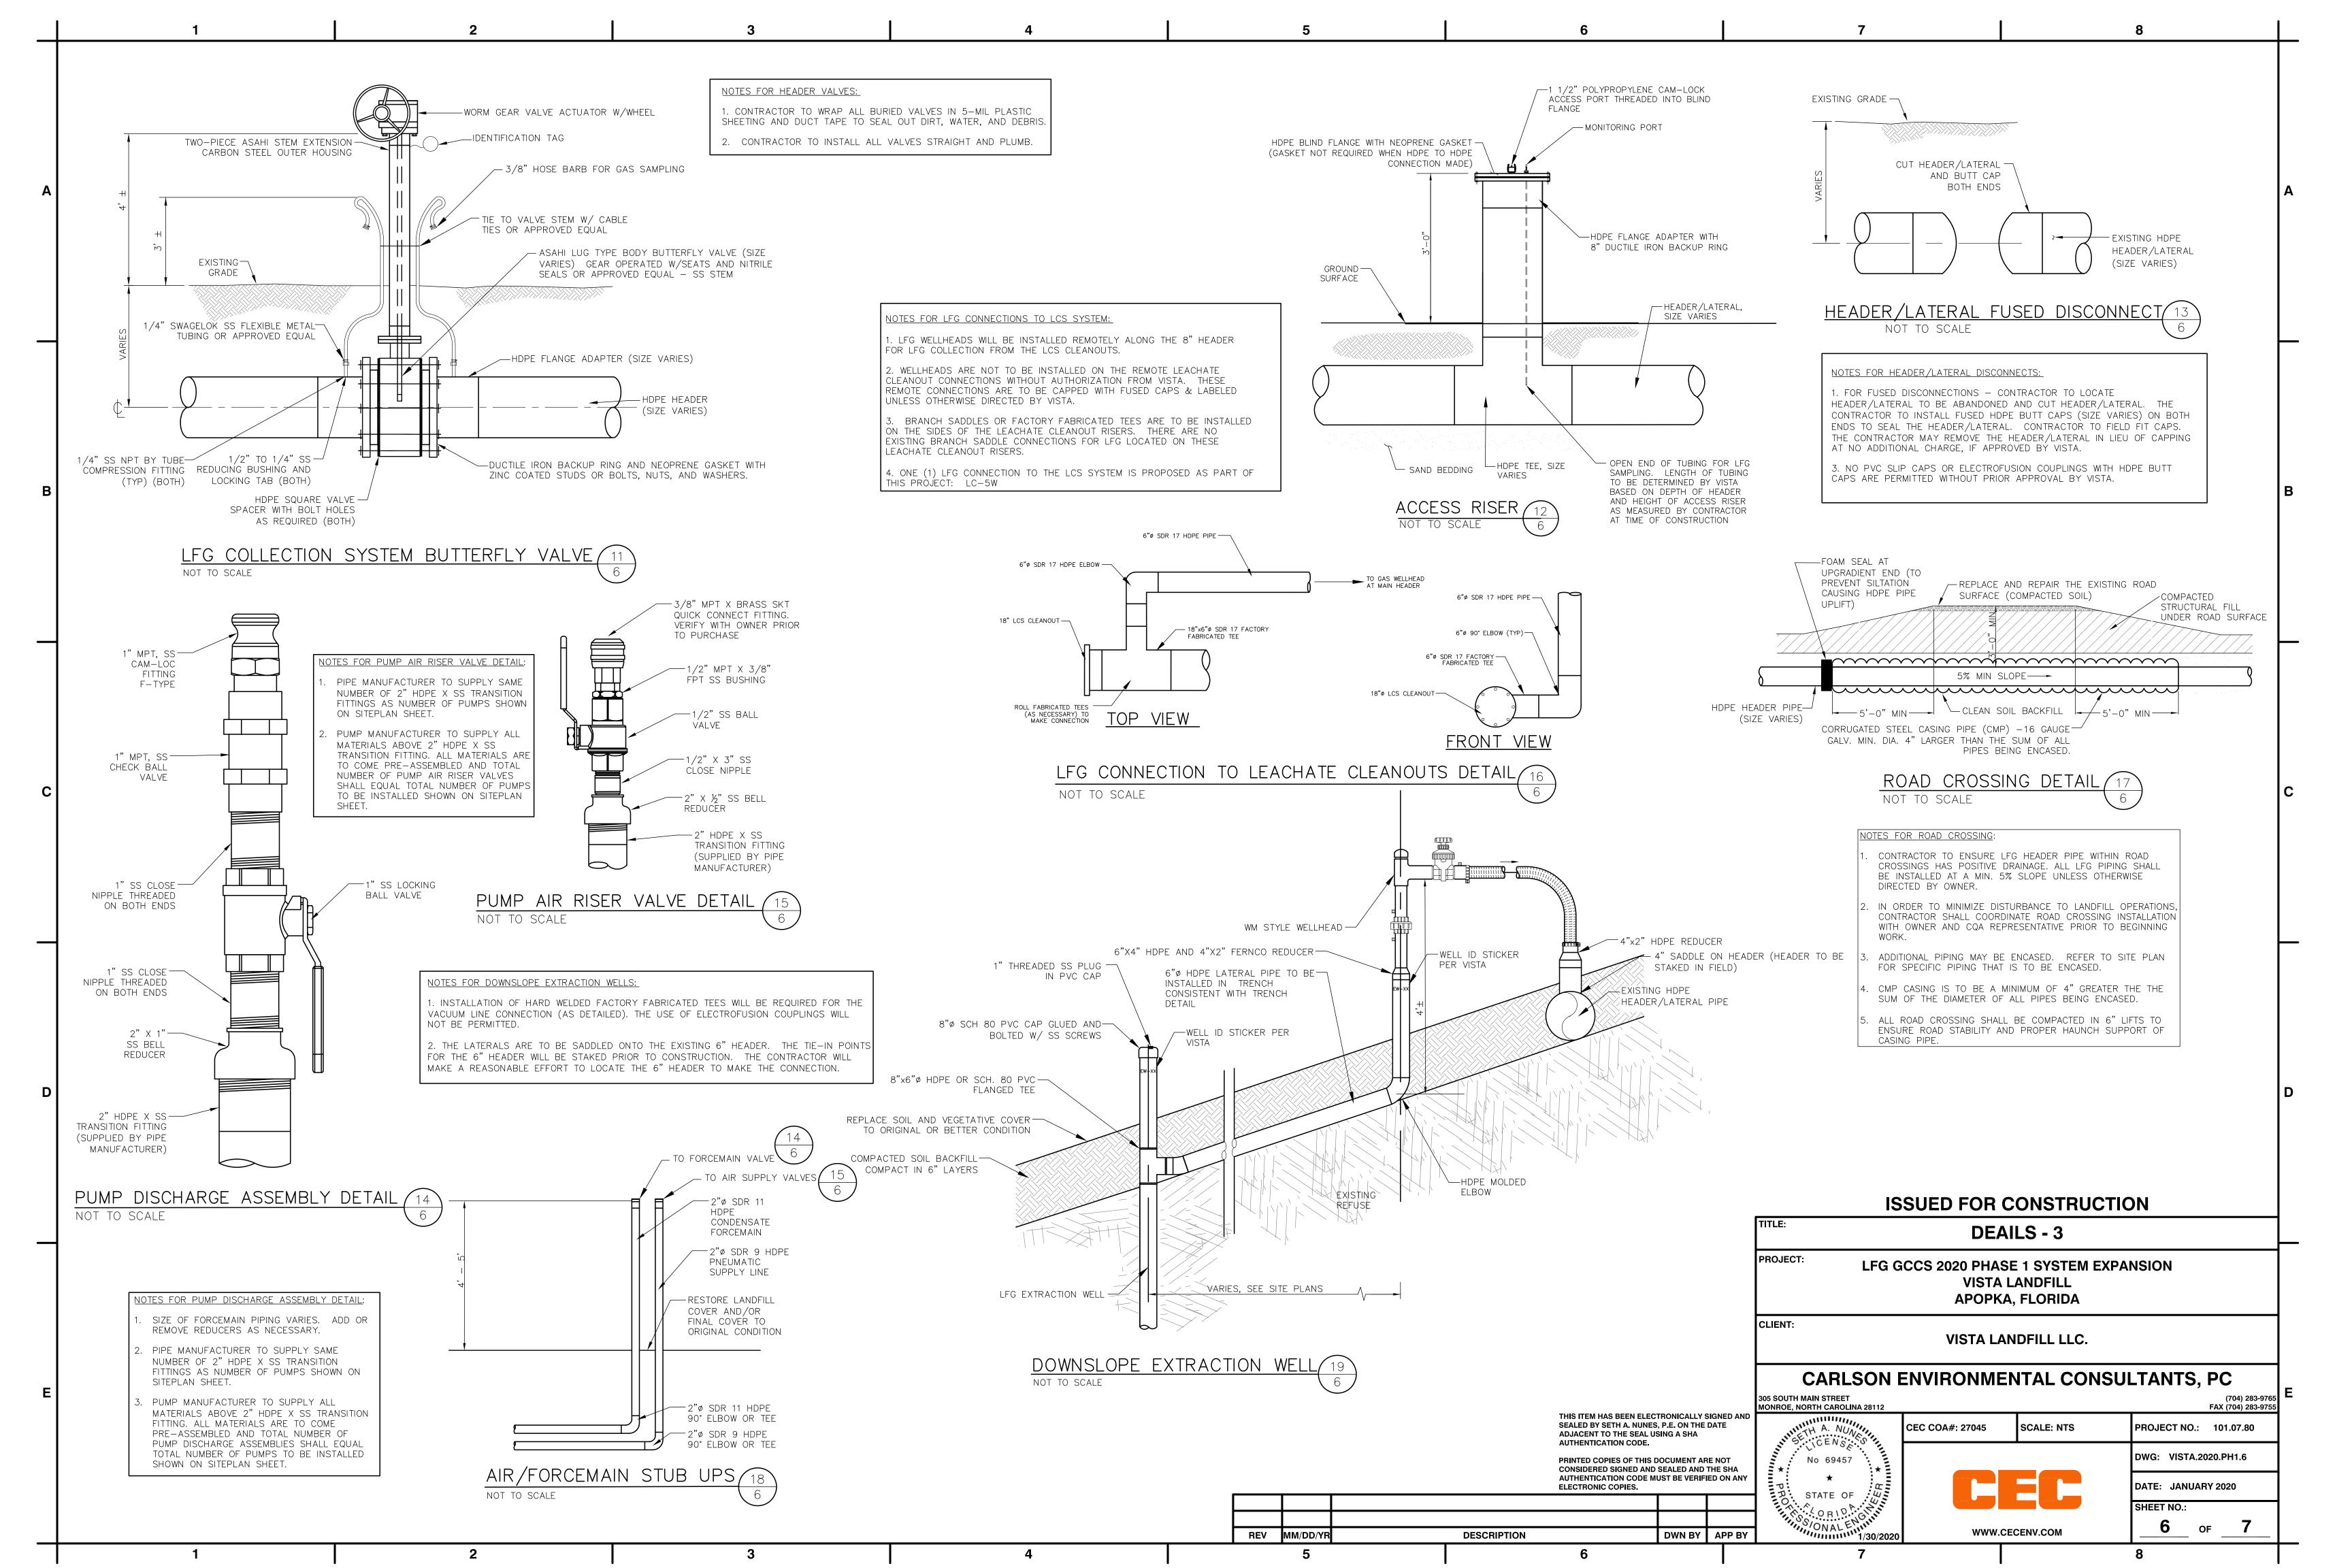

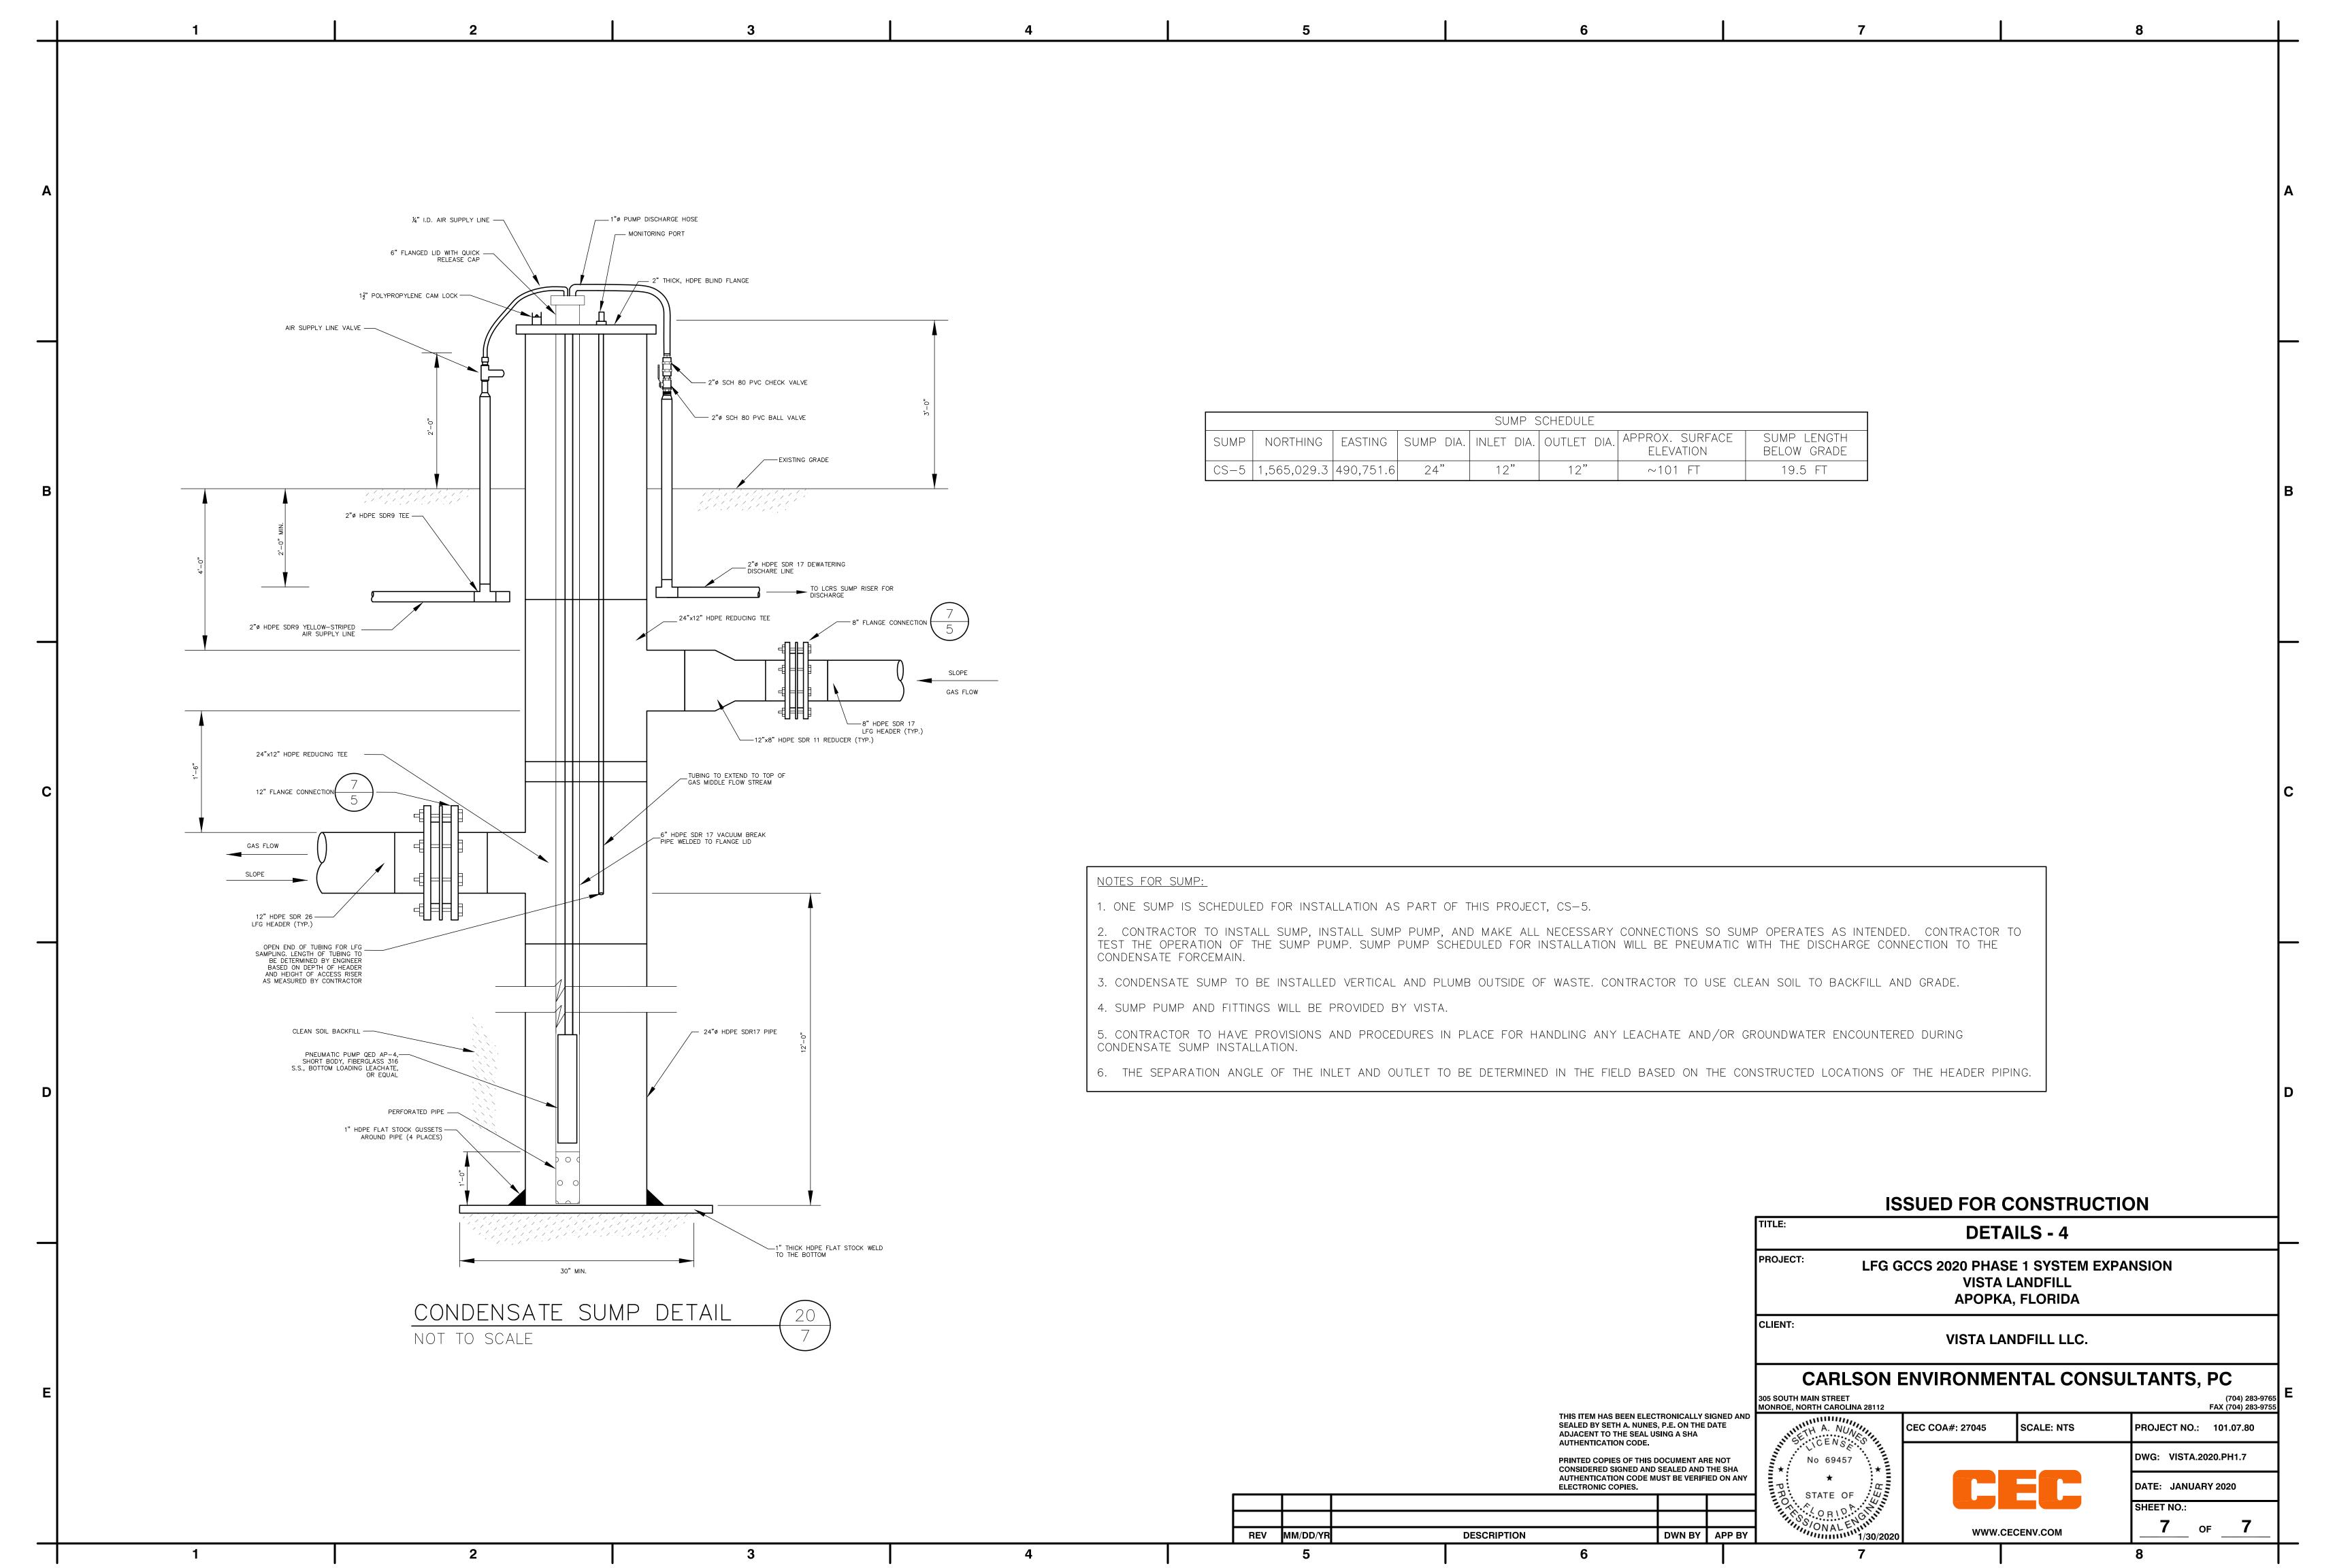

ATTACHMENT B DAILY FIELD LOGS



LANDFILL GAS, AIR PERMITTING, AND REGULATORY COMPLIANCE SERVICES

Site:	Vista	Temperature:	92/73	Time Onsite:	6:00 am
Date:	7-6-2020	Weather:	Cloudy; Rain PM	Time Leaving:	6:00 pm

Labor – Employees	Hours		Labor - Employees	Hours		
CQA – T. Gravel	12					
Piping – A. Diaz + 6	12					
EQUIPMENT			EQUIPMENT			
2 – Bell trucks			1 – 650 Bull Dozer			
1 – 235 Excavator			1 – 210 Excavator			
1 – 9500 Skid Steer			1 – 4x4 Side x Side			
WORK PERFORMED – Description of Item		CONTRACTOR				
50' solid 150'perforated HC-20			CEC			

Notes:

Arrive on site and set up lay down area.

Weld 2 lifts of 6" perforated pipe and 400' of 6" solid pipe.

Met with the site at 8:00 am for Pre-con meeting.

Start on the south side of HC-20, excavate from 6" riser to just before sump.

Weld 50' of 6" solid and 150' of 6" perforated.

Bed trench with 6" of #57 stone and install pipe in trench.

Cover pipe with 12" of #57 stone.

Cover stone with 10 oz. non-woven fabric.

Backfill trench with waste and haul soil to restore area.

Witness risers were installed to get survey.



LANDFILL GAS, AIR PERMITTING, AND REGULATORY COMPLIANCE SERVICES

Site:	Vista	Temperature:	90/75	Time Onsite:	6:00 am
Date:	7-7-2020	Weather:	Overcast; Rain PM	Time Leaving:	6:00 pm

Labor – Employees	Hours		Labor - Employees	Hours		
CQA – T. Gravel	12					
Piping - A. Diaz + 6	12					
EQUIPMENT			EQUIPMENT			
2 – Bell trucks			1 – 650 Bull Dozer			
1 – 235 Excavator		1 – 210 Excavator				
1 – 9500 Skid Steer			1 – 4x4 Side x Side			
WORK PERFORMED – Description of Item		CONTRACTOR				
240' solid welded to 150' perforated of HC-20			CEC			

Notes:

Started excavating 10'x10'x7' deep drainage sump for HC-20.

Continued trenching for 6" perforated and 6" solid from sump to EW-19.

Filled sump with stone and bedded trench with 6" of #57 stone.

Installed 240' of 6" perforated, welded it on to the 150' perforated that was installed on 7-6-2020.

Installed 360' of 6" solid with a riser at well EW-19.

Welded solid to perforated and placed two bentonite seals 25' from transition to perforated.

Backfilled solid pipe with clean soil.

Covered 6" perforated with 12" of #57 stone.

Covered stone with 10 oz new woven fabric.

Backfilled with waste and hauled clean soil to restore area.



LANDFILL GAS, AIR PERMITTING, AND REGULATORY COMPLIANCE SERVICES

Site:	Vista	Temperature:	89/76	Time Onsite:	6:00 am
Date:	7-8-2020	Weather:	Overcast; Rain PM	Time Leaving:	6:00 pm

Labor – Employees	Hours		Labor - Employees	Hours			
CQA – T. Gravel	12						
Piping – A. Diaz + 6	12						
EQUIPMENT	EQUIPMENT		EQUIPMENT				
2 – Bell trucks			1 – 650 Bull Dozer				
1 – 235 Excavator		1 – 210 Excavator					
1 – 9500 Skid Steer			1 – 4x4 Side x Side				
WORK PERFORMED – Description of Item		CONTRACTOR					
300' solid 360' perforated HC-19			CEC				

Notes:

HC-19 - Excavate trench from EW-19 down to toe of slope 250'.

Continue to low point at 2% and dig drainage sump 10'x10'x7'.

Trench from low point at 2% to high point to the south.

Bed 360' of trench with 6" of #57 stone.

Fill drainage sump with #57 stone.

Install 250' of solid pipe with riser at EW-19.

Install 360' of perforated pipe and weld it to solid on both ends.

50' of solid was installed on south end with 6" riser.

Place 12" of #57 stone over the top of perforated pipe.

Cover stone with 10 oz non-woven fabric.

Place double bentonite seal 25' from solid to perforated transition.

Backfill solid pipe with clean soil and backfill perforated pipe with waste.

Haul clean soil to restore area.



LANDFILL GAS, AIR PERMITTING, AND REGULATORY COMPLIANCE SERVICES

Site:	Vista	Temperature:	94/78	Time Onsite:	6:00 am
Date:	7-9-2020	Weather:	Partly Cloudy	Time Leaving:	6:00 pm

Labor – Employees	Hours		Labor - Employees	Hours		
CQA – T. Gravel	12					
Piping – A. Diaz + 6	12					
EQUIPMENT	EQUIPMENT		EQUIPMENT			
2 – Bell trucks			1 – 650 Bull Dozer			
1 – 235 Excavator		1 – 210 Excavator				
1 – 9500 Skid Steer			1 – 4x4 Side x Side			
WORK PERFORMED – Description of Item		CONTRACTOR				
200' solid 295' perforated HC-18			CEC			

Notes:

HC-18 – Excavate trench from EW-20 to toe of slope 200'.

Continue trenching at 2% to drainage sump.

Dig sump 10'x10'x7' and go to high point at 2% and end with butt cap.

Grade was too low to build as designed so there was no solid pipe installed on the south end of HC-18.

Bed 295' with 6" of #57 stone.

Install 200' of solid pipe with riser at EW-20 and install 295' of perforated pipe and weld together.

Cover 295' of perforated pipe with 1' of #57 stone and cover stone with 10 oz non-woven fabric.

Install double bentonite seal 25' from solid to perforated transition.

Backfill solid pipe with clean soil and backfill perforated pipe with waste.

Haul clean soil to restore area.

Stencil well numbers on HC-18, 19, 20.

Order well heads and ferncos.

ATTACHMENT C CONSTRUCTION PHOTOGRAPHS

HC-20 Trench with Aggregate



HC-20 Trench with 6" Perforated Pipe and Aggregate



HC-20 South Vertical Riser




HC-20 Fabric Over 6" Perforated Pipe





HC-20 Installing Fabric Over 6" Perforated Pipe

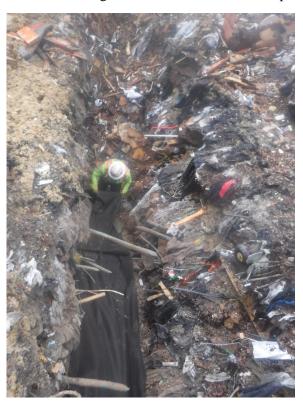

HC-20 Solid to Perforated Pipe Transition



HC-19 and HC-20 6" Solid Pipe



HC-19 and HC-20 Northern Vertical Risers and EW-19






HC-19 and HC-20 6" Solid Pipe Diverging Point



HC-19 Solid to Perforated Pipe Transition



HC-19 Aggregate Sump

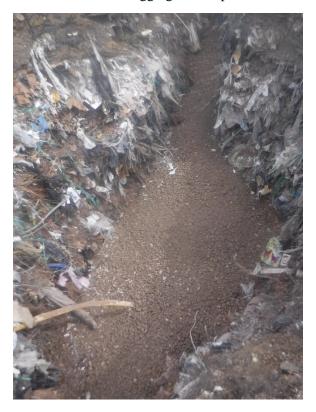

HC-19 Fabric Over Aggregate Sump





HC-18 Bentonite Seal at Solid to Perforated Pipe Transition



HC-18 Survey Riser



HC-18 In Trench



HC-18 South End with Butt Cap






HC-18 Wellhead

HC-19 and HC-20 Wellheads




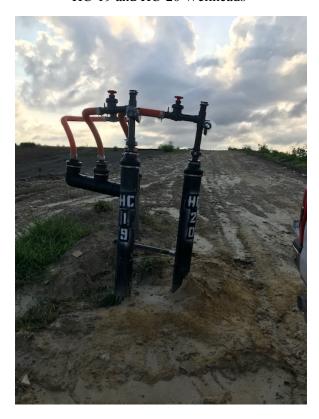



AS-BUILTS



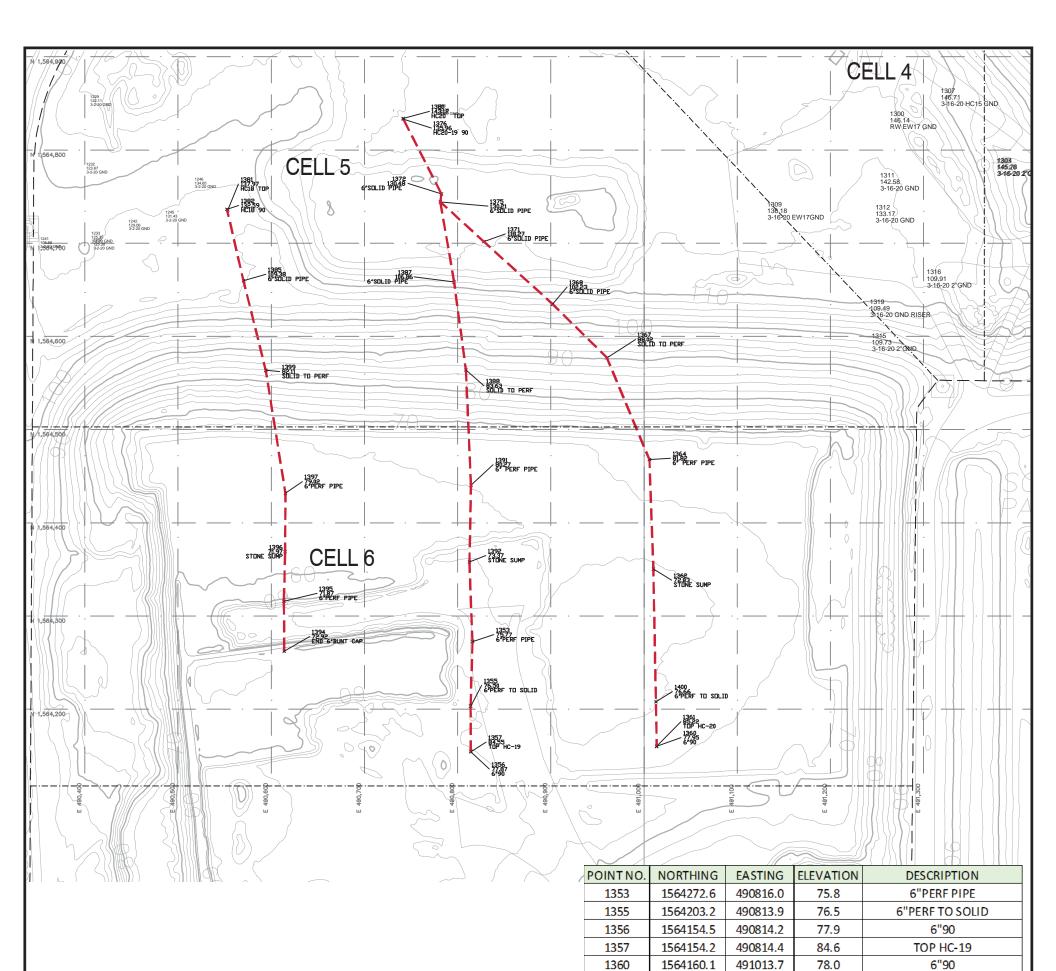



PROPERTY ADDRESS:

242 WEST KEENE ROAD APOPKA, FL 32703

SURVEYOR'S NOTES:

- 1.) North, the grid, and the coordinates shown hereon are referenced to the East Zone of the Florida State Plane Coordinate System, NAD 83, 1990
- 2.) Elevations are to National Geodetic Vertical Datum of 1929.
- 3.) This as-built survey was prepared to show the installed landfill gas.

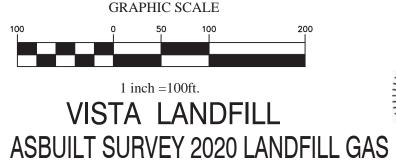

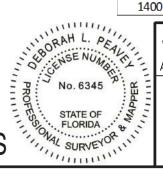

CLIENT: WASTE MANAGEMENT 242 WEST KEENE ROAD APOPKA, FL 32703

1564160.0

1564350.2

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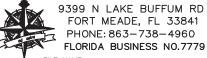
82.1

76.7

Deborah Digitally signed by Deborah L. Peavey Date: 2020.07.26 14:30:48 -04'00' 7/9/2020 SURVEY DATE

DEBORAH L. PEAVEY, P.S.M. FLORIDA REGISTRATION NO.6345

Peavey & Associates SURVEYING & MAPPING PA



FILE NAME: 1694 2020 wm vista gas asbuilt-rev

TOP HC-20

STONE SUMP

6" PERF PIPE

SOLID TO PERF **6"SOLID PIPE**

6"SOLID PIPE

6"SOLID PIPE

6"SOLID PIPE

HC20-19 90

HC20 TOP HC18 TOP

HC18 90

6"SOLID PIPE

6"SOLID PIPE

SOLID TO PERF

6" PERF PIPE

STONE SUMP

END 6"BUTT CAP

6"PERF PIPE

STONE SUMP

6"PERF PIPE

SOLID TO PERF

6"PERF TO SOLID



