


# HARDEE COUNTY LANDFILL PHASE II SECTION II EXPANSION CONSTRUCTION DRAWINGS

BOARD OF COUNTY COMMISSIONERS
HARDEE COUNTY, FLORIDA

AUGUST 2012

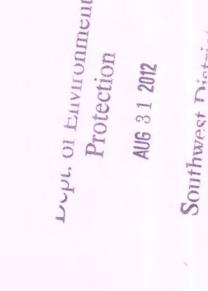

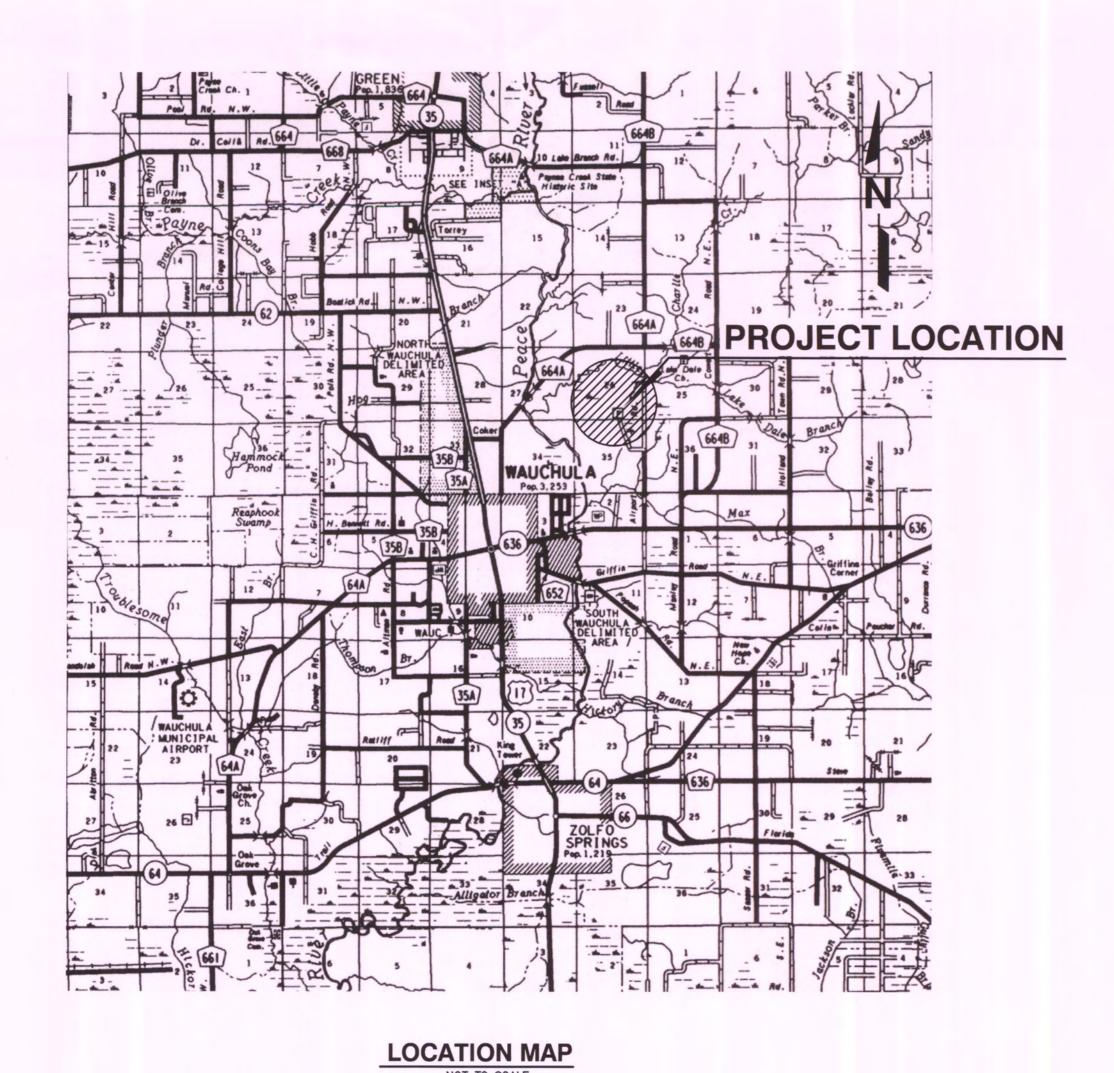

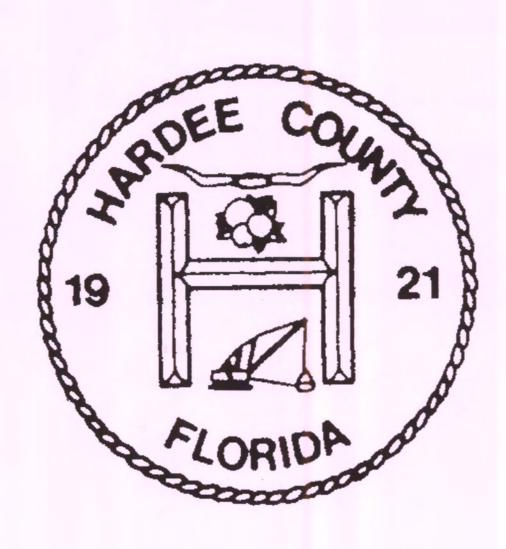

# **SCS ENGINEERS**

STEARNS, CONRAD AND SCHMIDT CONSULTING ENGINEERS, INC.

4041 PARK OAKS BLVD., SUITE 100 TAMPA, FLORIDA 33610 PH (813) 621-0080 FAX NO. (813) 623-6757 WWW.SCSENGINEERS.COM FLORIDA CERTIFICATE OF AUTHORIZATION NO. 00004892 SCS PROJECT NO. 09199033.23

# **DRAWING INDEX**


		DRAWING INDEX
DRAWING	NO.	DRAWING TITLE
1	-	COVER
2	-	ABBRÉVIATIONS AND GENERAL NOTES
3	-	OVERALL AERIAL SITE PLAN - (JANUARY 2011)
4	-	EXISTING CONDITIONS - AERIAL PHOTOGRAPH (04/03/2012)
5	-	<b>EXISTING CONDITIONS NORTH - TOPOGRAPHIC SURVEY (04/03/2012)</b>
6	-	<b>EXISTING CONDITIONS SOUTH - TOPOGRAPHIC SURVEY (04/03/2012)</b>
7	-	PROJECT AREA EXISTING CONDITIONS SITE PLAN
8	-	TOP OF SUBGRADE - BOTTOM CELL GRADING SITE PLAN
9	-	LEACHATE COLLECTION SYSTEM - SITE PLAN
10	-	TOP OF PROTECTIVE COVER - BOTTOM CELL GRADING SITE PLAN
11	-	SECTIONS - BOTTOM CELL
12	-	FINAL CLOSURE SITE PLAN
13	-	SECTIONS - FINAL CLOSURE
14	-	PIPING DETAILS - BOTTOM CELL
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17	-	SUMP AND SIDESLOPE RISER DETAILS
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FLORIDA DEPARTMENT OF ENVIRONMENTAL PROTECTION AUG 3 1 2012
SOUTHWEST DISTRICT



### **ABBREVIATIONS:**

	<del></del>		
<b>@</b> ×	AT ANOLE	LBR	LIMEROCK BEARING RATIO
<u>≺</u> € Ø	ANGLE	LF	LINEAR FEET
<u>ዋ</u>	CENTERLINE DIAMETER	MAX	MAXIMUM
ÁΒ	ANCHOR BOLT	MES	MITERED END SECTION
ADD'L	ADDITIONAL	MFR	MANUFACTURER
ANCH	ANCHOR	MIN	MINIMUM
APPROX	APPROXIMATE	MH	MANHOLE
ВМ	BEAM	MW	MONITORING WELL
BOT	BOTTOM	N	NORTH
BP	BASE PLATE	NE	NORTHEAST
C/C	CENTER TO CENTER	NIC	NOT IN CONTRACT
CIP	CAST IRON PIPE	NO. NTS	NUMBER NOT TO SCALE
CL	CENTER LINE	NW NI3	NORTHWEST
CLJ	CONTROL JOINT	OC	ON CENTER
CLR	CLEAR	OPNG	OPENING
CMP	CORRUGATED METAL PIPE	PC	POINT OF CURVATURE
CMU C.O.	CONCRETE MASONRY UNIT	PĒ	POLYETHYLENE
COL	CLEAN OUT PORT COLUMN	Pi	POINT OF INTERSECTION
CONC	CONCRETE	POB	POINT OF BEGINNING
CONN	CONNECTION	POE	POINT OF ENDING
CONT	CONTINUOUS	PT	POINT OF TANGENT
CPP	CORRUGATED PLASTIC PIPE	PP PSI	POWER POLE POUNDS PER SQUARE INCH
CTR	CENTER	PVC	POLYVINYLCHLORIDE
CU_FT	CUBIC FOOT/FEET	PZ	PIEZOMETER
DET	DETAIL	Ŕ	RADIUS
DIA	DIAMETER	RCP	REINFORCED CONCRETE PIPE
DI	DUCTILE IRON	RCW	RECLAIMED WATER
DIP	DUCTILE IRON PIPE DITTO	REINF	REINFORCING
D.O. DWG	DRAWING	REQ'D	REQUIRED
DWL	DOWEL	ROW	RIGHT OF WAY
E	EAST	S SOUED SOU	SOUTH
EA	EACH	SCHED,SCH SE	SCHEDULE SOUTHEAST
EF	EACH FACE	SECT	SECTION
EL,ELEV	ELEVATION	SG	STAFF GAUGE
ENCL	ENCLOSURE	SIM	SIMILAR
EQL	EQUAL	SPEC	SPECIFICATION
EW	EACH WAY	SQ	SQUARE
FBV	FLORIDA BEARING VALUE	SST	STAINLESS STEEL
FDN	FOUNDATION	STA	STATION
FDOT	FLORIDA DEPARTMENT OF TRANSPORTATION	STD	STANDARD
FE	FIRE EXTINGUISHER	STIR	STIRRUP
FES FIN	FLARED END SECTION FINISHED	STL	STEEL
FL	FLOW LINE, OR FLORIDAN	SW	SOUTHWEST, OR SURFACE WATER
FM	FORCE MAIN	T	TOP
FO	FIBER OPTIC	T & B	TOP AND BOTTOM
FT	FOOT	TH	TEST HOLE
FTG	FOOTING FOOTINGS FIRE MAIN WATER GAGE GALLONS	THK	THICKNESS
FTGS	FOOTINGS	1.0.B. T O C	TOP OF BOLT TOP OF CONCRETE
FWM	FIRE MAIN WATER	T.O.F.	TOP OF FOOTING
GA	GAGE	T.O.P.	TOP OF PAVEMENT, OR TOP OF P
GALV	CALLONG	T.O.S.	TOP OF SLAB
GALV HDPE	GALVANIZED HIGH DENSITY POLYETHYLENE	T.O.W.	TOP OF WALL
H,HORIZ	HORIZONTAL	TYP	TYPICAL
I.E.	INVERT ELEVATION	UON	UNLESS OTHERWISE NOTED
IN	INCH	V,VERT	VERTICAL
INV	INVERT	W	WEST
IRR	IRRIGATION	W/0	WITHOUT
JT	JOINT	W/	WITH (COMBINATION FORM)
KCJ	KEYED CONSTRUCTION JOINT	WM WWF	WATER MAIN
KWY	KEYWAY	WWH	WELDED WIRE FABRIC WOVEN WIRE MESH
L	ANGLE		

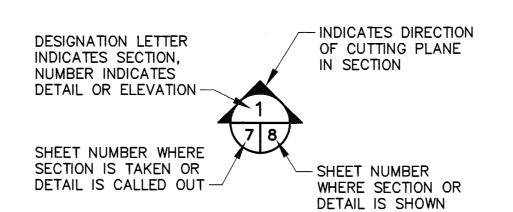

# SECTION AND DETAIL DESIGNATION

### **GENERAL NOTES:**

- TOPOGRAPHIC SURVEY PERFORMED BY PICKETT & ASSOCIATES, INC., 475 SOUTH FIRST AVENUE, BARTOW, FLORIDA 33830, TEL. (863) 533-9095.
- 2. TOPOGRAPHIC SURVEY WAS PREPARED BY PHOTOGRAMMETRIC METHODS. SEE THE SURVEYOR'S REPORT FOR MAP ACCURACY AND SURVEYOR'S SIGNATURE AND SEAL. THIS SURVEY IS LIMITED TO THOSE FEATURES VISIBLE ON AERIAL PHOTOGRAPHY. AERIAL PHOTOGRAPHY PERFORMED APRIL 3, 2012.
- 3. HORIZONTAL DATUM COORDINATES ARE REFERENCED TO THE WEST ZONE OF THE FLORIDA STATE PLANE COORDINATE SYSTEM, NAD 1983, 1999 ADJUSTMENT. VERTICAL ELEVATIONS ARE REFERENCED TO NATIONAL GEODETIC VERTICAL DATUM OF 1929.
- 4. TRAFFIC MUST BE MAINTAINED AT ALL TIMES AS PER FDOT STANDARD SPECIFICATIONS FOR ROAD AND BRIDGE CONSTRUCTION.
- 5. LOCATIONS, ELEVATIONS, AND DIMENSIONS OF EXISTING UTILITIES, STRUCTURES, AND OTHER FEATURES ARE SHOWN ACCORDING TO THE BEST INFORMATION AVAILABLE AT THE TIME OF PREPARATION OF THESE PLANS. PRIOR TO CONSTRUCTION, THE CONTRACTOR SHALL VERIFY AND AGREE TO BE FULLY RESPONSIBLE FOR ANY AND ALL DAMAGES WHICH MIGHT BE OCCASIONED BY HIS FAILURE TO EXACTLY LOCATE AND PRESERVE ANY AND ALL EXISTING UTILITIES, STRUCTURES, OR PRESERVATION AREAS AND OTHER FEATURES AFFECTING HIS WORK.
- 6. CONTRACTOR SHALL VERIFY ALL UTILITIES AND NOTIFY THE INDIVIDUAL UTILITY COMPANIES 72 HOURS PRIOR TO CONSTRUCTION.
- 7. THE CONTRACTOR SHALL REPLACE ALL PAVING, STABILIZED EARTH, CURBS, DRIVEWAYS, SIDEWALKS, DRAINAGE CULVERTS, FENCES, ETC. WITH THE SAME TYPE OF MATERIAL THAT WAS REMOVED DURING CONSTRUCTION.
- 8. THE INFORMATION PROVIDED IN THESE PLANS AND REFERENCED IN THE AVAILABLE SOILS REPORT IS SOLELY TO ASSIST THE CONTRACTOR IN ACCESSING THE NATURE AND EXTENT OF CONDITIONS WHICH WILL BE ENCOUNTERED DURING THE COURSE OF WORK. ALL CONTRACTORS ARE DIRECTED PRIOR TO BIDDING, TO CONDUCT WHATEVER INVESTIGATION THEY MAY DEEM NECESSARY TO ARRIVE AT THEIR OWN CONCLUSION REGARDING THE ACTUAL CONDITIONS THAT WILL BE ENCOUNTERED, AND UPON WHICH THEIR BIDS WILL BE BASED.
- 9. THE CONTRACTOR SHALL CONTACT THE ENGINEER IMMEDIATELY ON CONFLICTS DURING CONSTRUCTION ON ANY IMPROVEMENTS SHOWN ON THE DRAWINGS.
- 10. PIPE LENGTHS SHOWN ARE APPROXIMATE AND MAY BE ADJUSTED AS REQUIRED IN THE FIELD, UPON APPROVAL BY ENGINEER.
- 11. EROSION CONTROL AND SEDIMENTATION CONTROL DEVICES SHALL BE IN PLACE PRIOR TO BEGINNING ANY CLEARING AND GRUBBING. THEY SHALL BE INSTALLED TO THE LIMITS SHOWN ON THE DRAWING, REQUIRED IN THE SPECIFICATIONS AND IN ACCORDANCE WITH ALL REGULATORY AGENCY REQUIREMENTS.
- 12. THE LIMITS OF CONSTRUCTION SHOWN ON THE PLANS SHALL BE STRICTLY OBSERVED BY THE CONTRACTOR. ALL INGRESS, EGRESS AND TRAFFIC PATTERNS ON THE SITE SHALL BE WITHIN THE LIMITS OF CONSTRUCTION.
- 13. FINISHED GRADE FOR GROUND ELEVATIONS ON DRAWINGS REFER TO GRADE AFTER SODDING, OR OTHER SURFACE TREATMENT.
- 14. INSTALLATION OF ALL STORM SEWERS, INLETS, PIPE END TREATMENT AND APPURTENANCES SHALL BE IN ACCORDANCE WITH ALL REQUIREMENTS OF THE APPLICABLE SECTIONS OF THE FLORIDA DEPARTMENT OF TRANSPORTATION STANDARD SPECIFICATIONS, OR AS INDICATED ON THE DRAWINGS.
- 15. CONTRACTOR SHALL PLACE PROTECTIVE BARRIERS AROUND EXISTING MONITORING WELLS TO PREVENT DAMAGE DUE TO CONSTRUCTION ACTIVITIES IF REQUESTED BY THE COUNTY.
- 16. THE CONTRACTOR SHALL INSTALL SILT FENCING AROUND PERIMETER OF LAYDOWN-STAGING AREA. AT THE CONCLUSION OF PROJECT THE ENTIRE LAYDOWN AREA WILL BE CLEARED OF ALL DEBRIS AND THE AREA SEEDED TO ESTABLISH A GRASS COVER AND STABILIZE THE SOIL
- 17. SURFACE AND GROUND WATER ELEVATIONS AND STORMWATER RUNOFF VARY WITH THE TIME OF YEAR AND RAINFALL AMOUNTS ACROSS THE SITE. NEITHER THE CONSULTANT NOR THE COUNTY CAN ACCURATELY ESTIMATE THE SURFACE AND GROUND WATER ELEVATIONS THAT MAY BE ENCOUNTERED DURING THE PERFORMANCE OF THE WORK. THE CONTRACTOR SHOULD BE PREPARED TO PERFORM THE WORK AND BASE THE BID ON THE POTENTIAL SURFACE AND GROUND WATER ON SITE.
- 18. THE CONTRACTOR SHALL PROVIDE, INSTALL AND MAINTAIN SILT FENCE PER SECTION 01568 TEMPORARY EROSION AND SEDIMENTATION CONTROL OF THE CONTRACT DOCUMENTS. FDOT DESIGN STANDARDS INDEX NO. 102 TYPE III SILT FENCE SHALL BE INSTALLED BY THE CONTRACTOR ALONG THE ENTIRE EXTERIOR LIMITS OF WORK TO PREVENT DAMAGE TO PROPERTIES OUTSIDE THE LIMITS OF WORK FROM SILTATION DUE TO CONSTRUCTION OF THE PROJECT.

AUG 3 1 2012

PROJECT TITLE

ABBREVIATIONS

AND GENERAL NOTES

A

HARDEE COUNTY BOARD OF COUNTY COMMISSIONERS

ENH


SCS ENGINEERS
STEARNS, CONRAD AND SCHMIDT
CONSULTING ENGINEERS
4041 PARK OAKS BLVD., SUITE 100, TAMPA, FL 33610
813 621-0080 FAX 813 623-6757
FLORIDA CERTIFICATE OF AUTHORIZATION NO. 00004892
OJ. NO. SDA
SDA
STEARNS
GARMET
CONSULTING
STEARNS
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S

CADD FILE:
993323GENNOTE

TE:
AUGUST 2012

AS SHOWN DRAWING NO.

**2** of

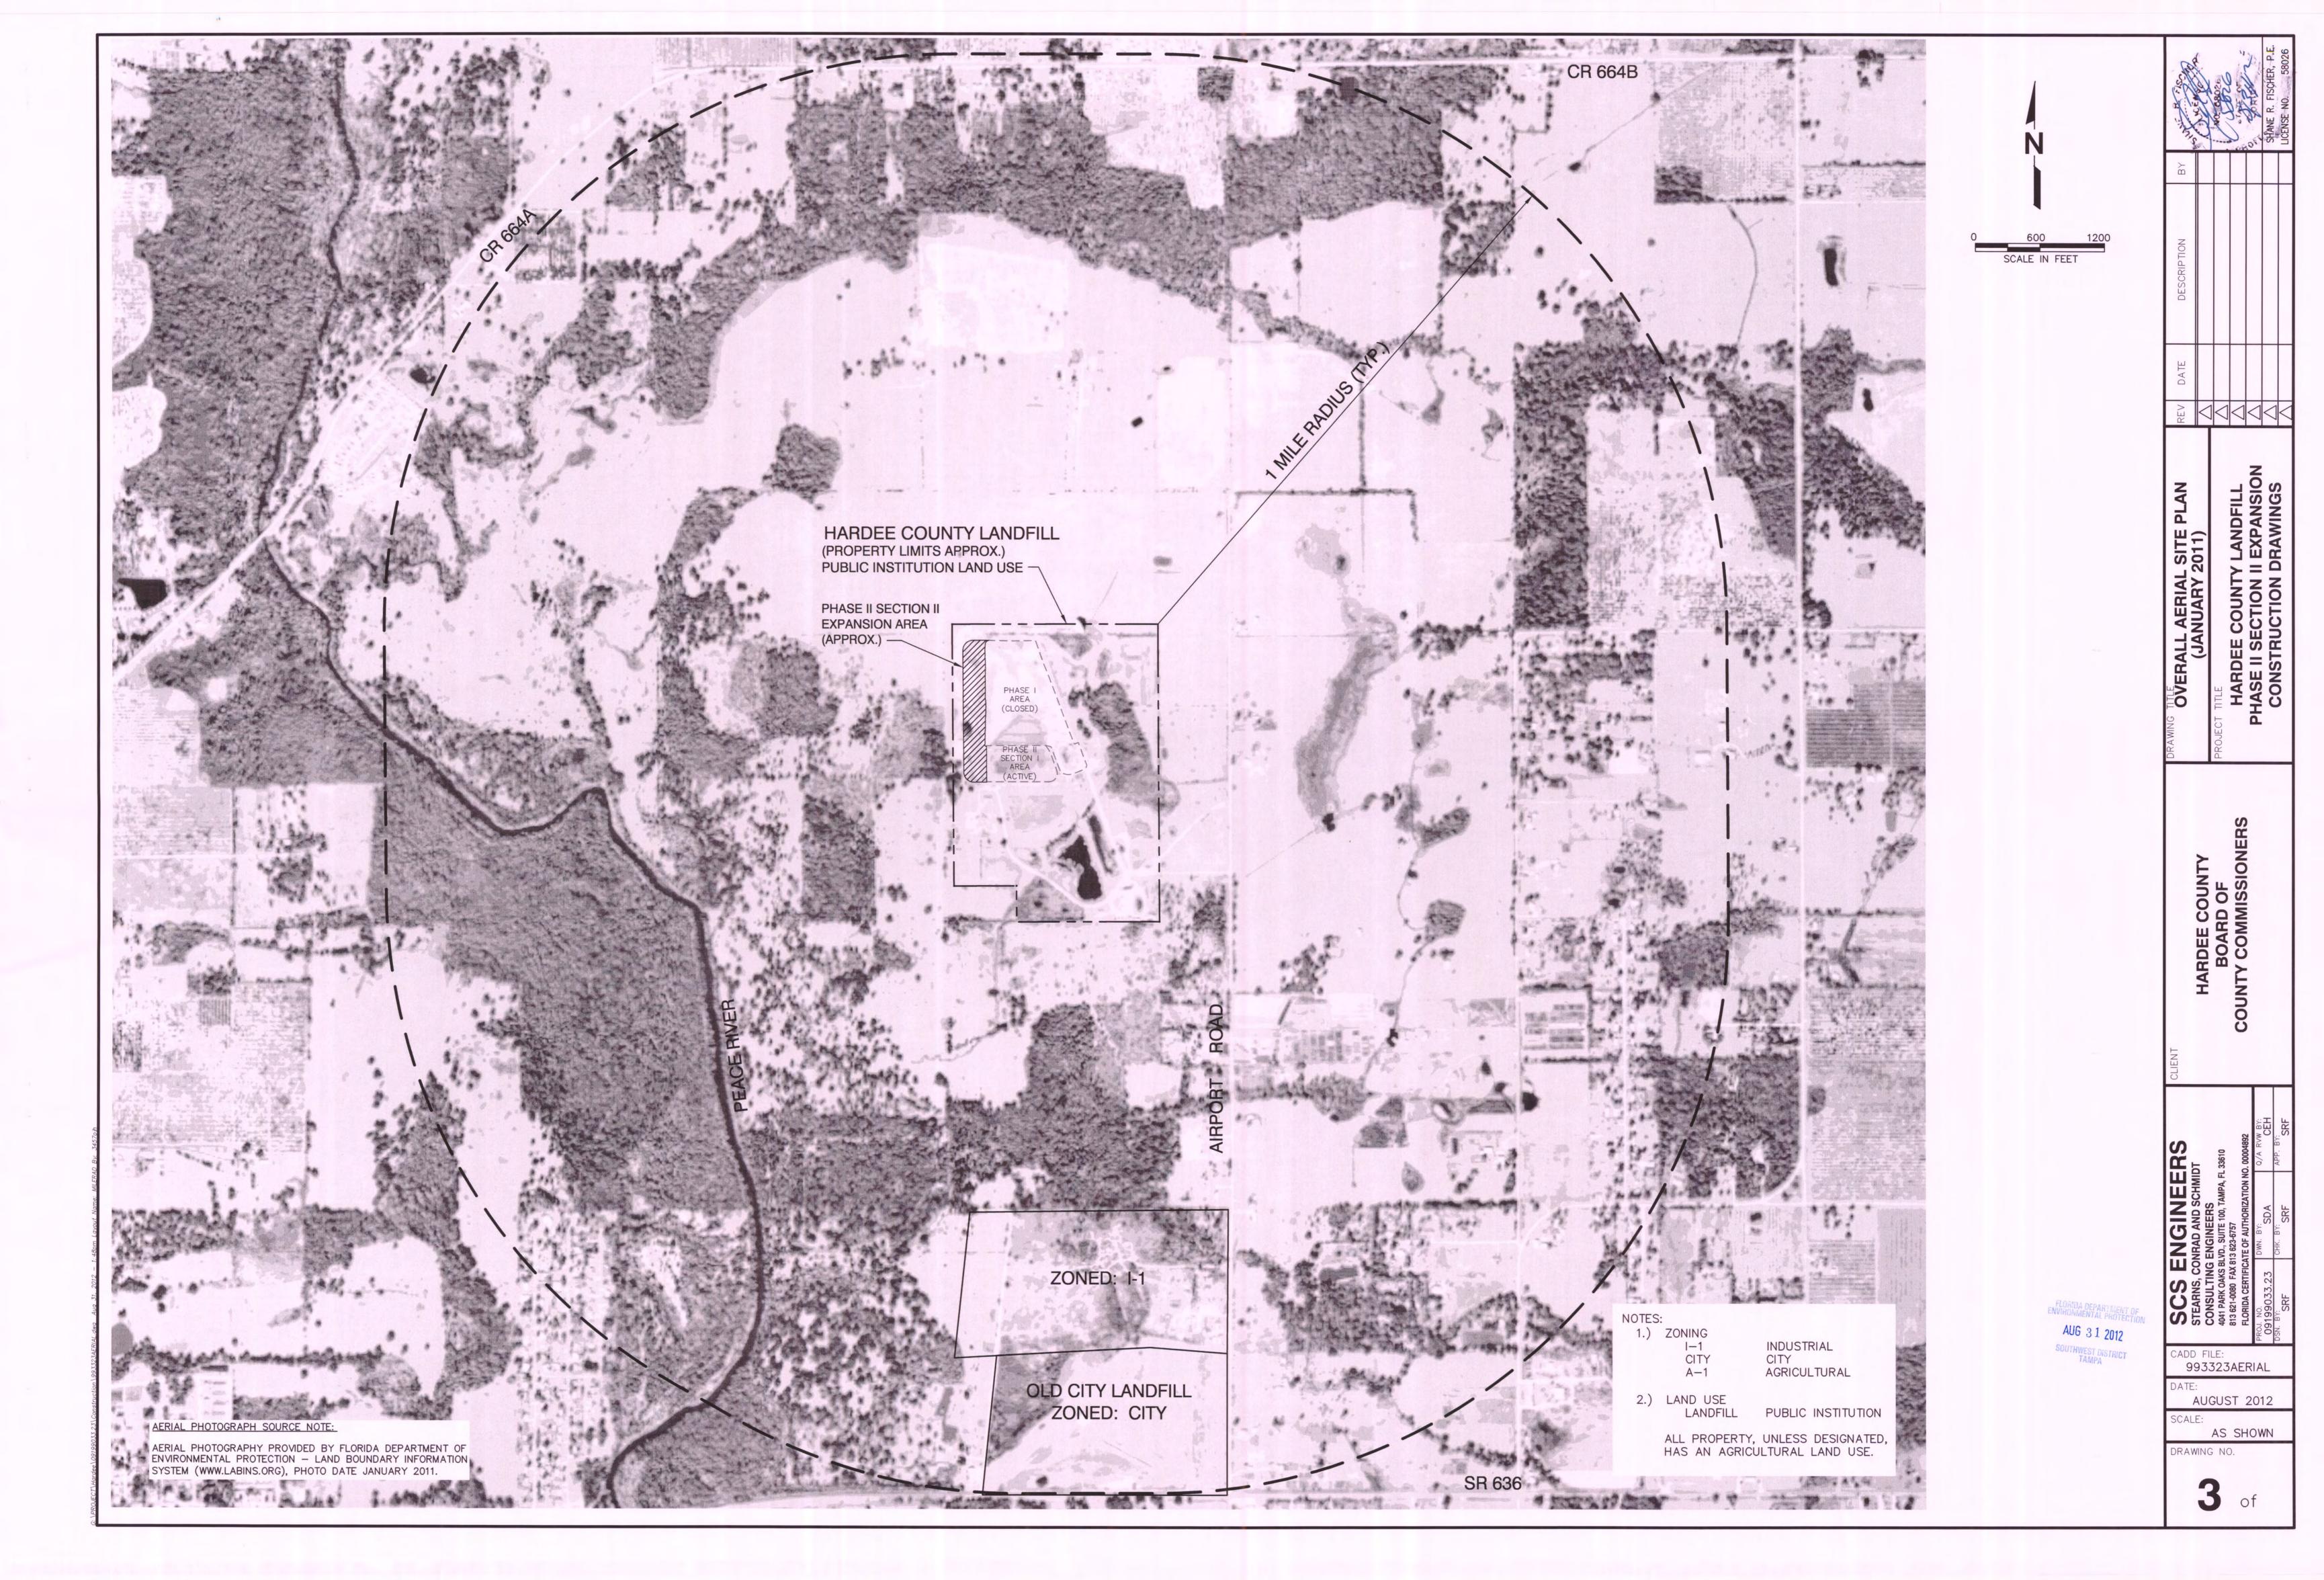

# **EXISTING**

_		
EXISTING MO	NITORING W	ELL TABLE
WELL NUMBER	NORTHING	EASTING
MW-1	1177604.2260	726482.488
MW-2	1176800.972	727061.767
MW-4	1177588.34	727469.216
*MW-5	1177136.888	726199.5
MW-6	1176081.769	726652.386
MW-7	1175903.729	726370.416
*MW-8	1176543.71	726234.815
*MW-3	1176439.418	726193.823
MW-10R	1176262.89	726947.09
MW-11	1176198.382	726695.813
MW-12R	1176201.53	726403.89

EXISTING	GAS PROBE	TABLE
PROBE NUMBER	NORTHING	EASTING
GP-1	1177602.658	726820.612
GP-2	1177601.357	726490.331
*GP-3	1177593.371	726188.964
*GP-4	1177304.268	726203.456
*GP-5	1176913.338	726205.276
*GP-6	1176692.365	726207.86
GP-9	1176697.437	727108.717
GP-10	1177021.197	726982.352
GP-11	1177341.968	726852.393
GP-12	1175710.195	726496.639
GP-13	1175700.036	726690.812

EXISTING	PIEZOMETER	TABLE
WELL NUMBER	NORTHING	EASTING
P-7	1175812.82	726774.259
P-8	1175724.264	726530.637
P-11	1177153.801	726939.428
P-13	1176047.296	726494.261
P-14	1175889.67	726516.147
P-17	1177698.331	726212.616
P-18	1177585.22	725955.47
P-19	1177685.19	726890.76
P-20	1177564.956	726849.789
P-21	1177000.302	727105.589
P-22	1176021.166	726023.336
P-23	1175717.48	726021.42


EXISTING S	TAFF GAUG	E TABLE
POINT NUMBER	NORTHING	EASTING
SG 1	1177149.111	727100.065
SG 2	1177217.671	727292.17


\* DENOTES GAS PROBE OR MONITORING WELL TO BE ABANDONED (TYP.)

# **NEW**

WELL NUMBER NORTHING EASTIN	G
MW-13 1176331.81 725977.7	0
MW-14 1176949.27 725978.3	0
MW-15 1177463.17 725967.7	8

NEW GA	S PROBE T	ABLE
PROBE NUMBER	NORTHING	EASTING
GP-3R	1177624.46	726157.43
GP-4R	1177308.20	725945.51
GP-5R	1177004.63	725946.99
GP-6R	1176702.21	725946.53
GP-7R	1176402.21	725946.53
GP-8R	1176099.87	725949.54

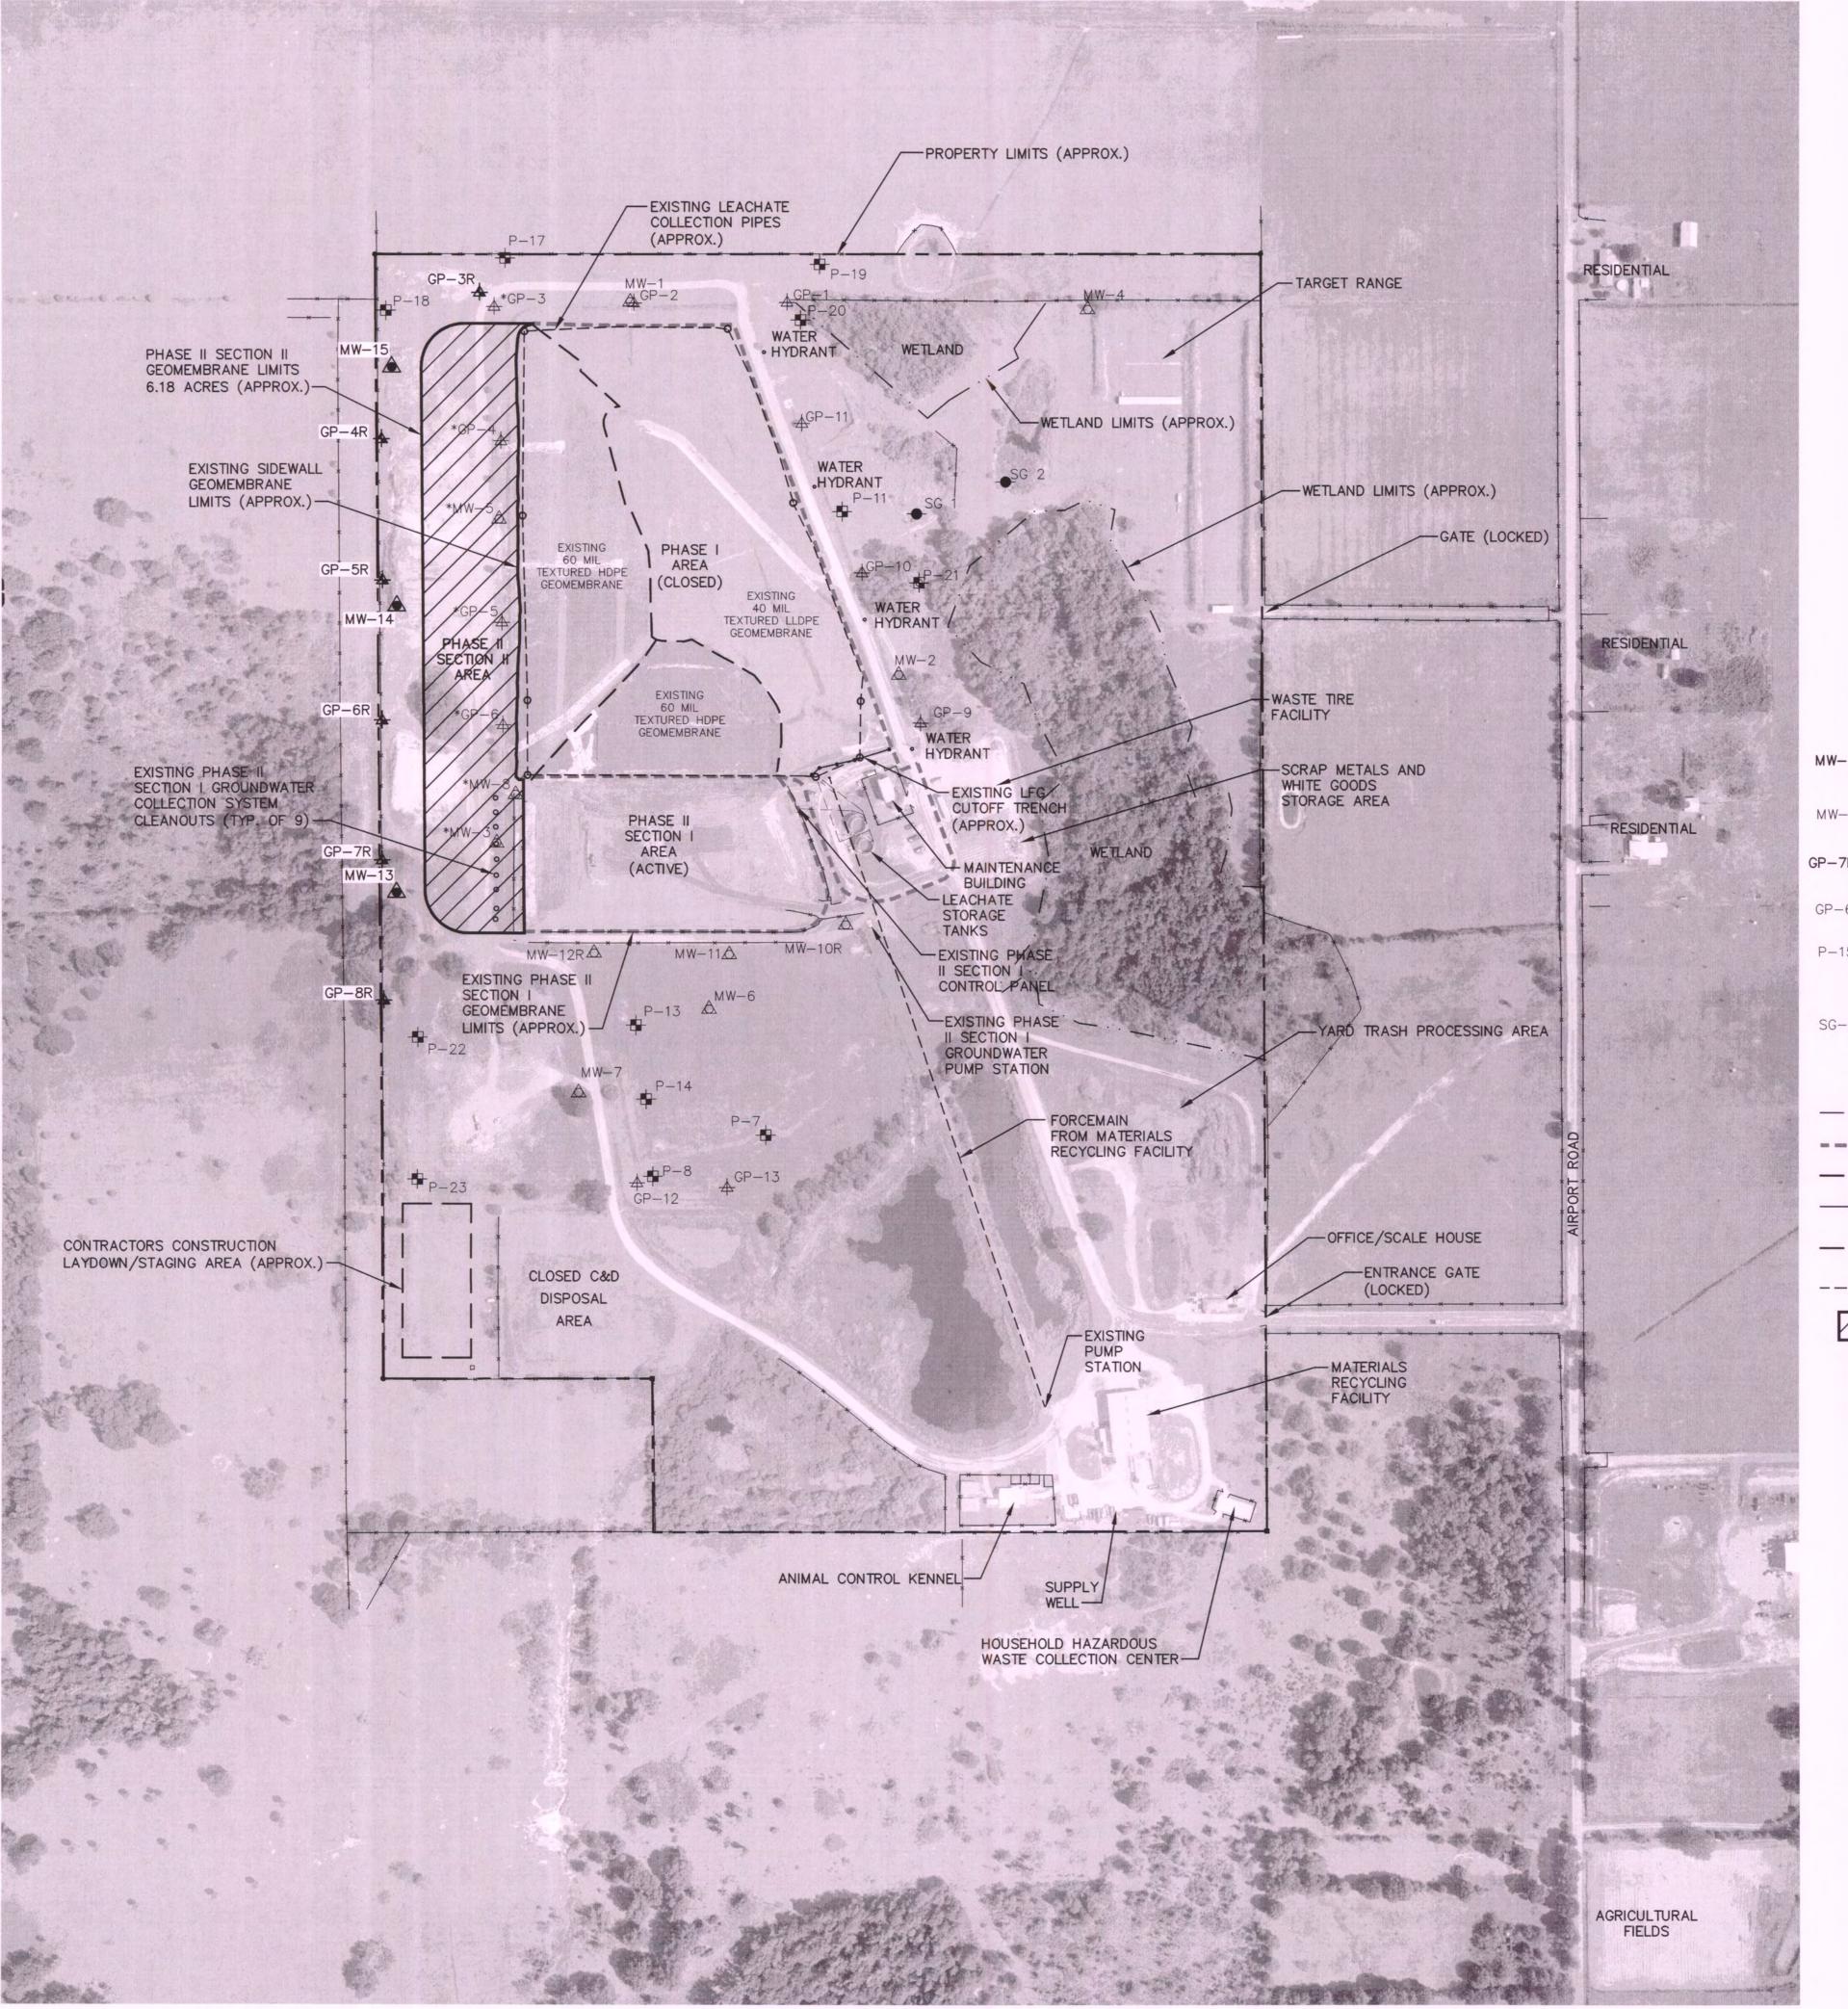

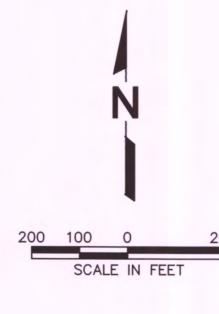

## **LEGEND**

GROUNDWATER MONITORING WELL

GROUNDWATER MONITORING WELL

GAS MONITORING PROBE

GAS MONITORING PROBE **EXISTING** 

EXISTING MANHOLE

**PIEZOMETER** 

EXISTING STAFF GUAGE EXISTING GROUNDWATER COLLECTION SYSTEM CLEANOUTS (APPROX. TYP. 9)

- EXISTING LFG CUTOFF TRENCH

---- EXISTING LANDFILL PHASE LIMITS (APPROX.)

— - - — PROPERTY LINE

---- WETLAND LIMITS

CONTRACTORS CONSTRUCTION LAYDOWN/STAGING AREA (APPROX.) - SEE NOTE 1.

---- EXISTING LEACHATE COLLECTION PIPE AND MANHOLE

APPROXIMATE LIMITS OF PHASE II SECTION II GEOMEMBRANE

NOTE:

 THE GENERAL LOCATION OF THE CONTRACTOR'S CONSTRUCTION LAYDOWN/STAGING AREA IS SHOWN ON THE DRAWING. THE COUNTY AND THE CONTRACTOR WILL COORDINATE ON THE FINAL BOUNDARIES OF THE CONSTRUCTION LAYDOWN/STAGING AREA AND CONTRACTOR'S ACCESS FROM THE AREA TO THE MAIN ROAD AT THE PRE-CONSTRUCTION MEETING. THE CONSTRUCTION LAYDOWN/STAGING AREA SHALL BE GRADED TO EXISTING GRADES, SEEDED AND MULCHED AS REQUIRED UPON COMPLETION OF THE PROJECT PER THE SPECIFICATIONS.

993323AERIAL

HARDEE COUNTY BOARD OF COUNTY COMMISSIONE


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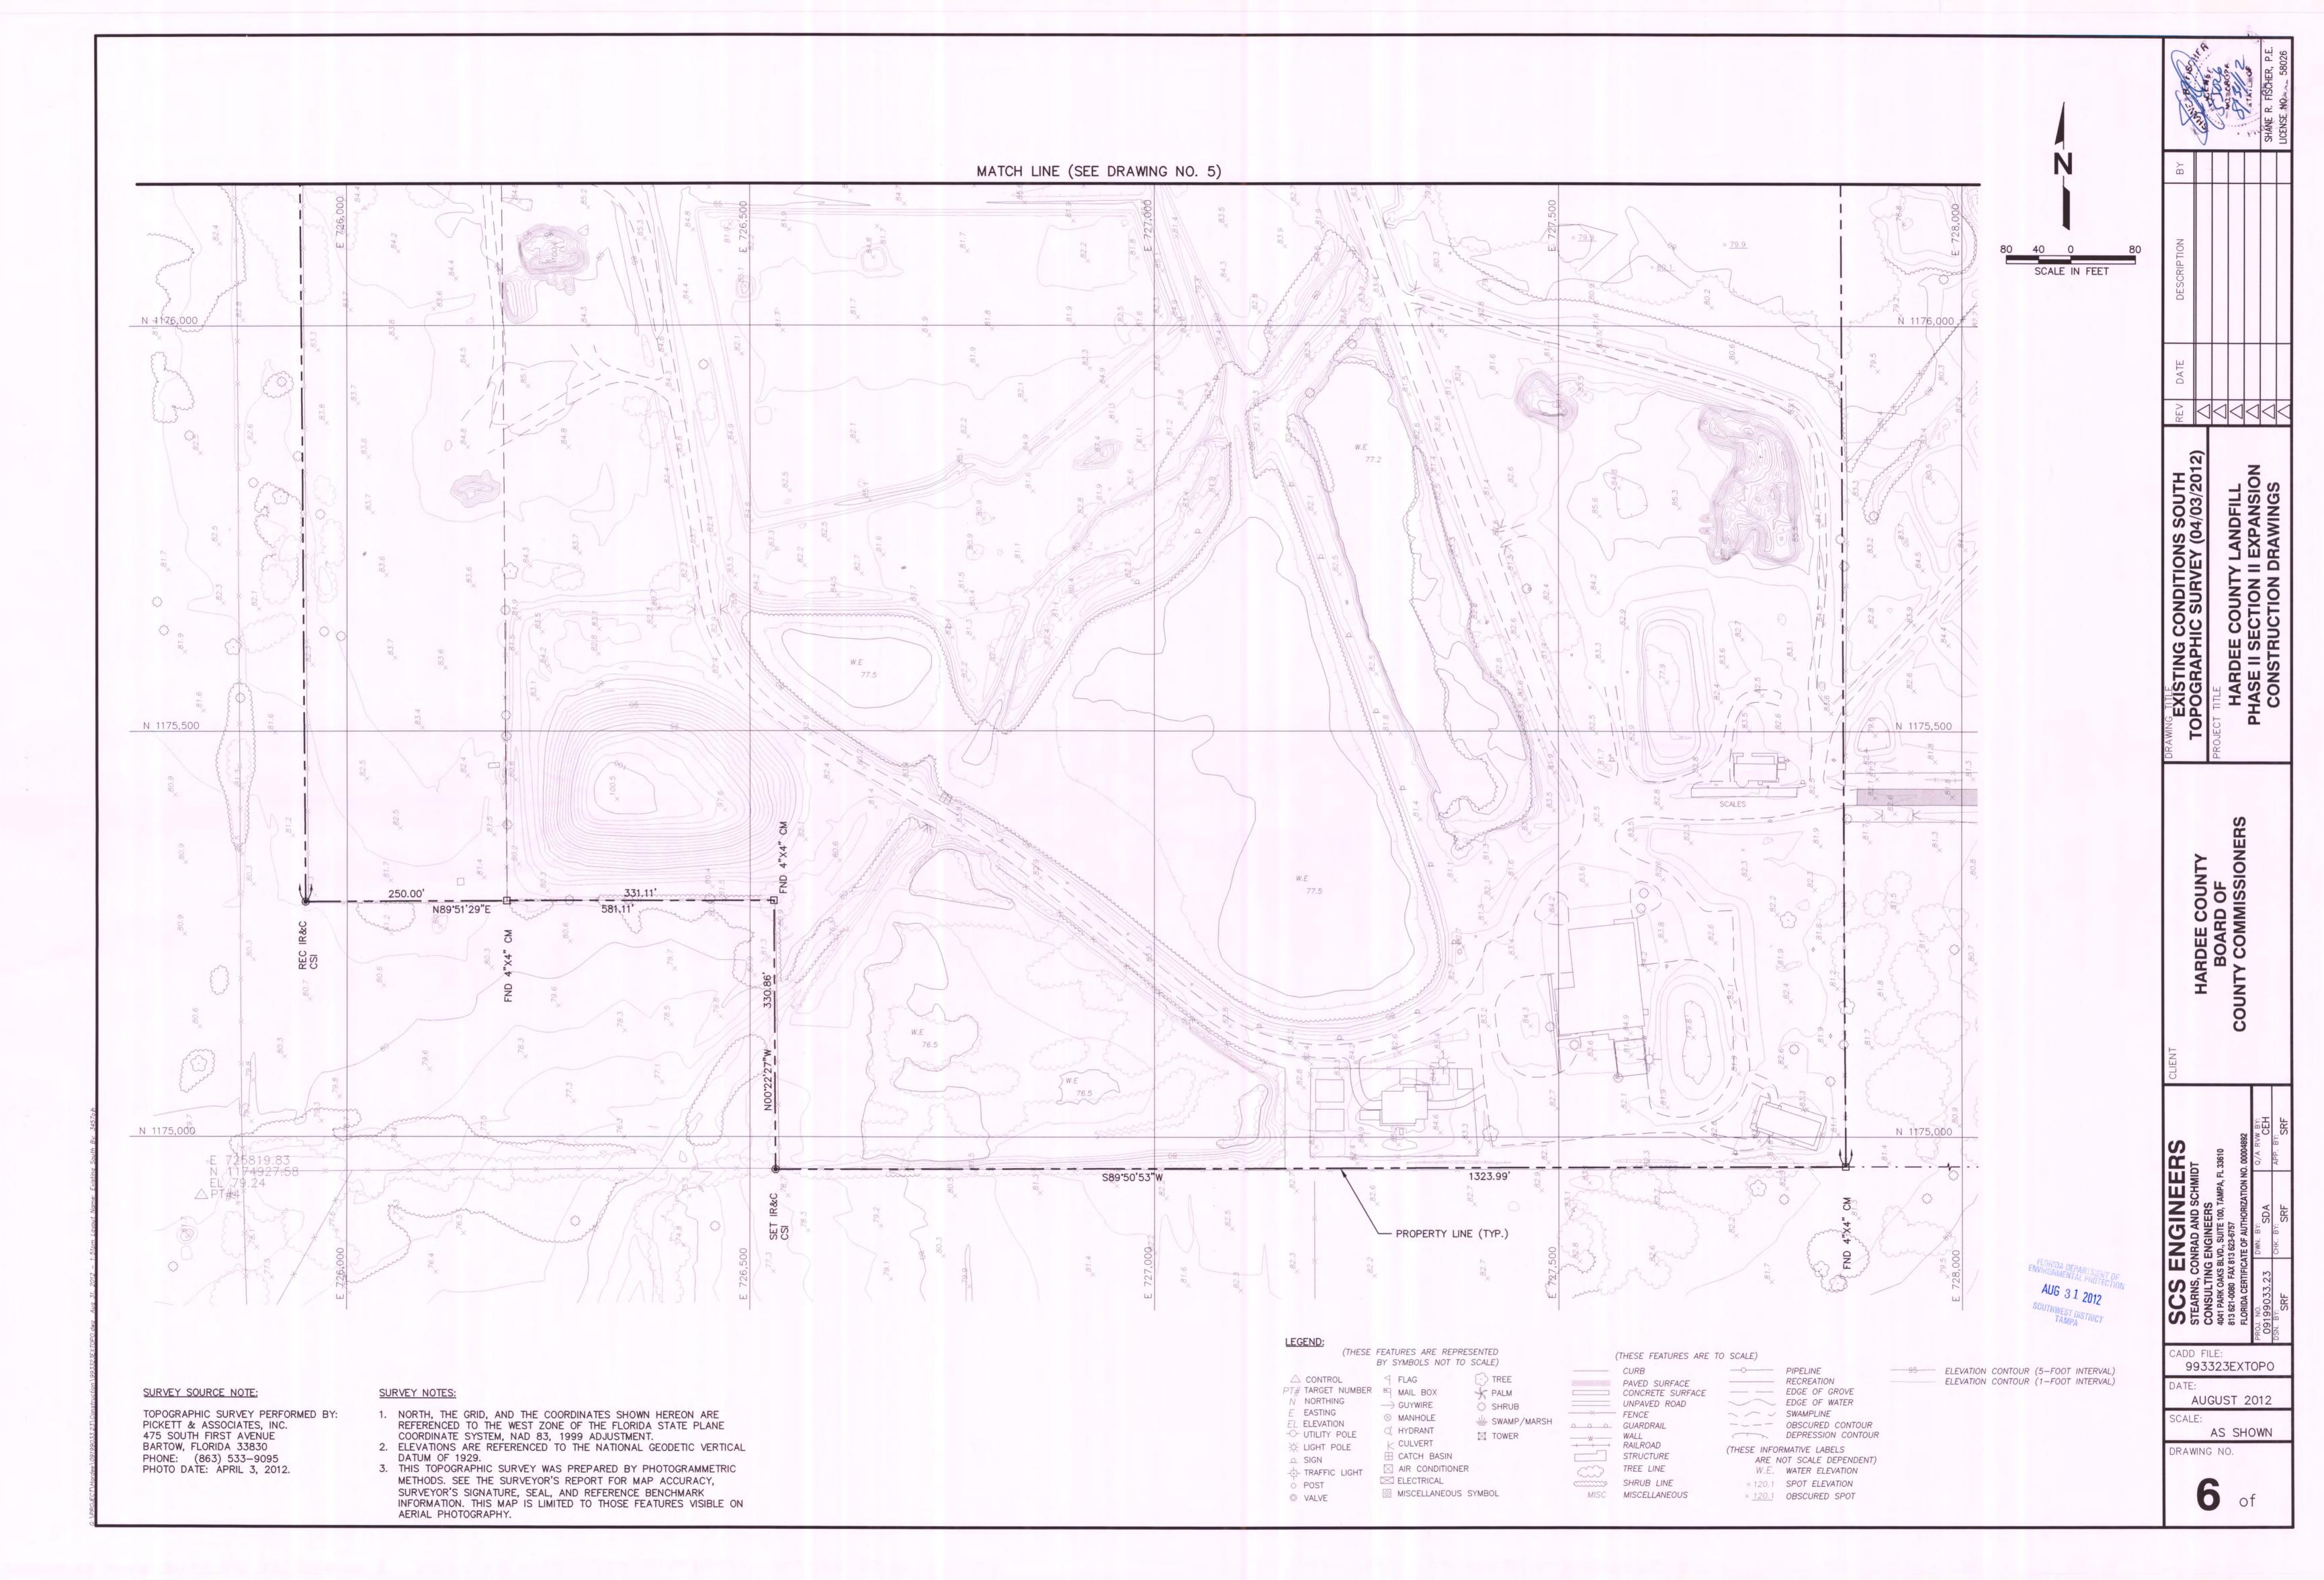
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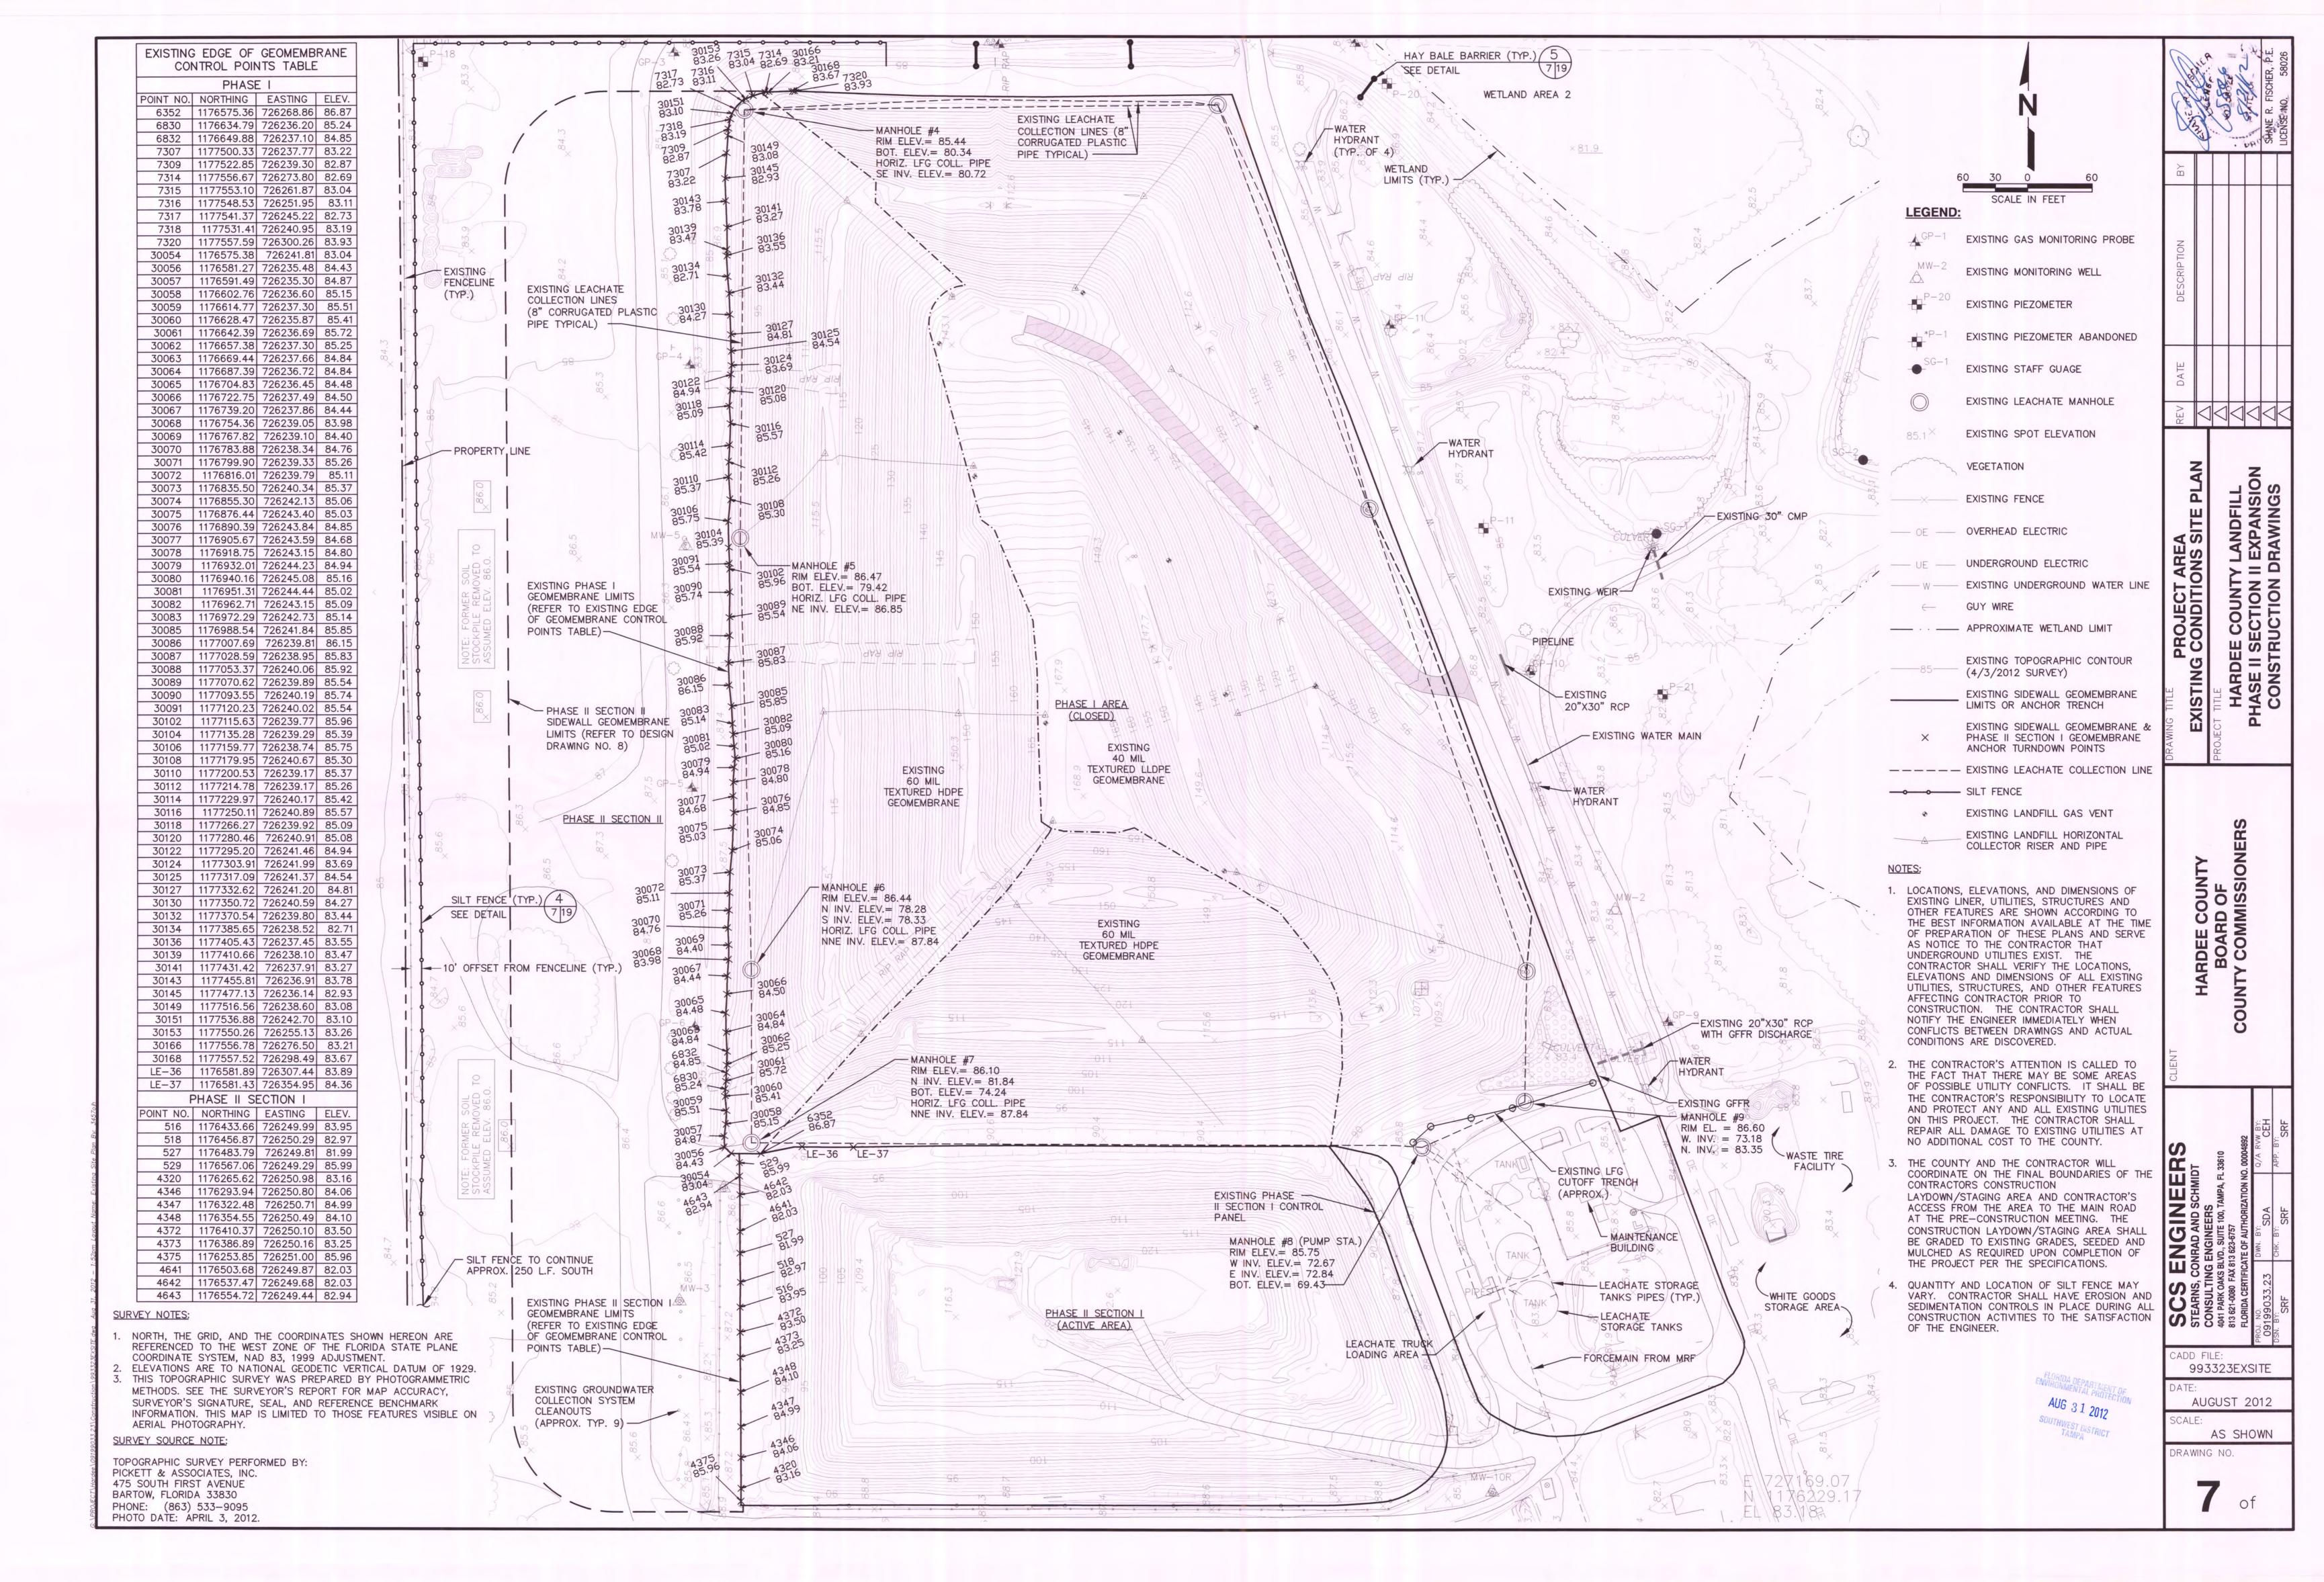
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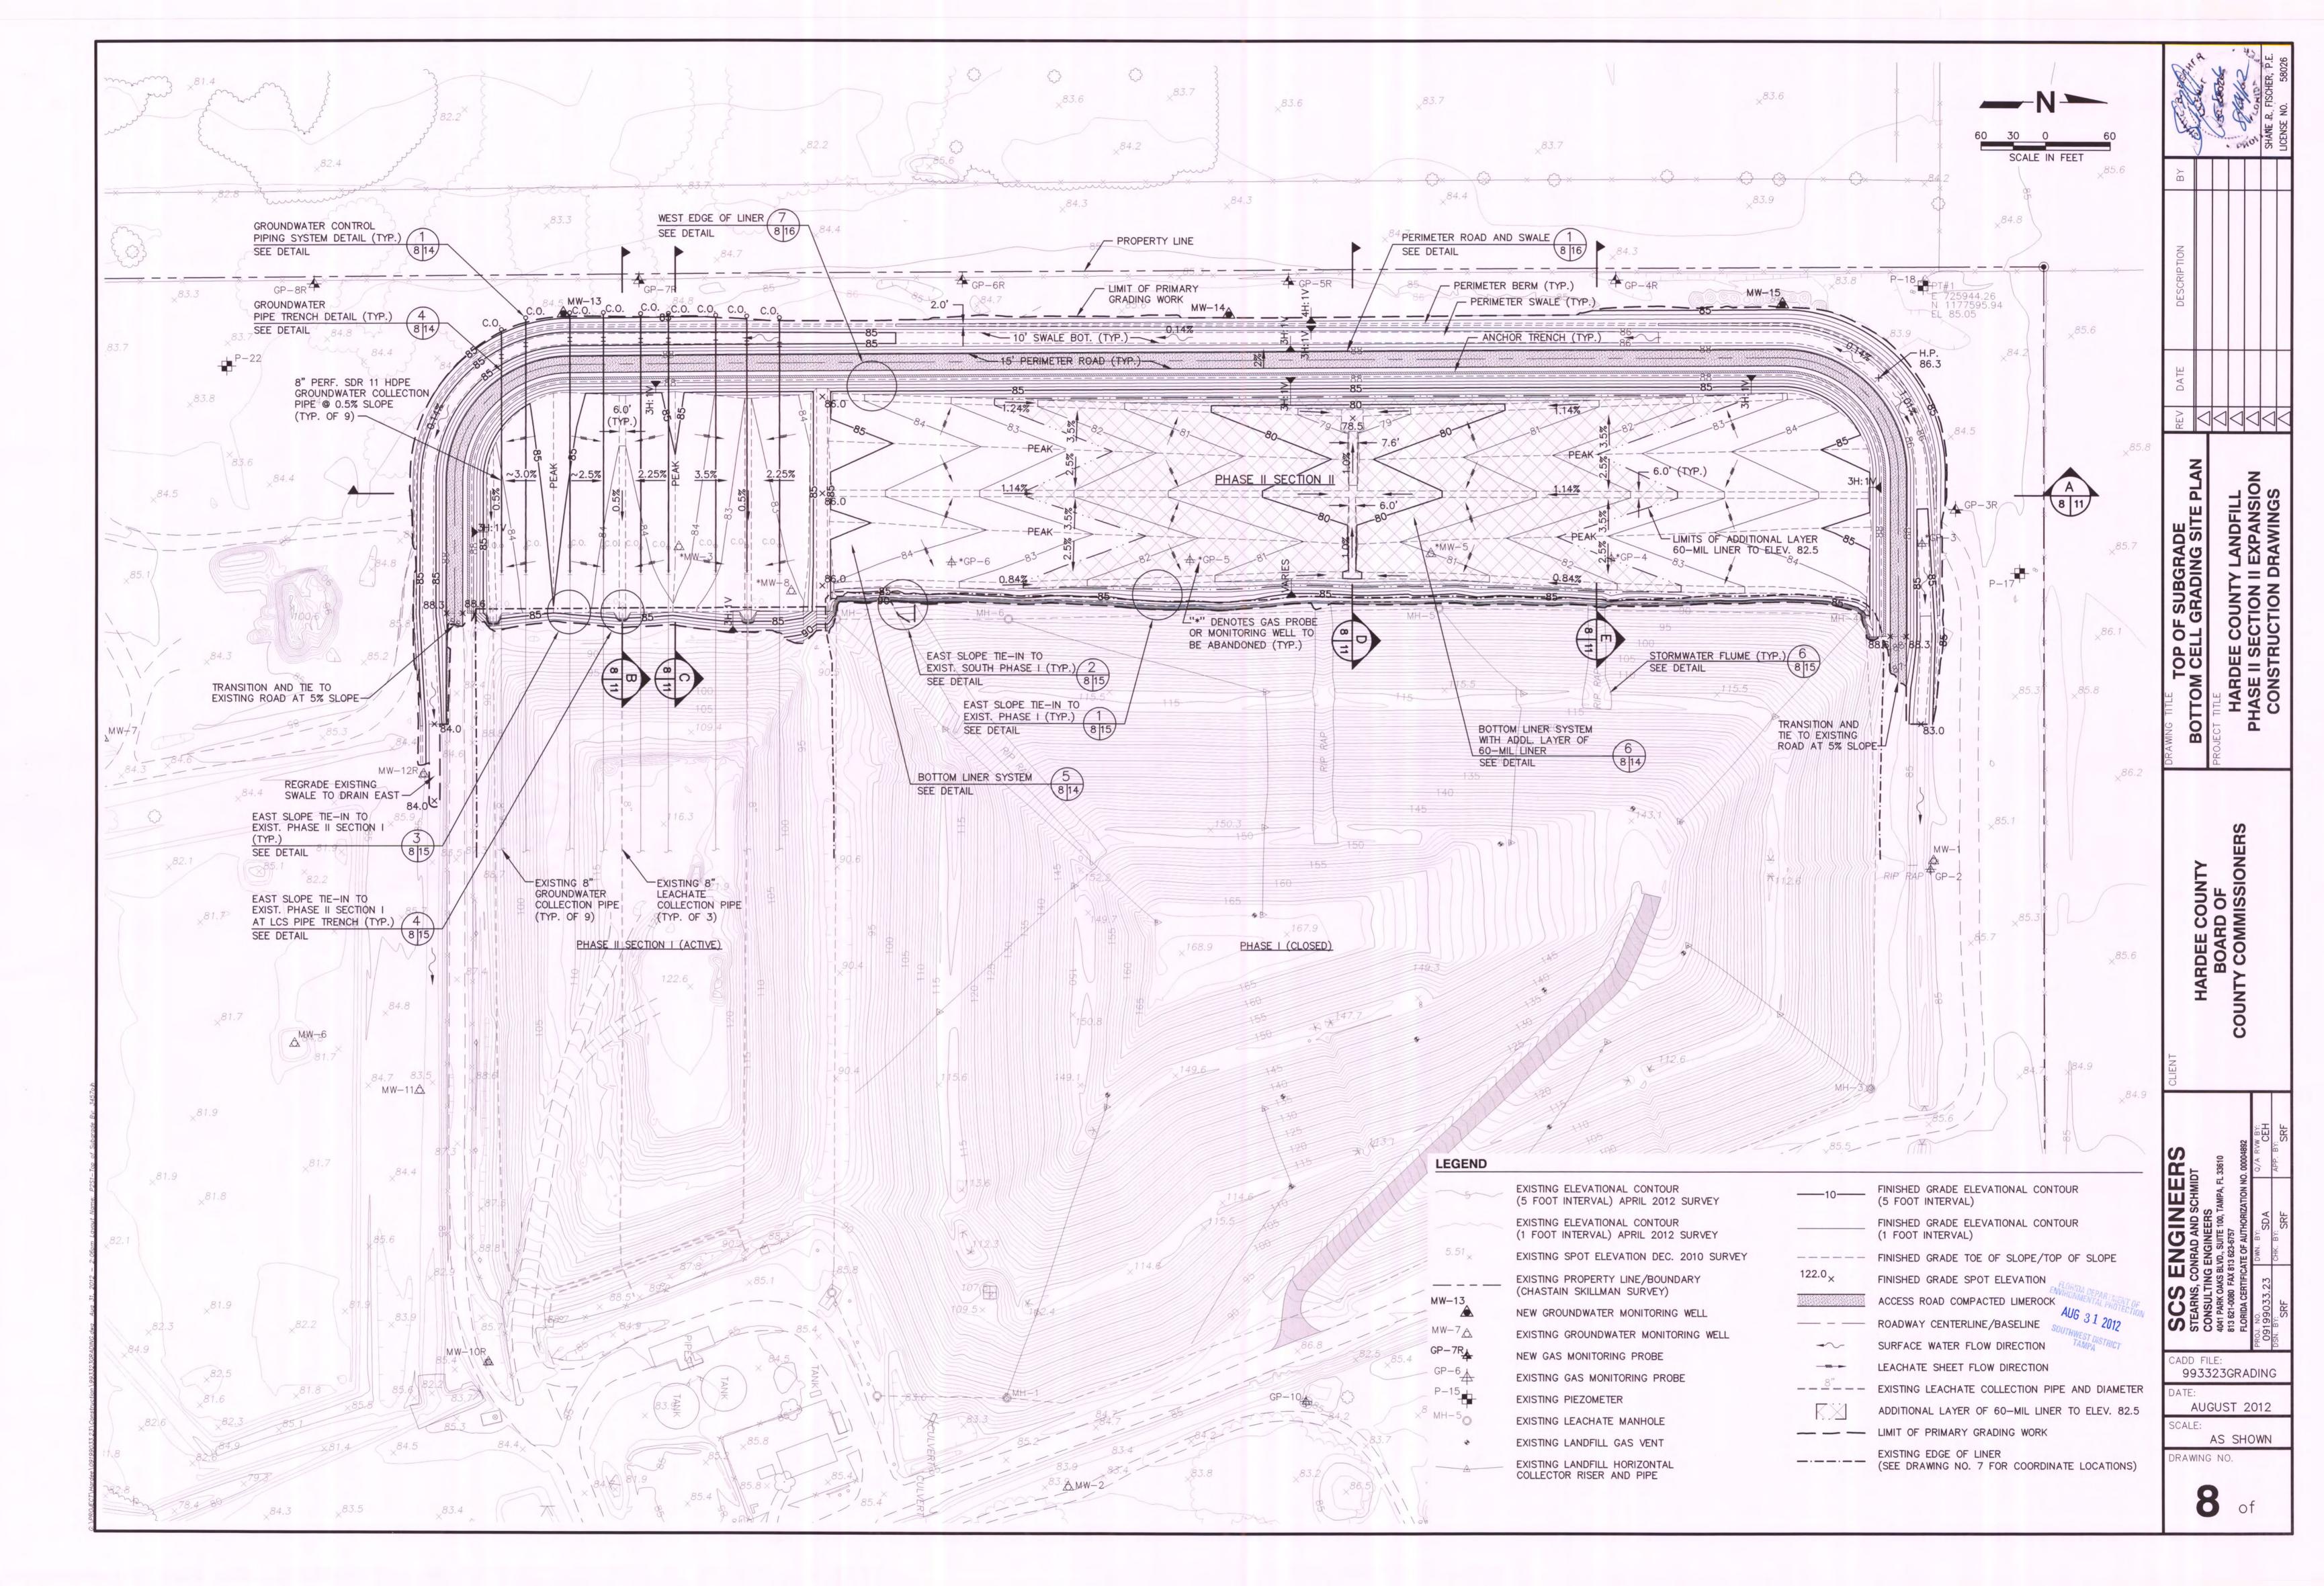
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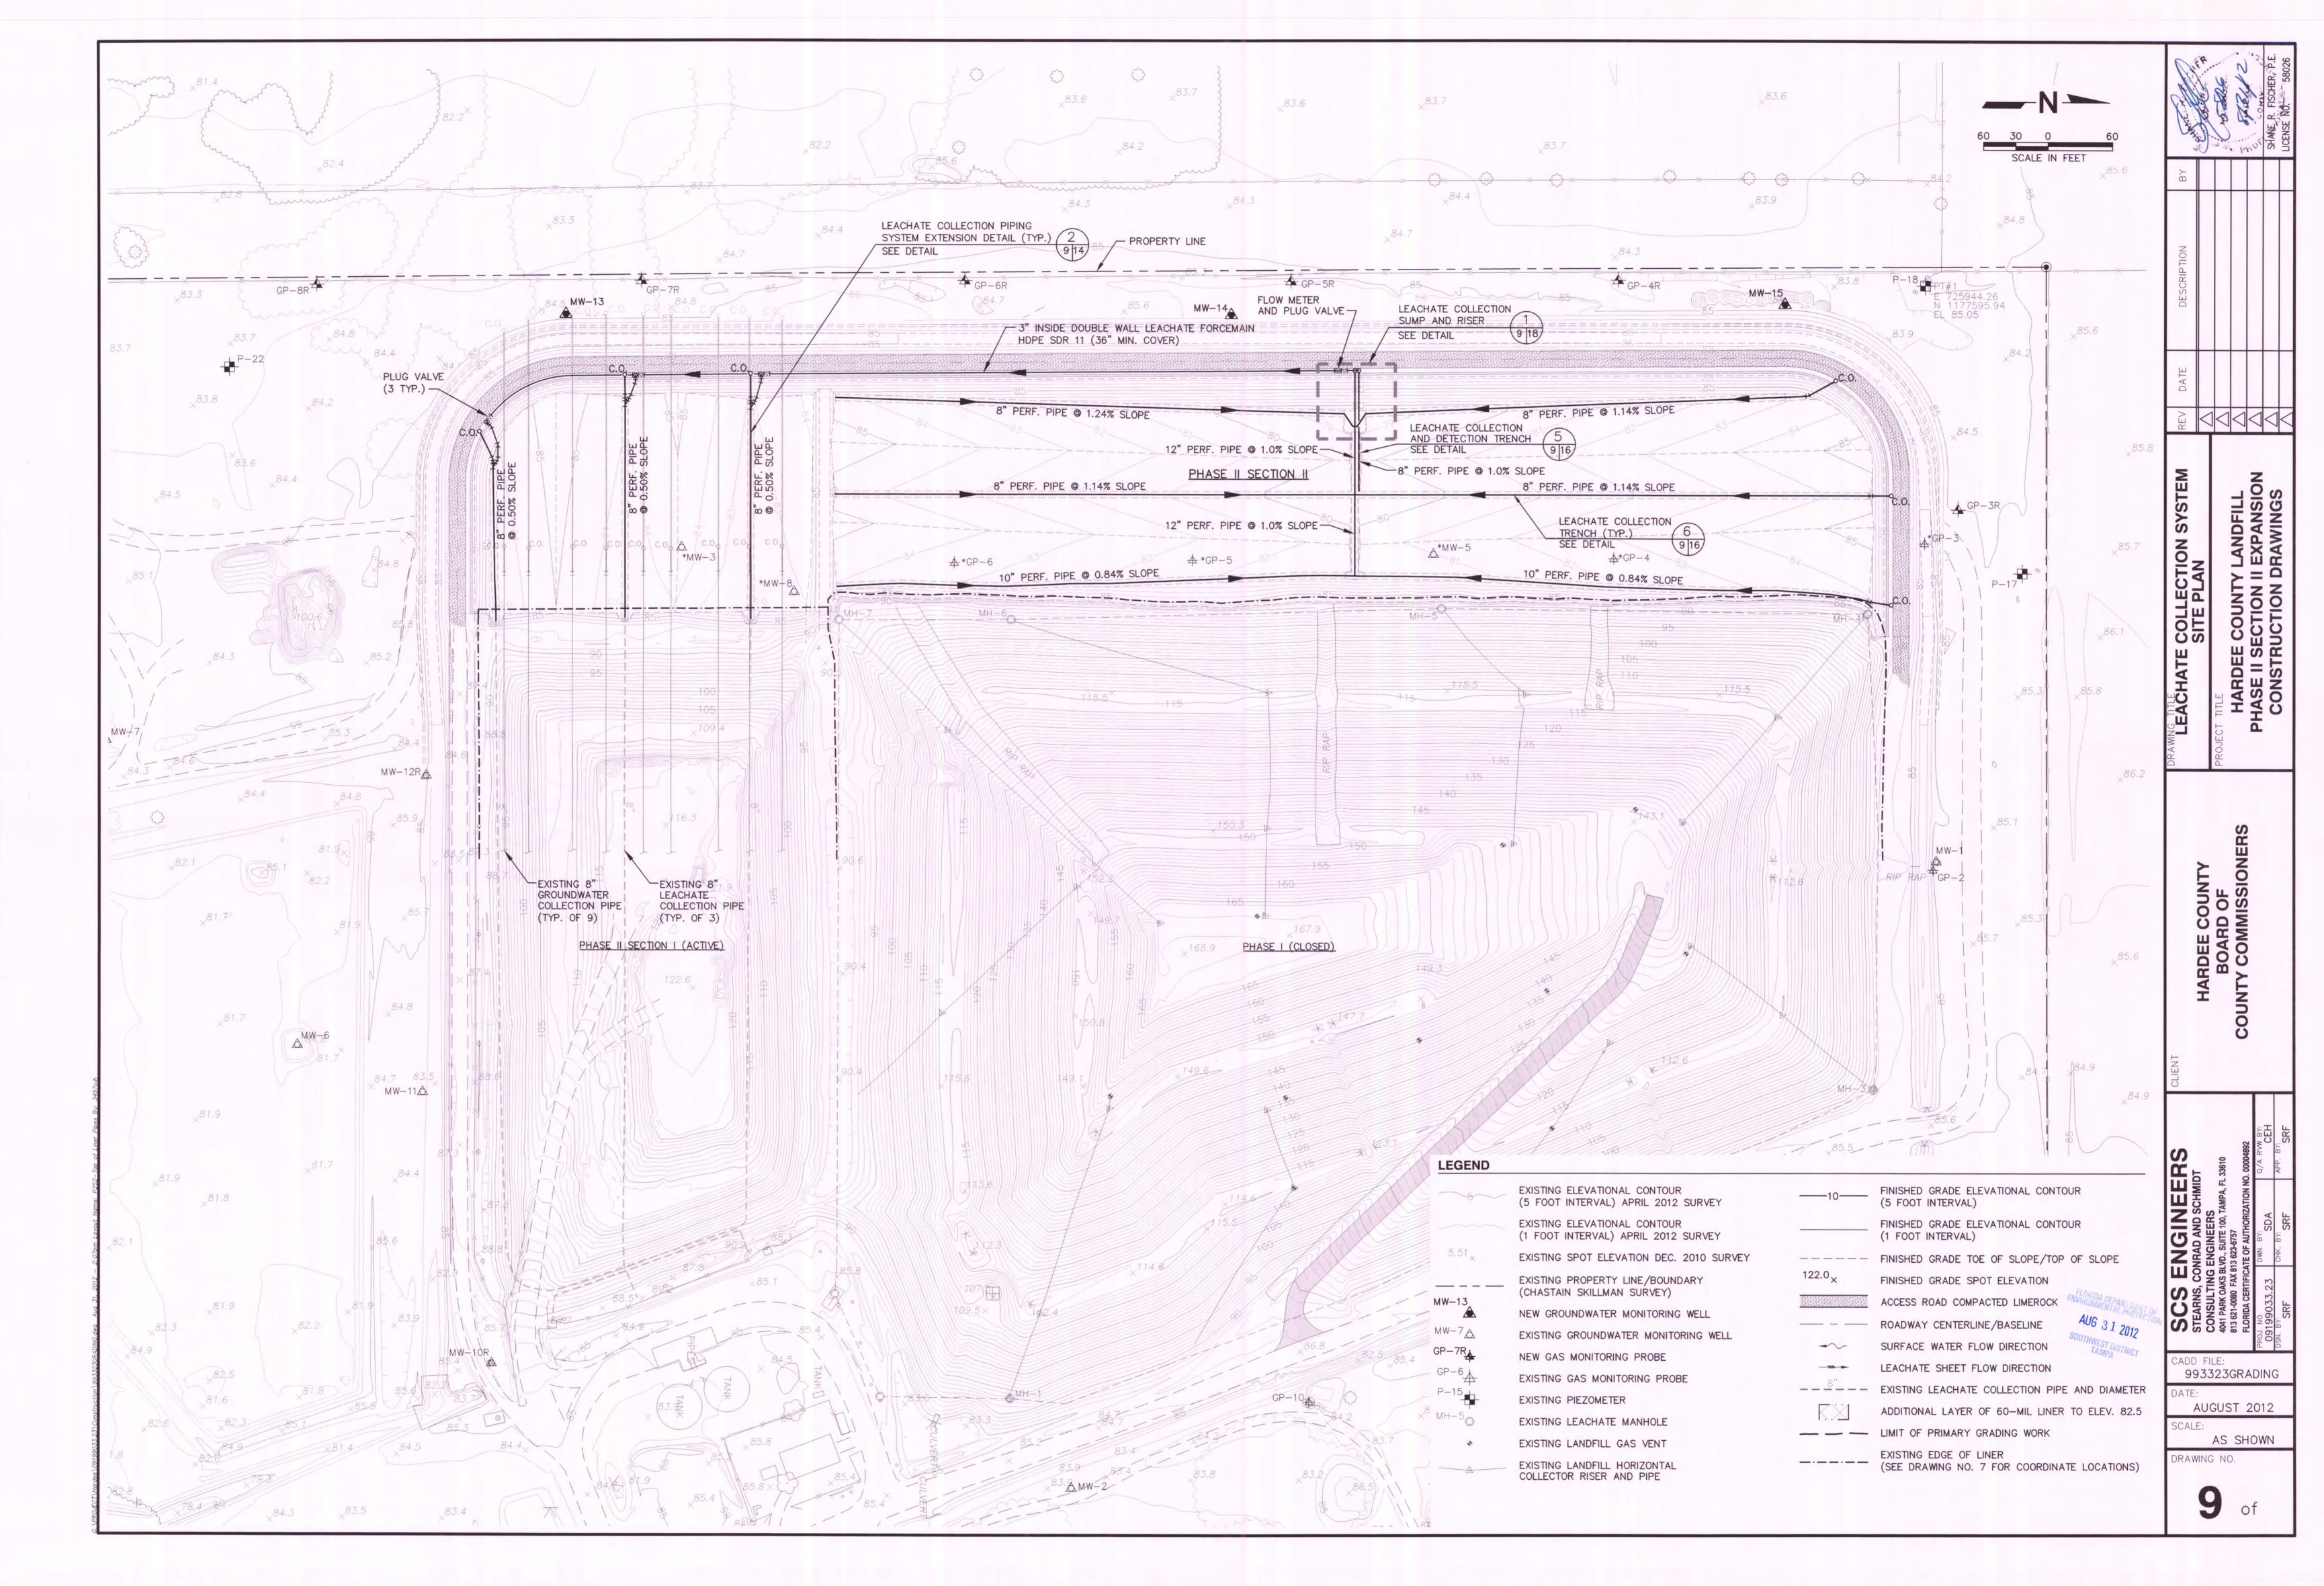
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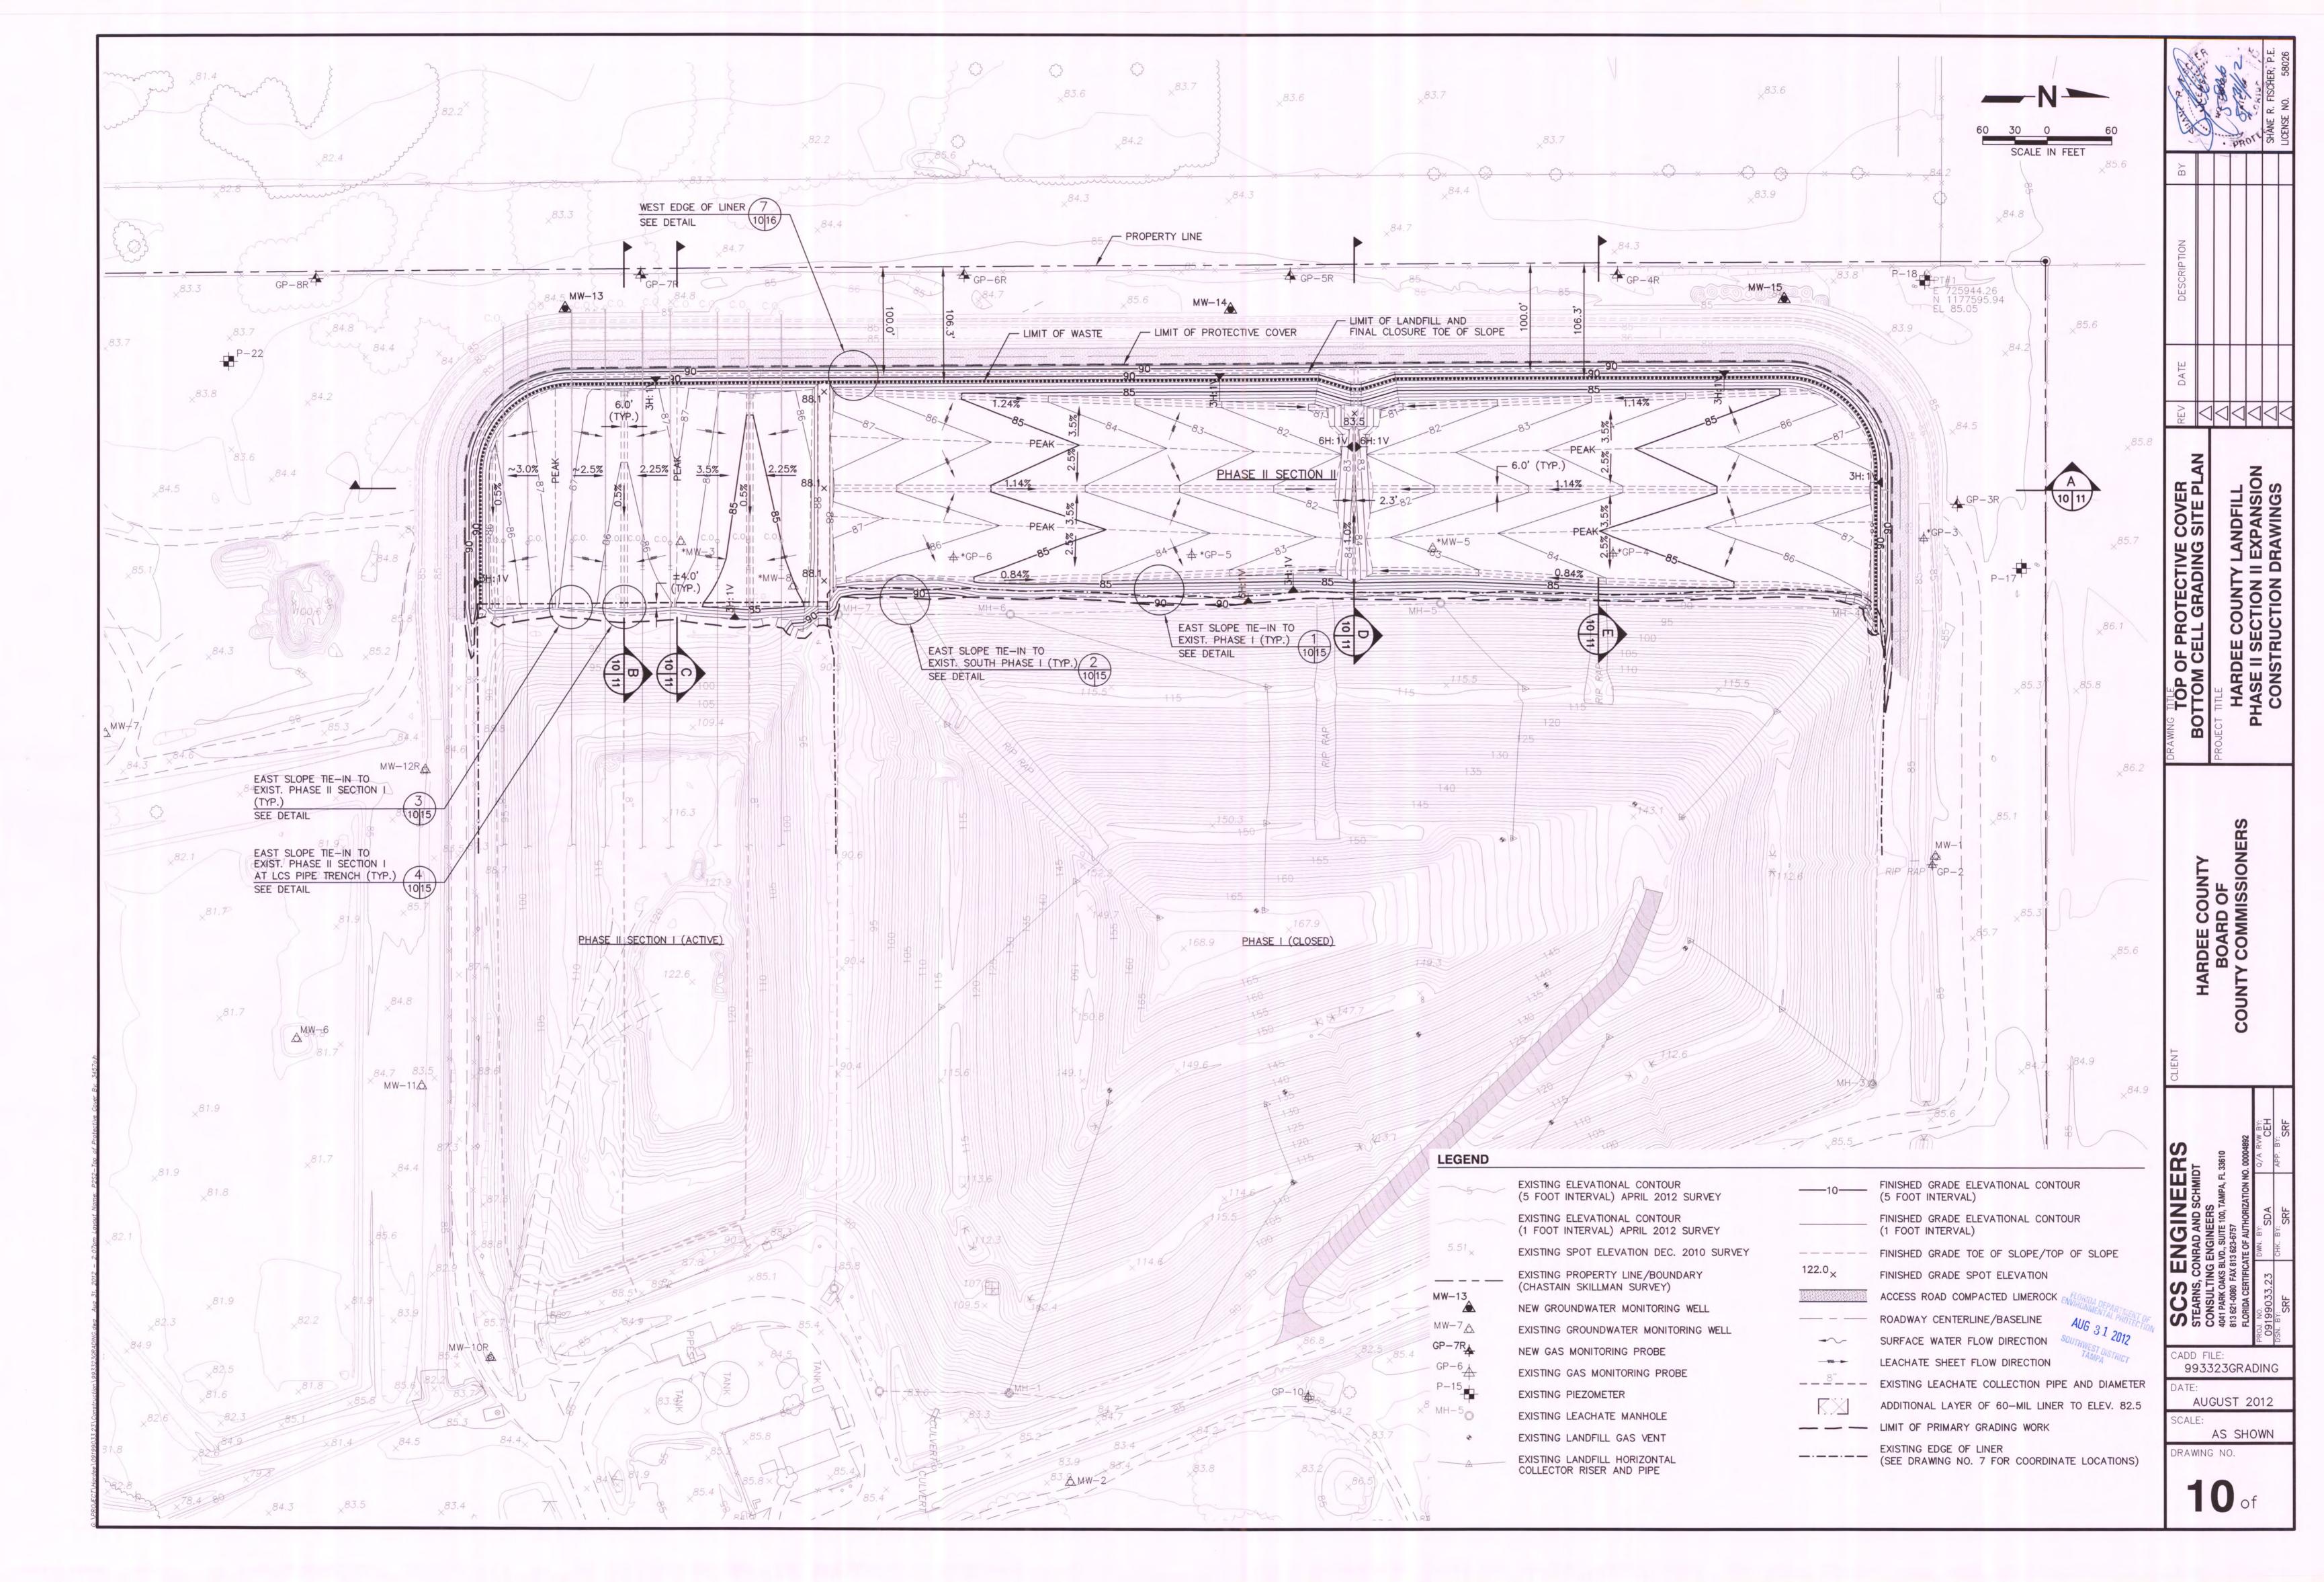











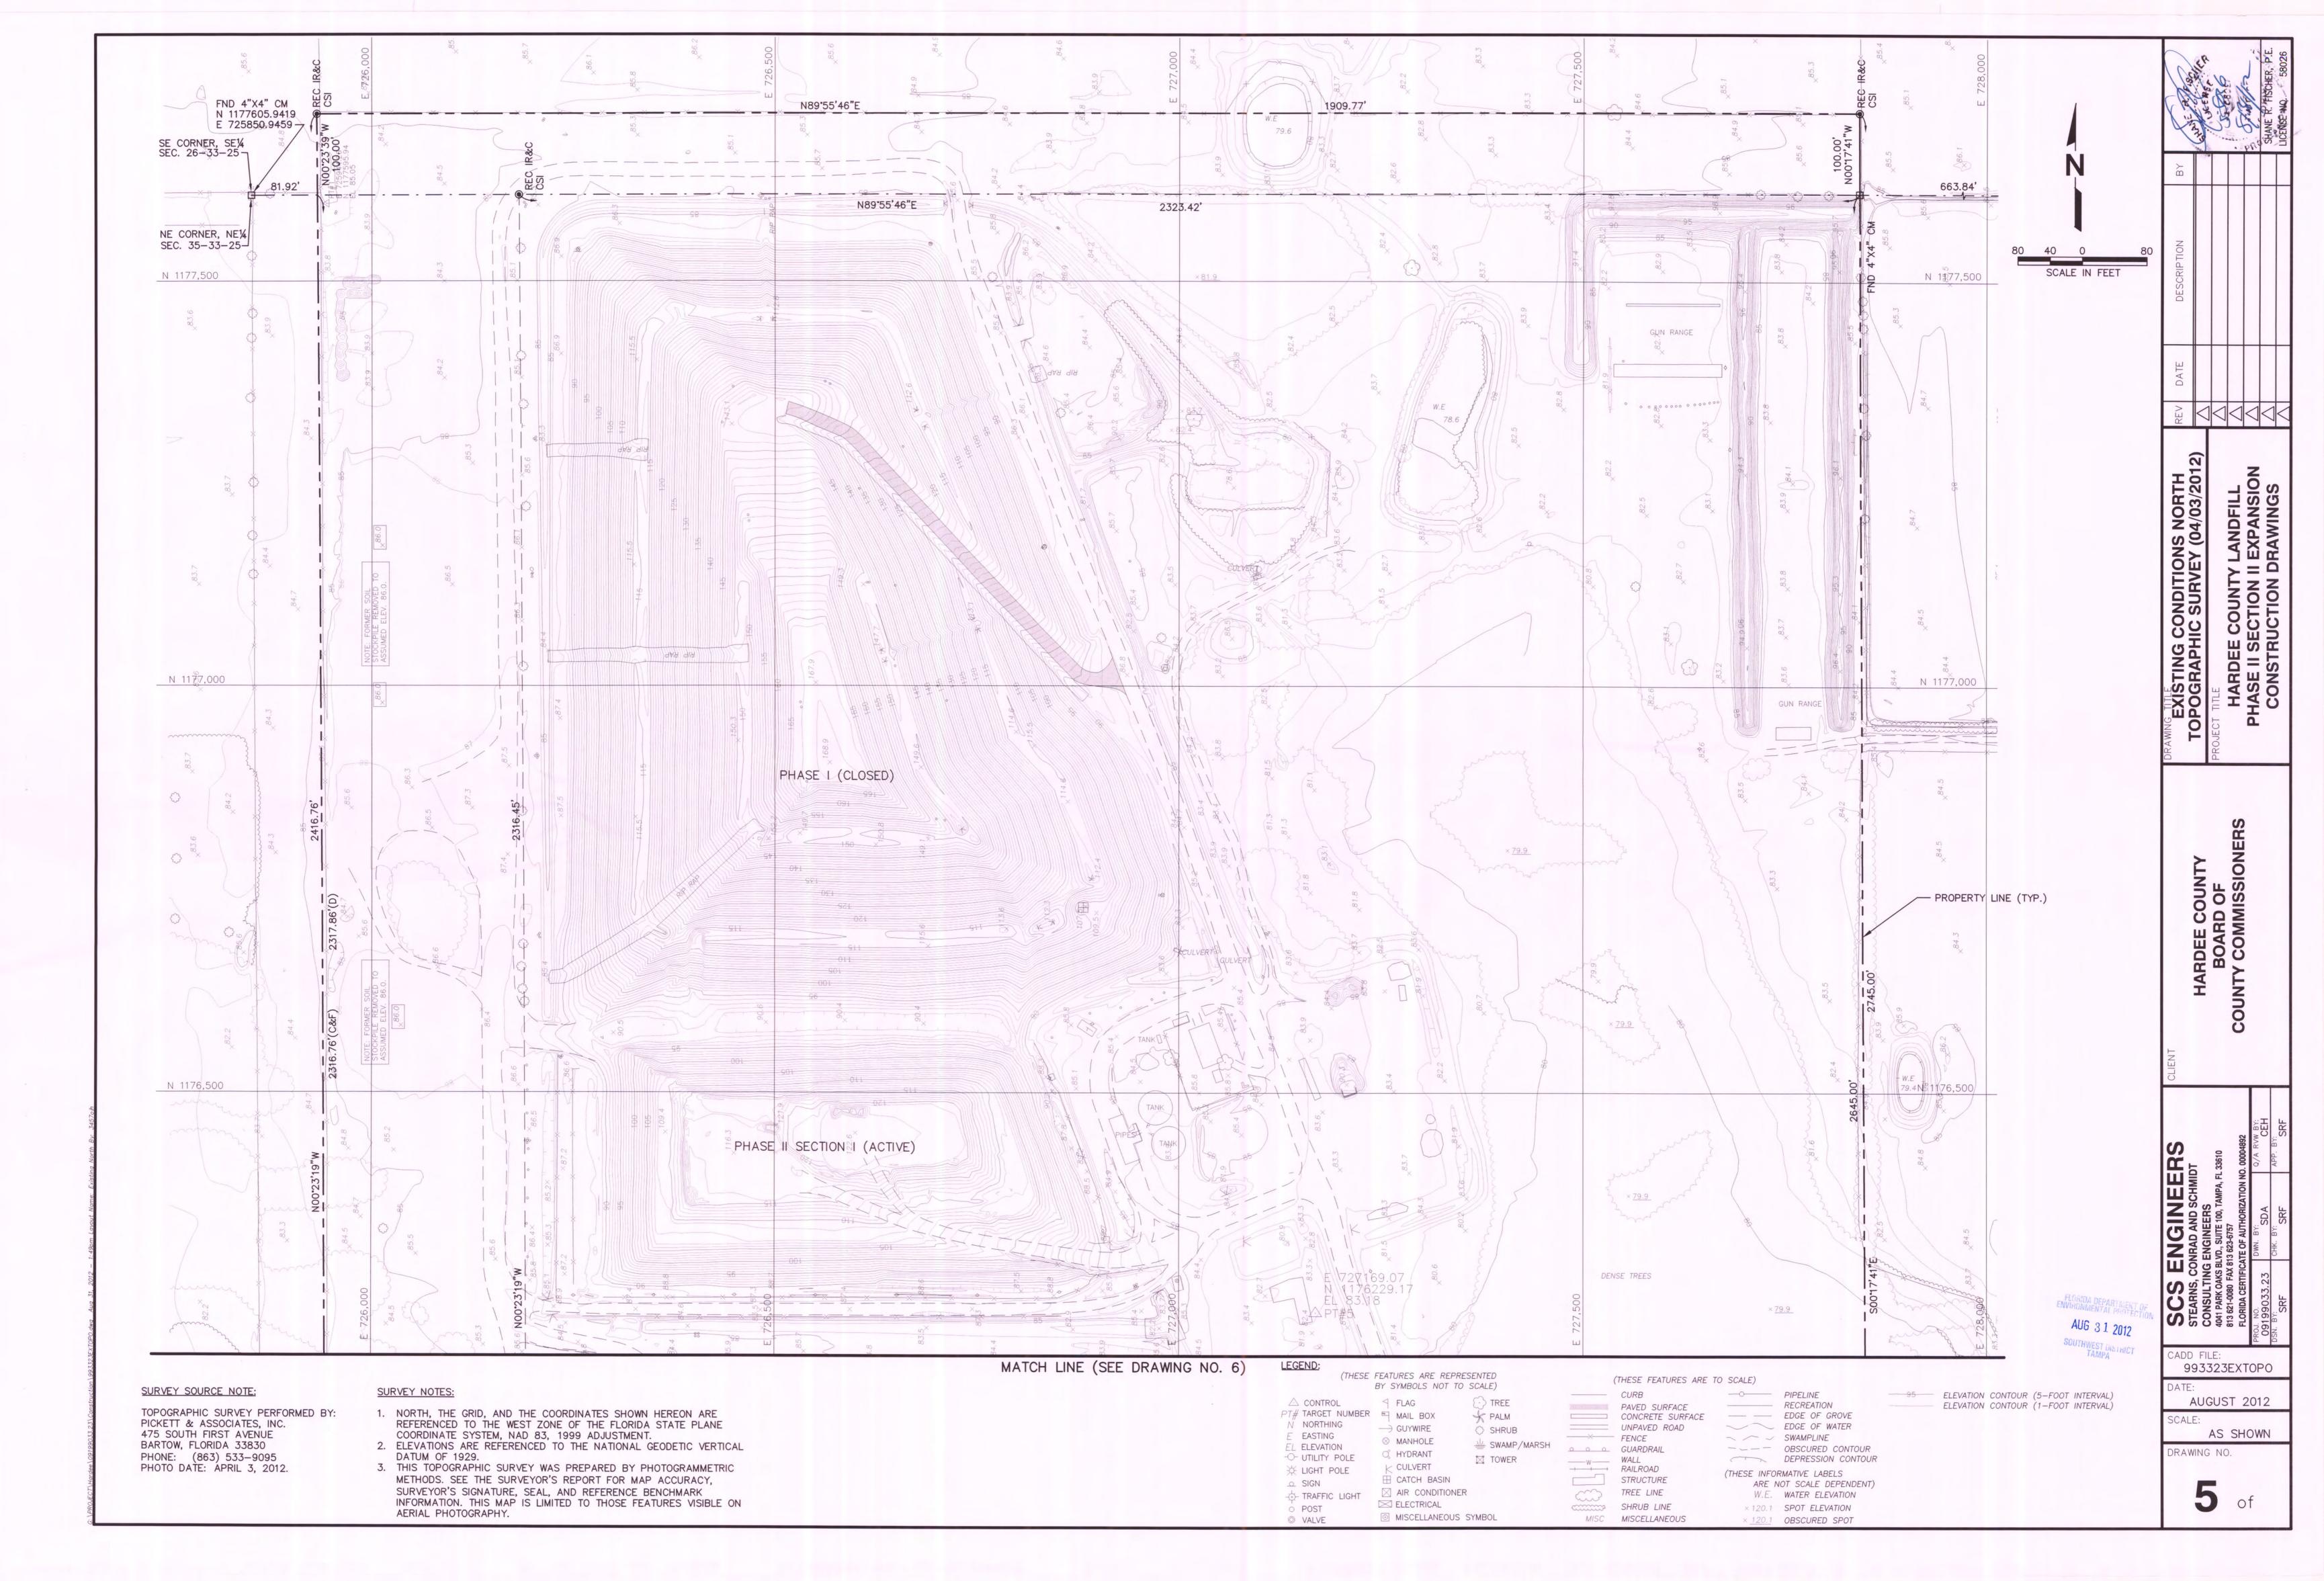


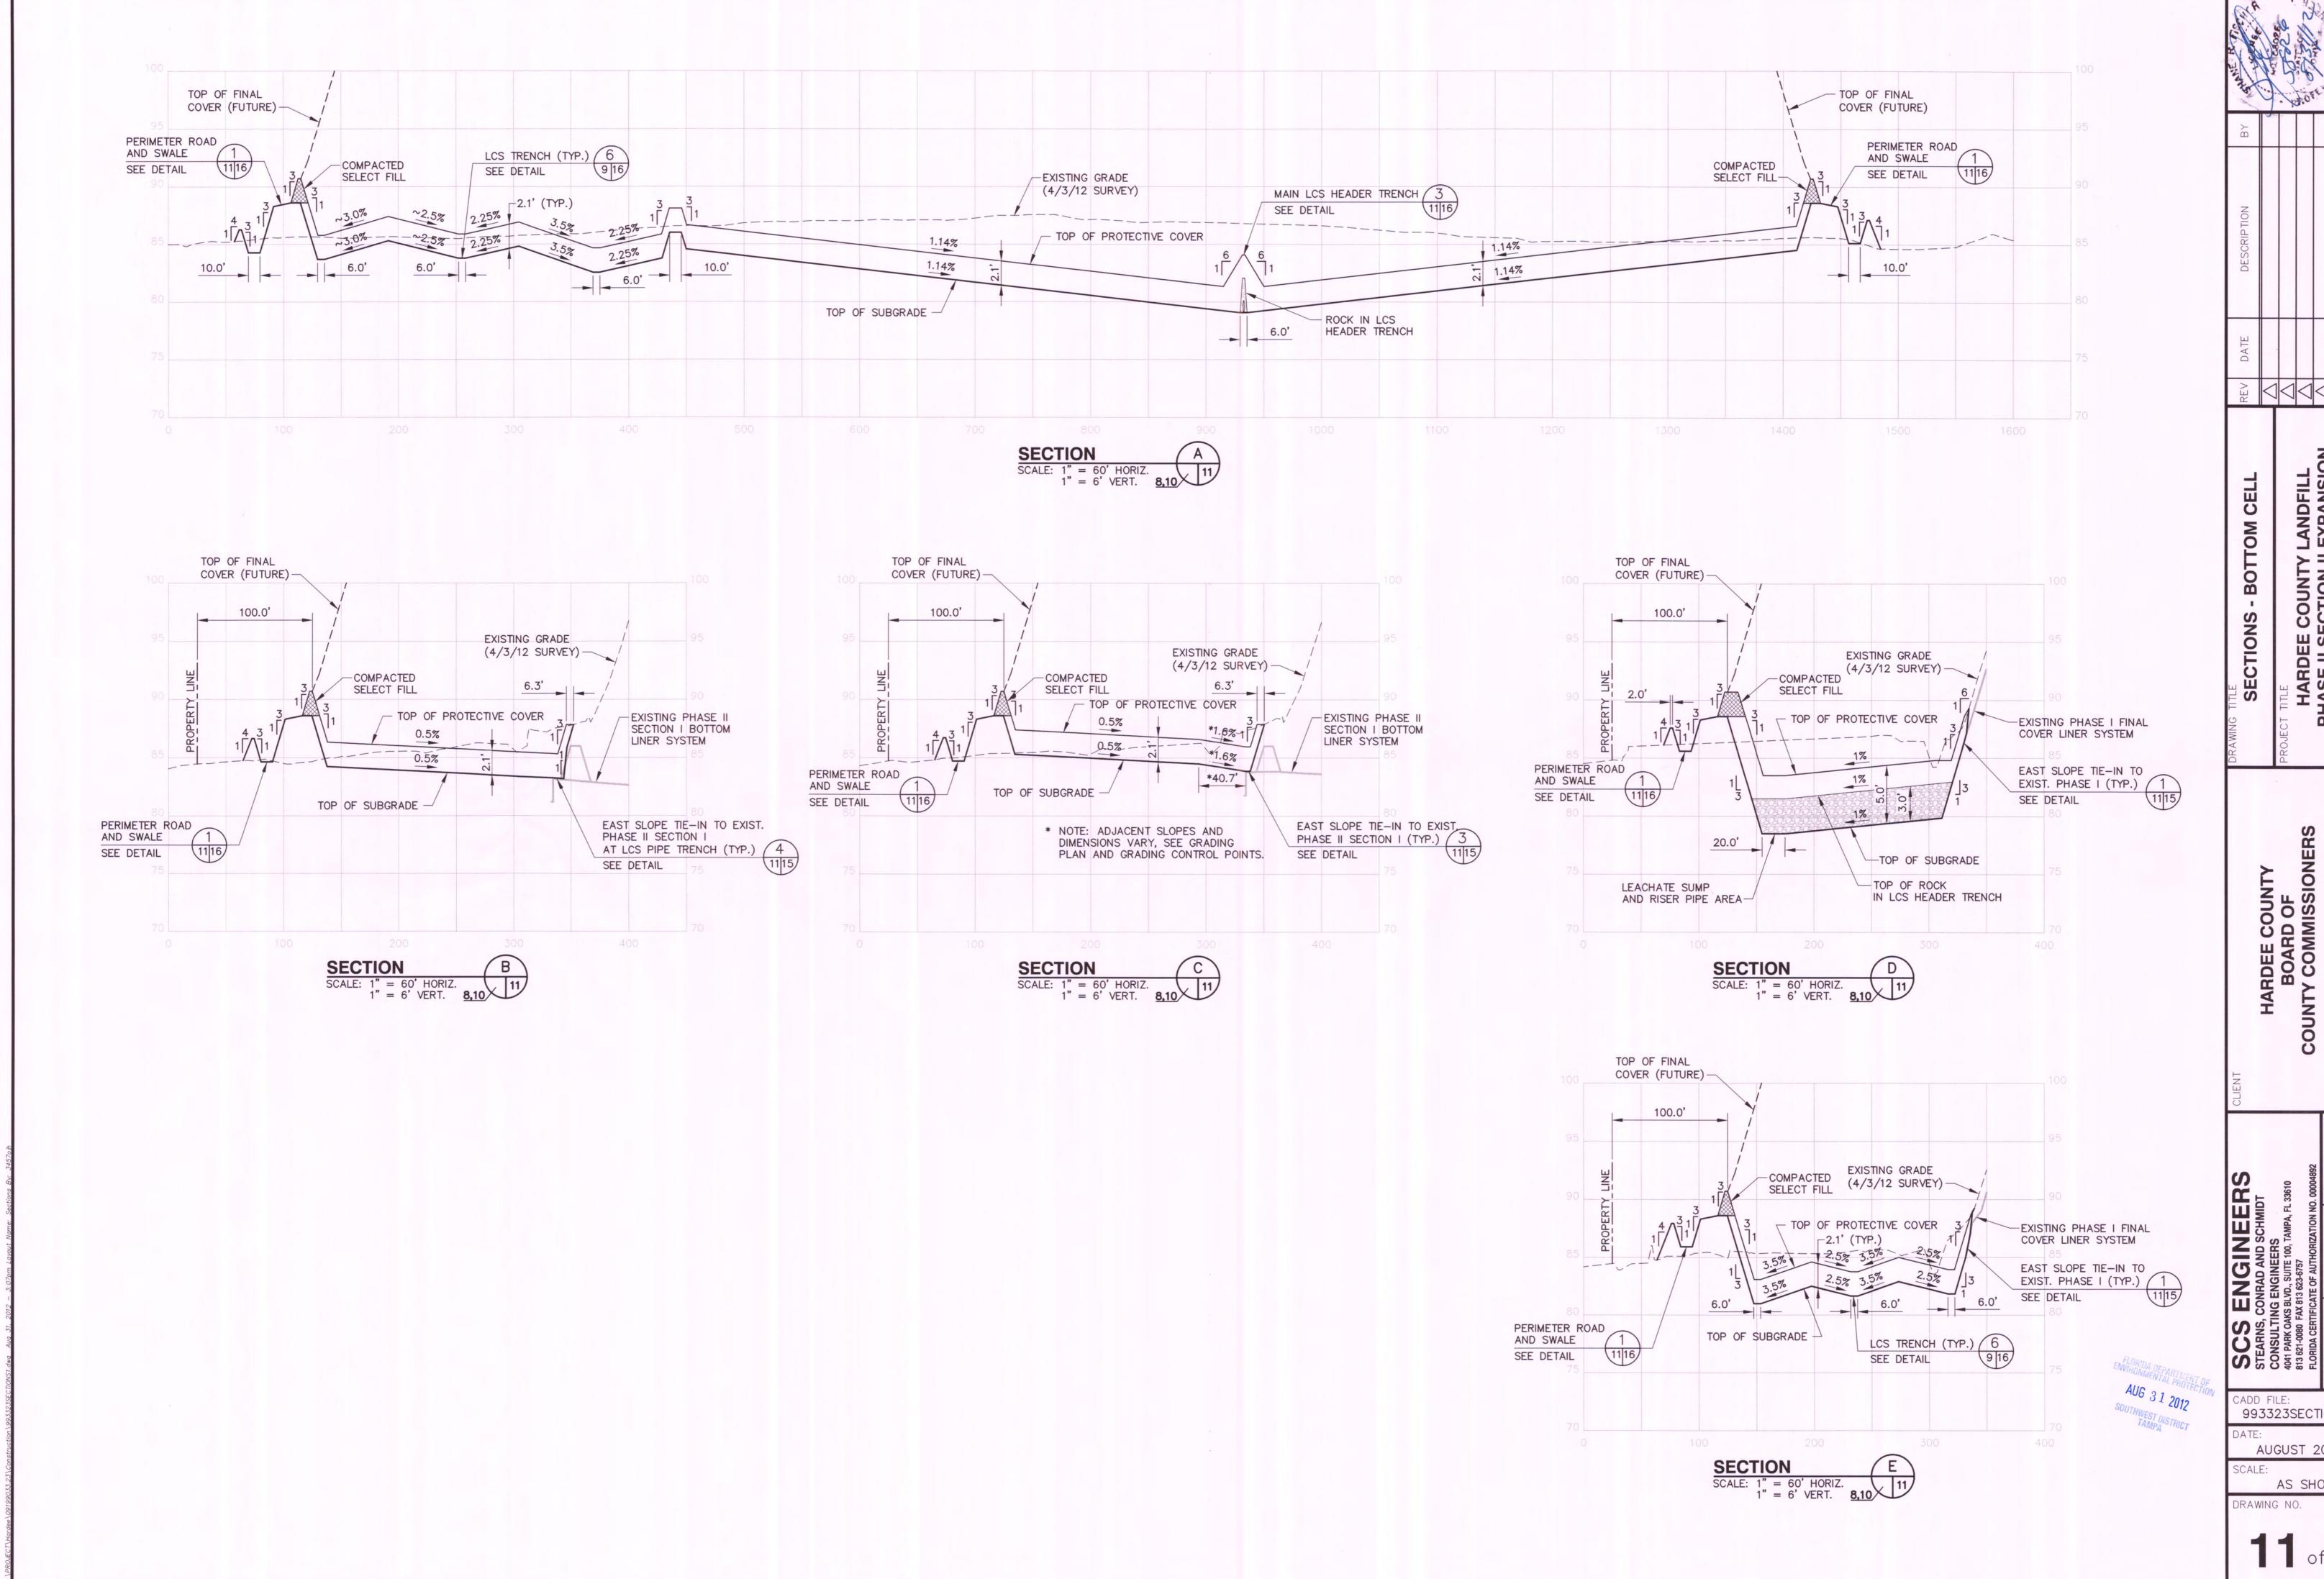



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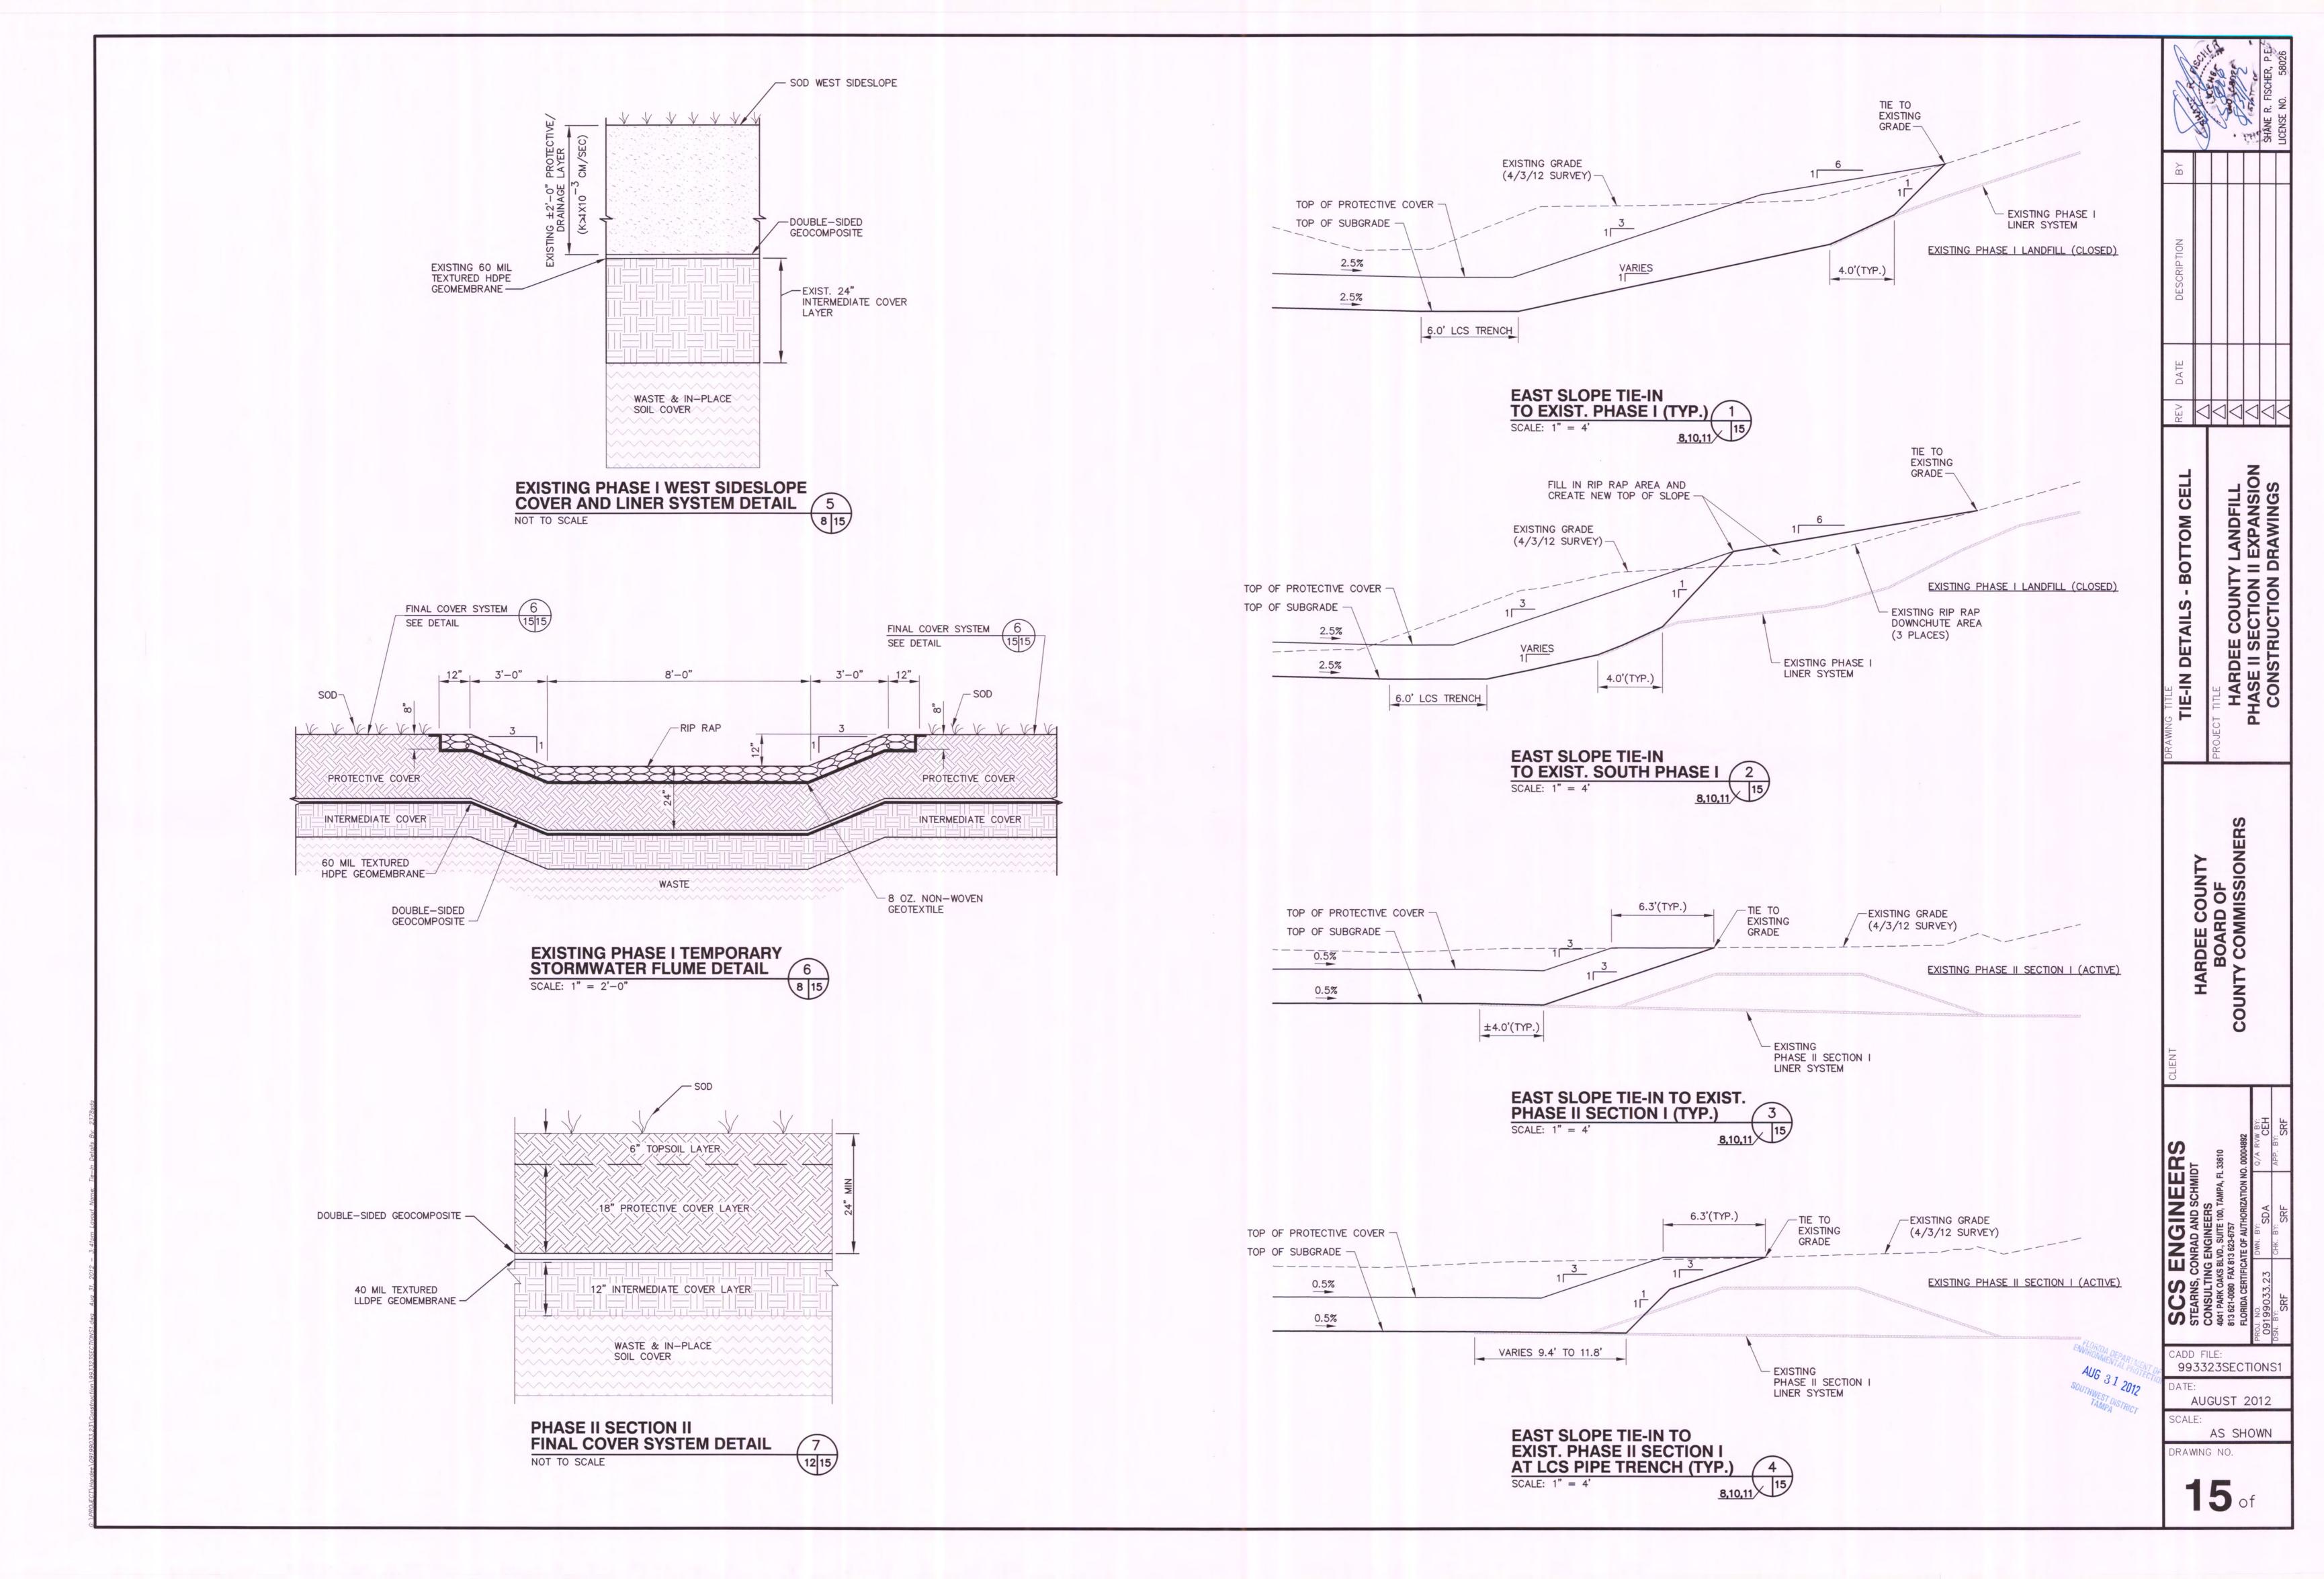
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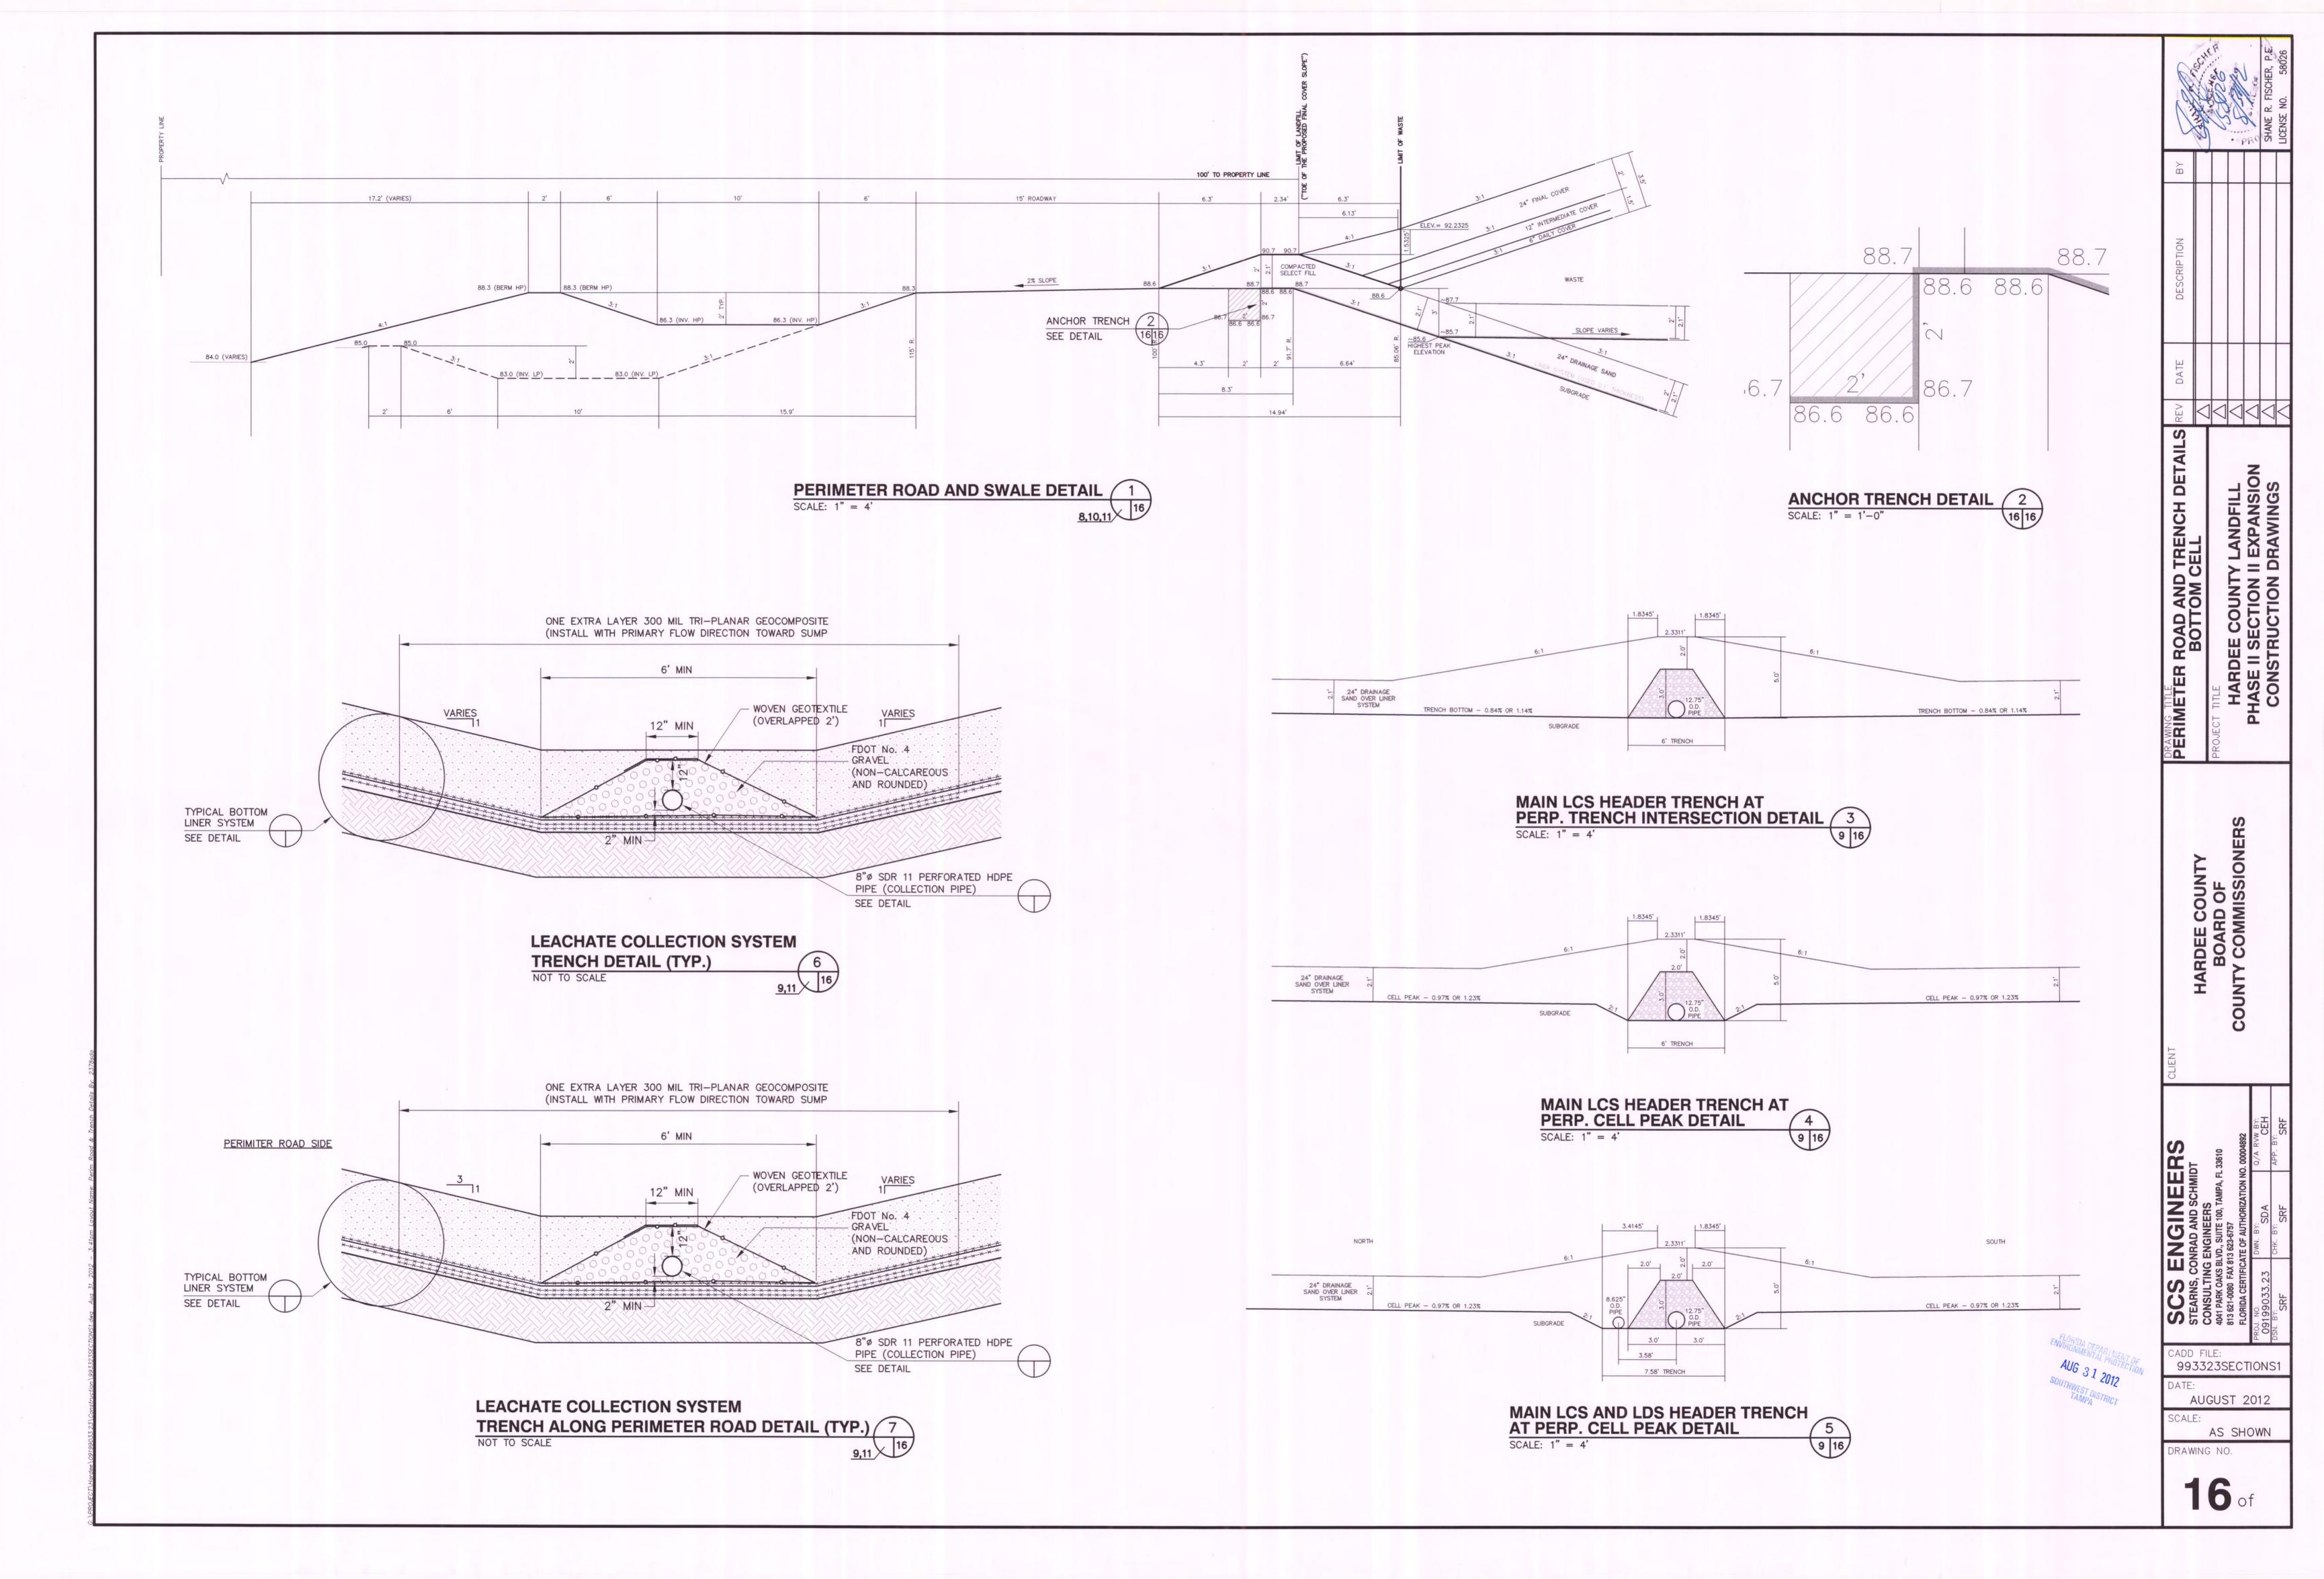
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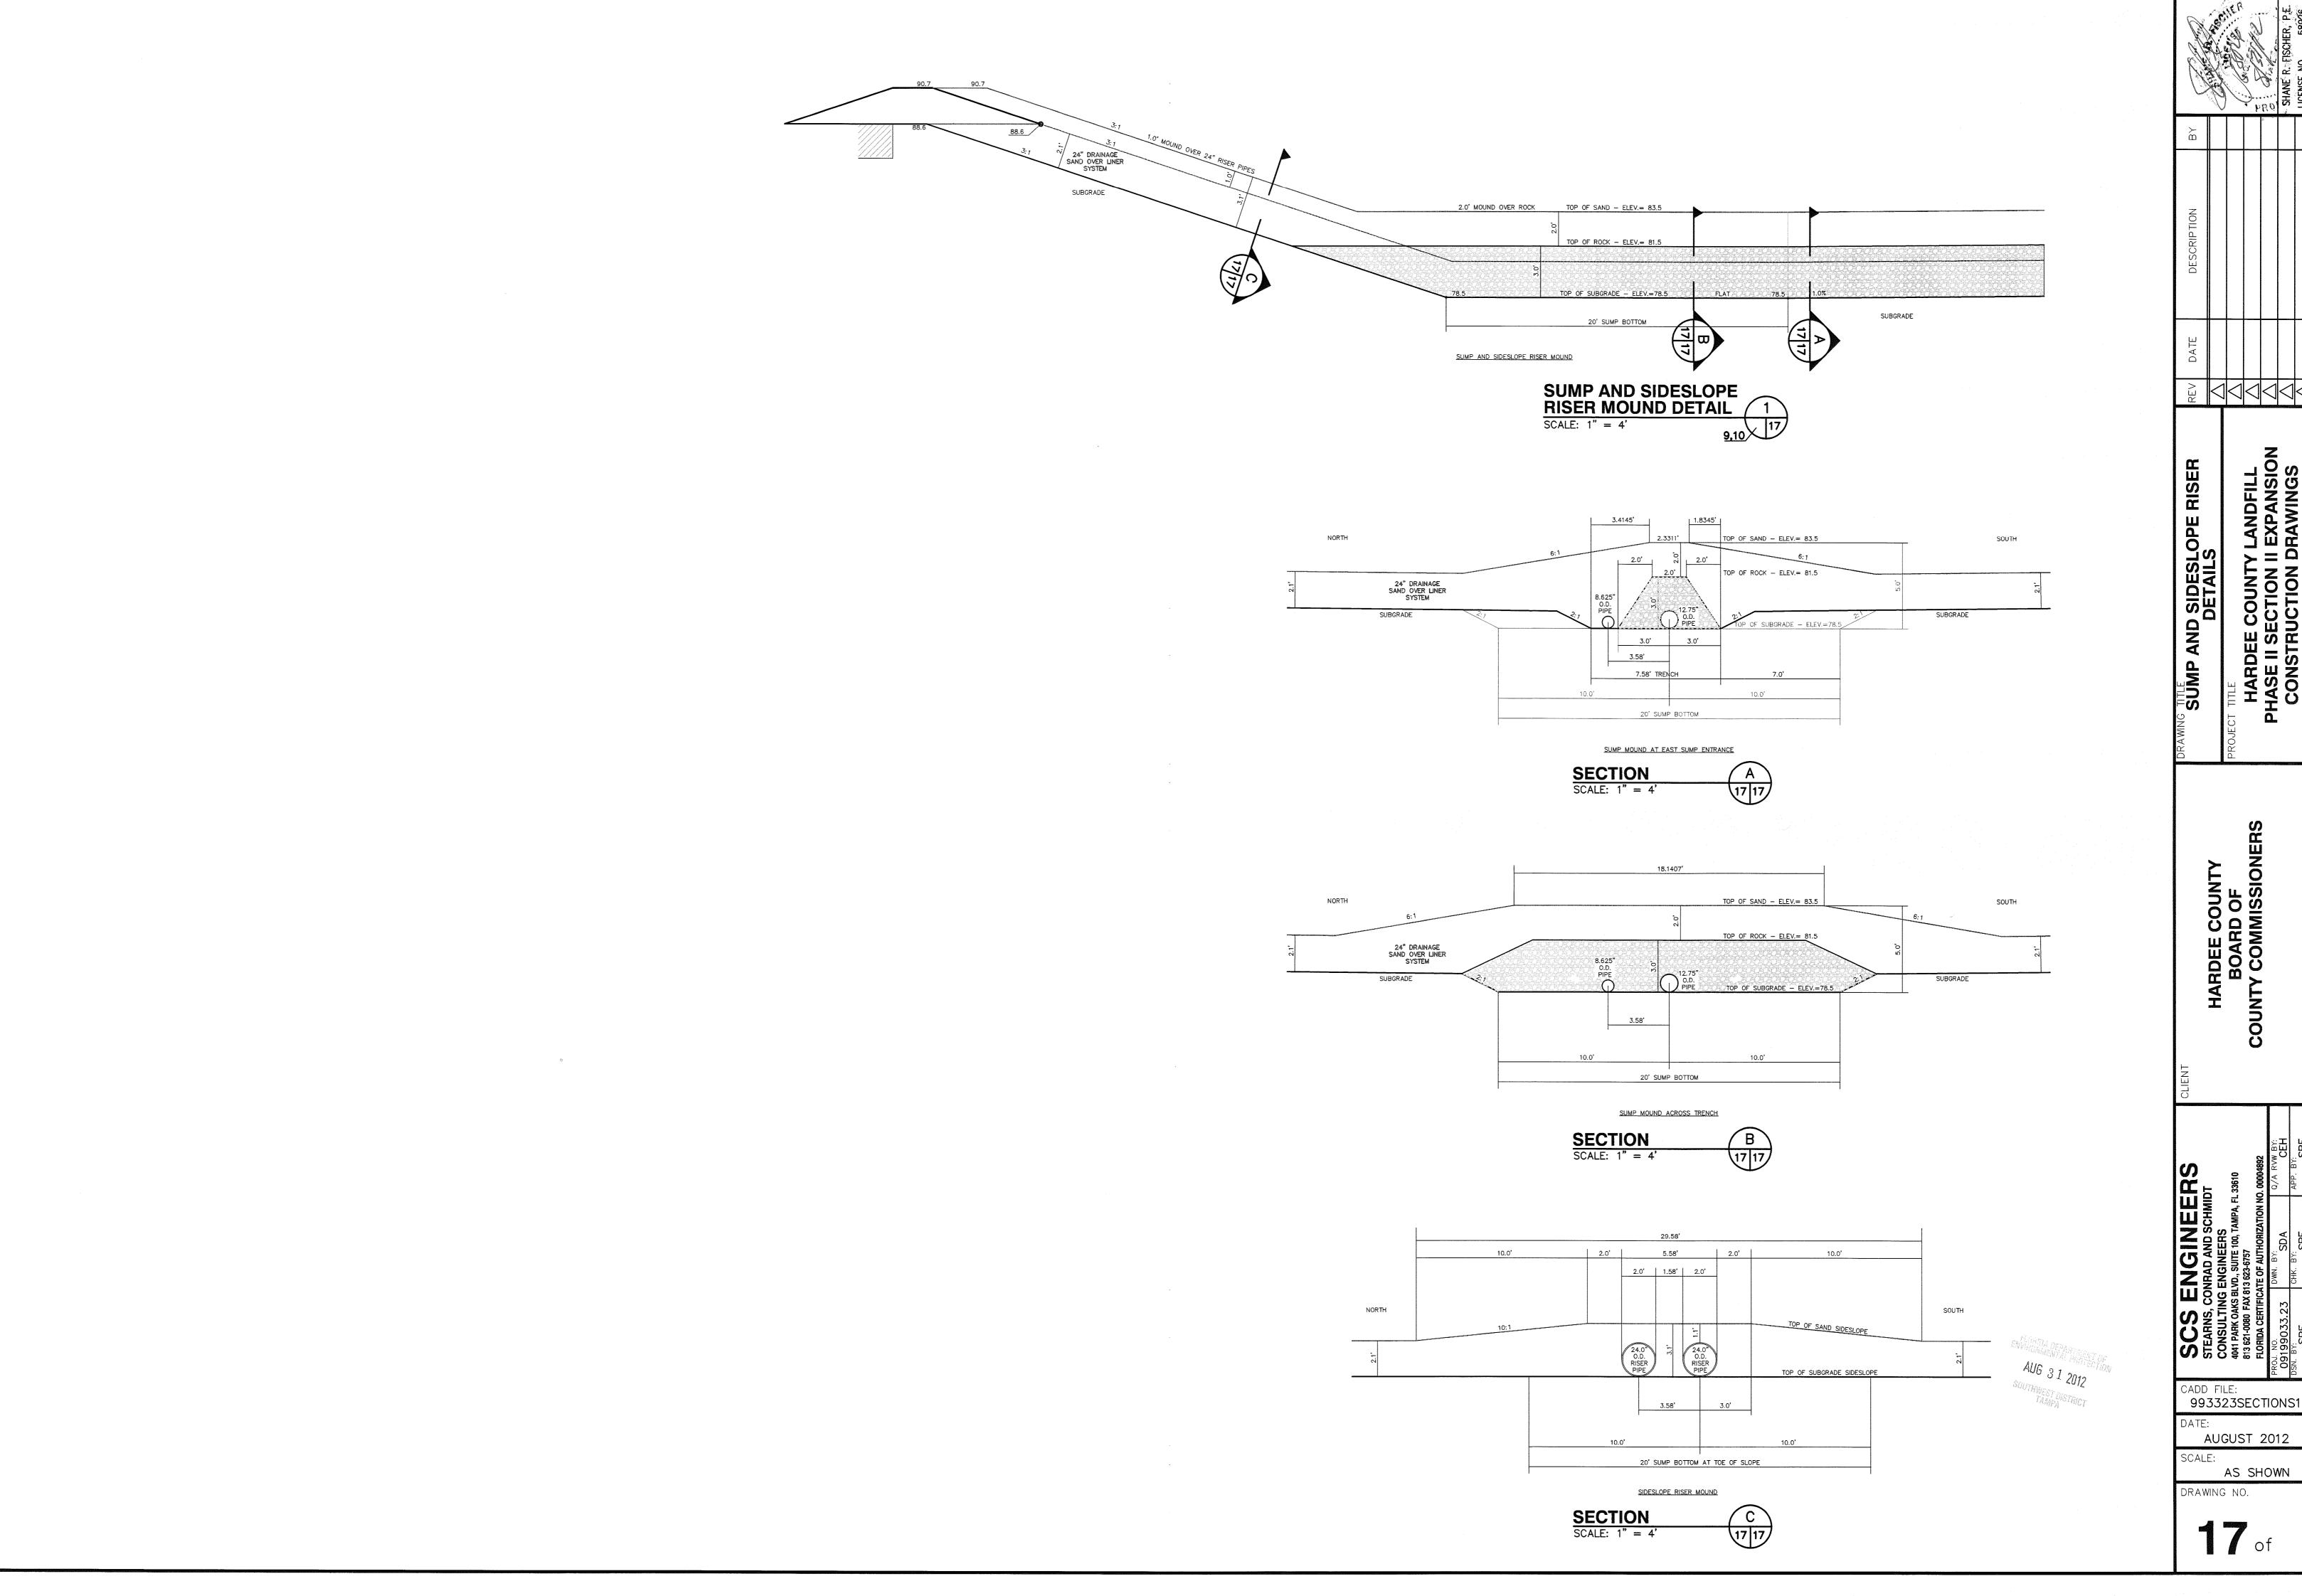








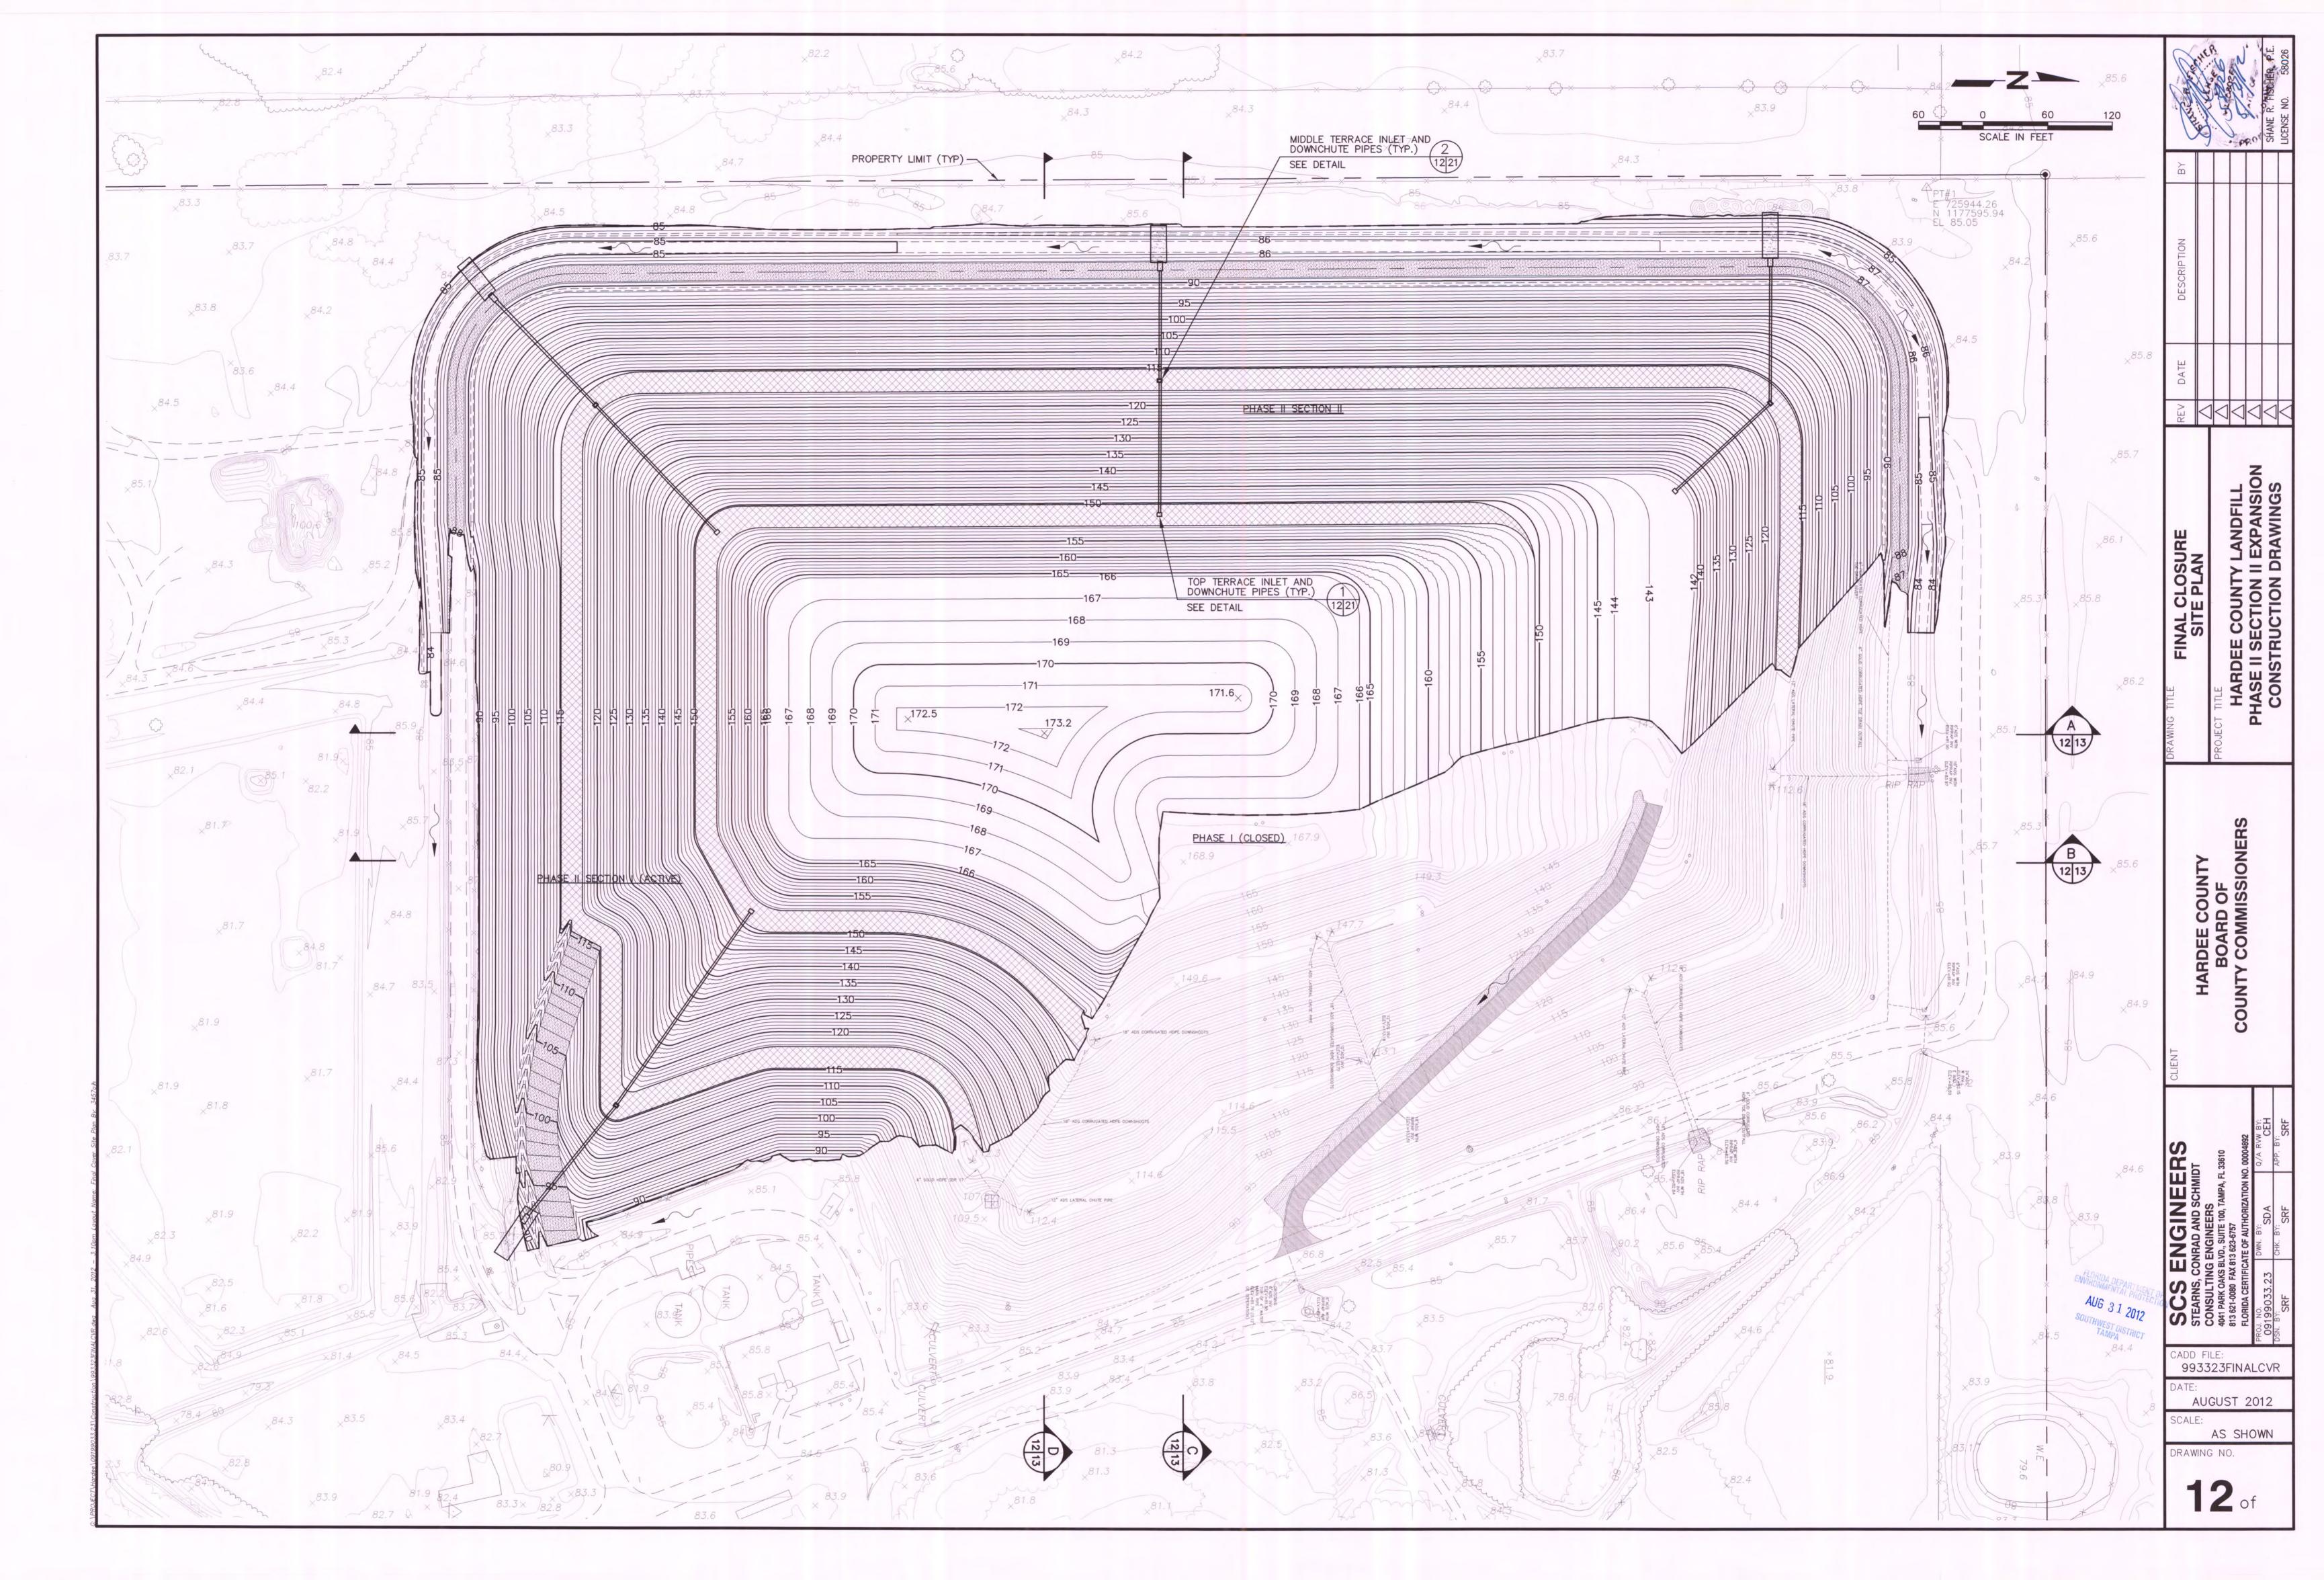

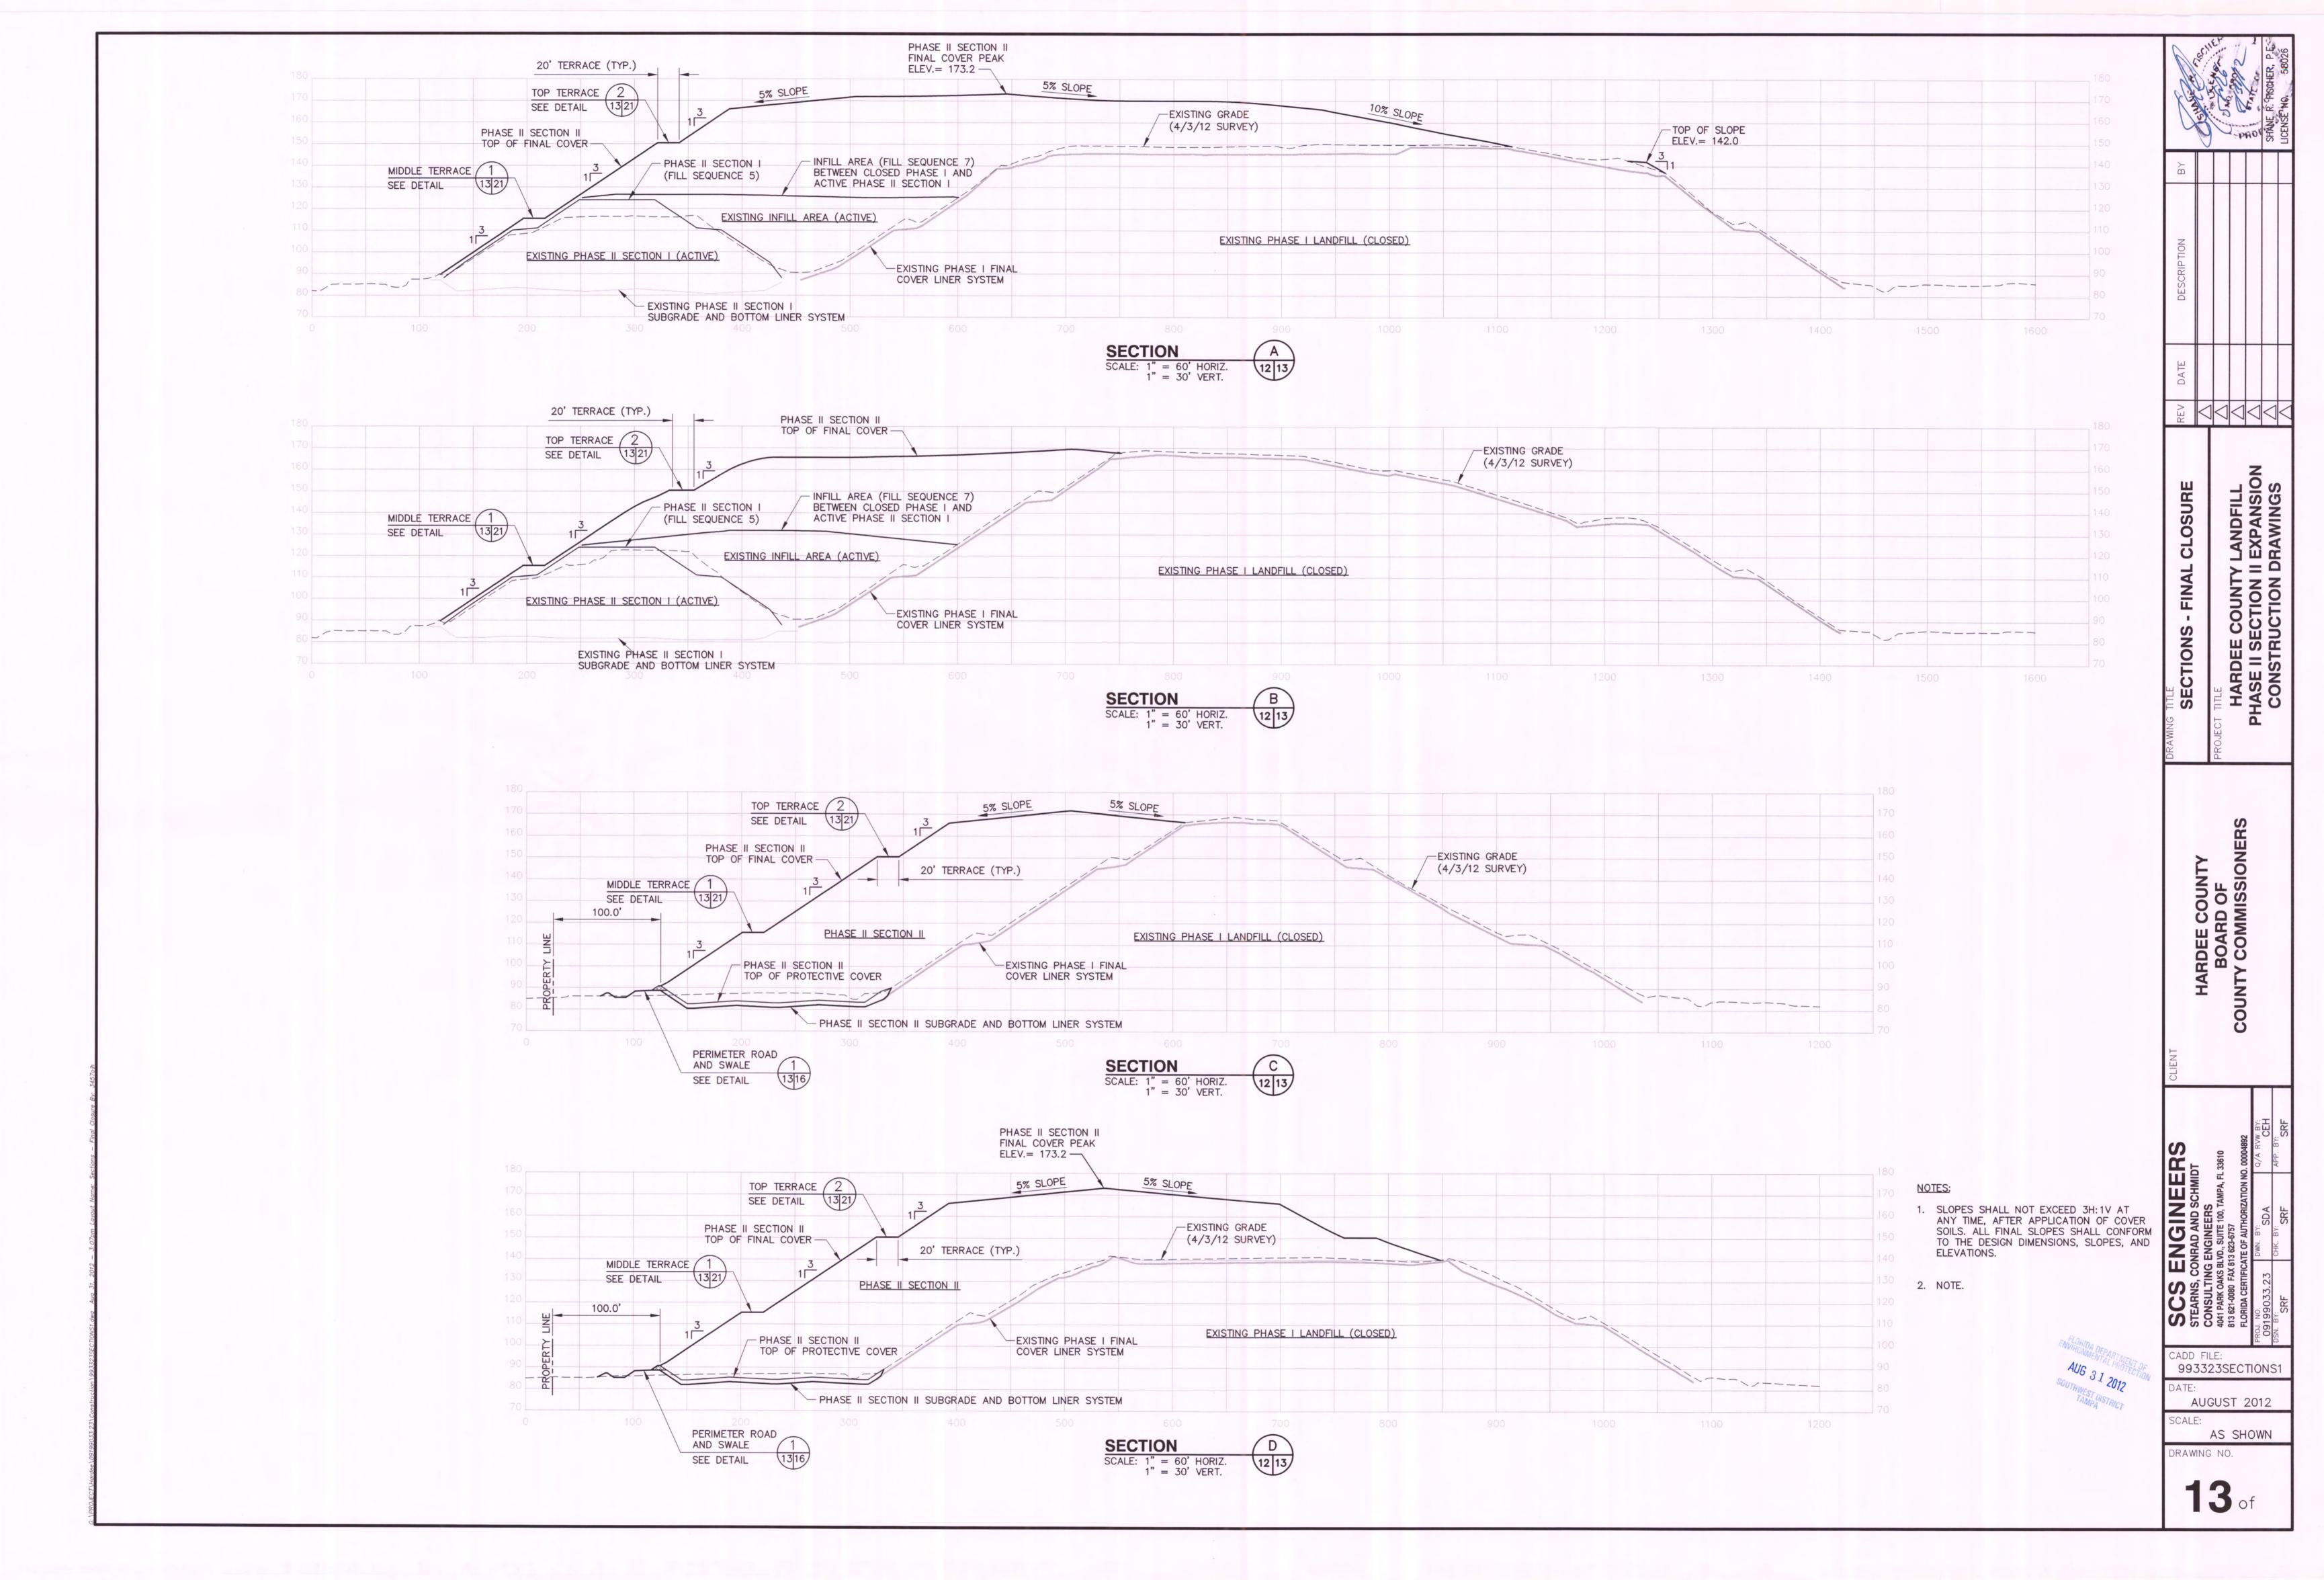

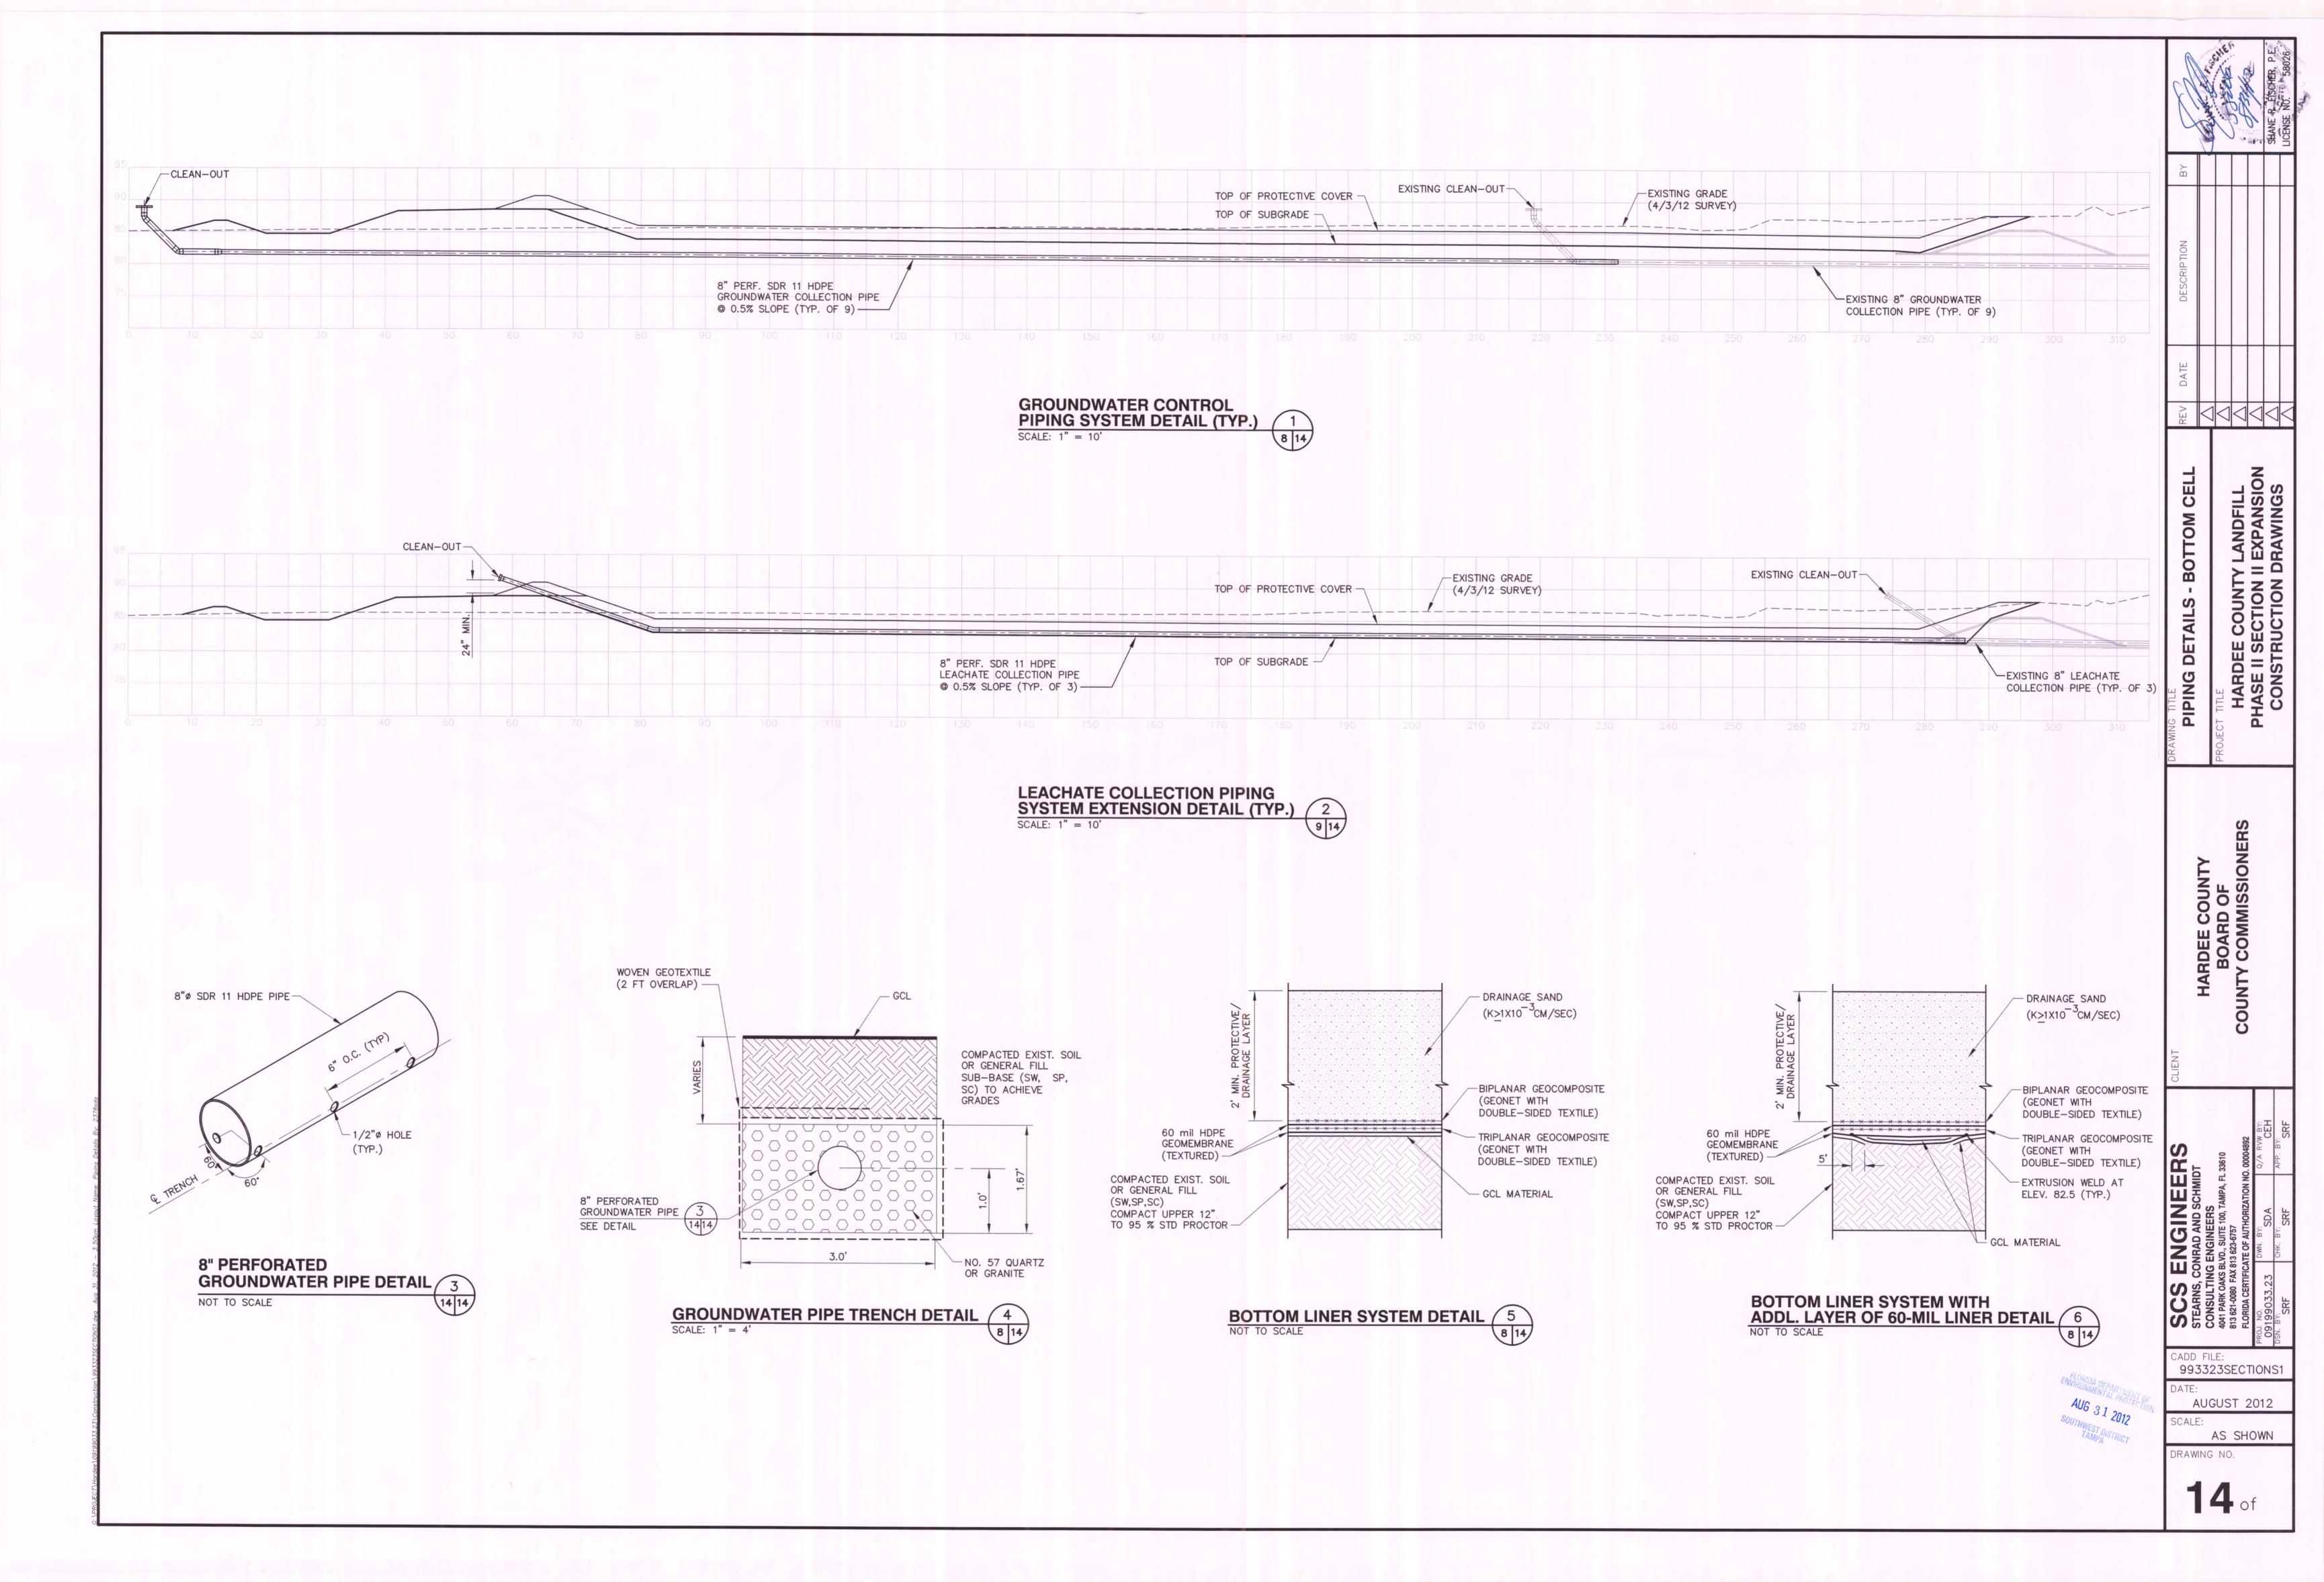

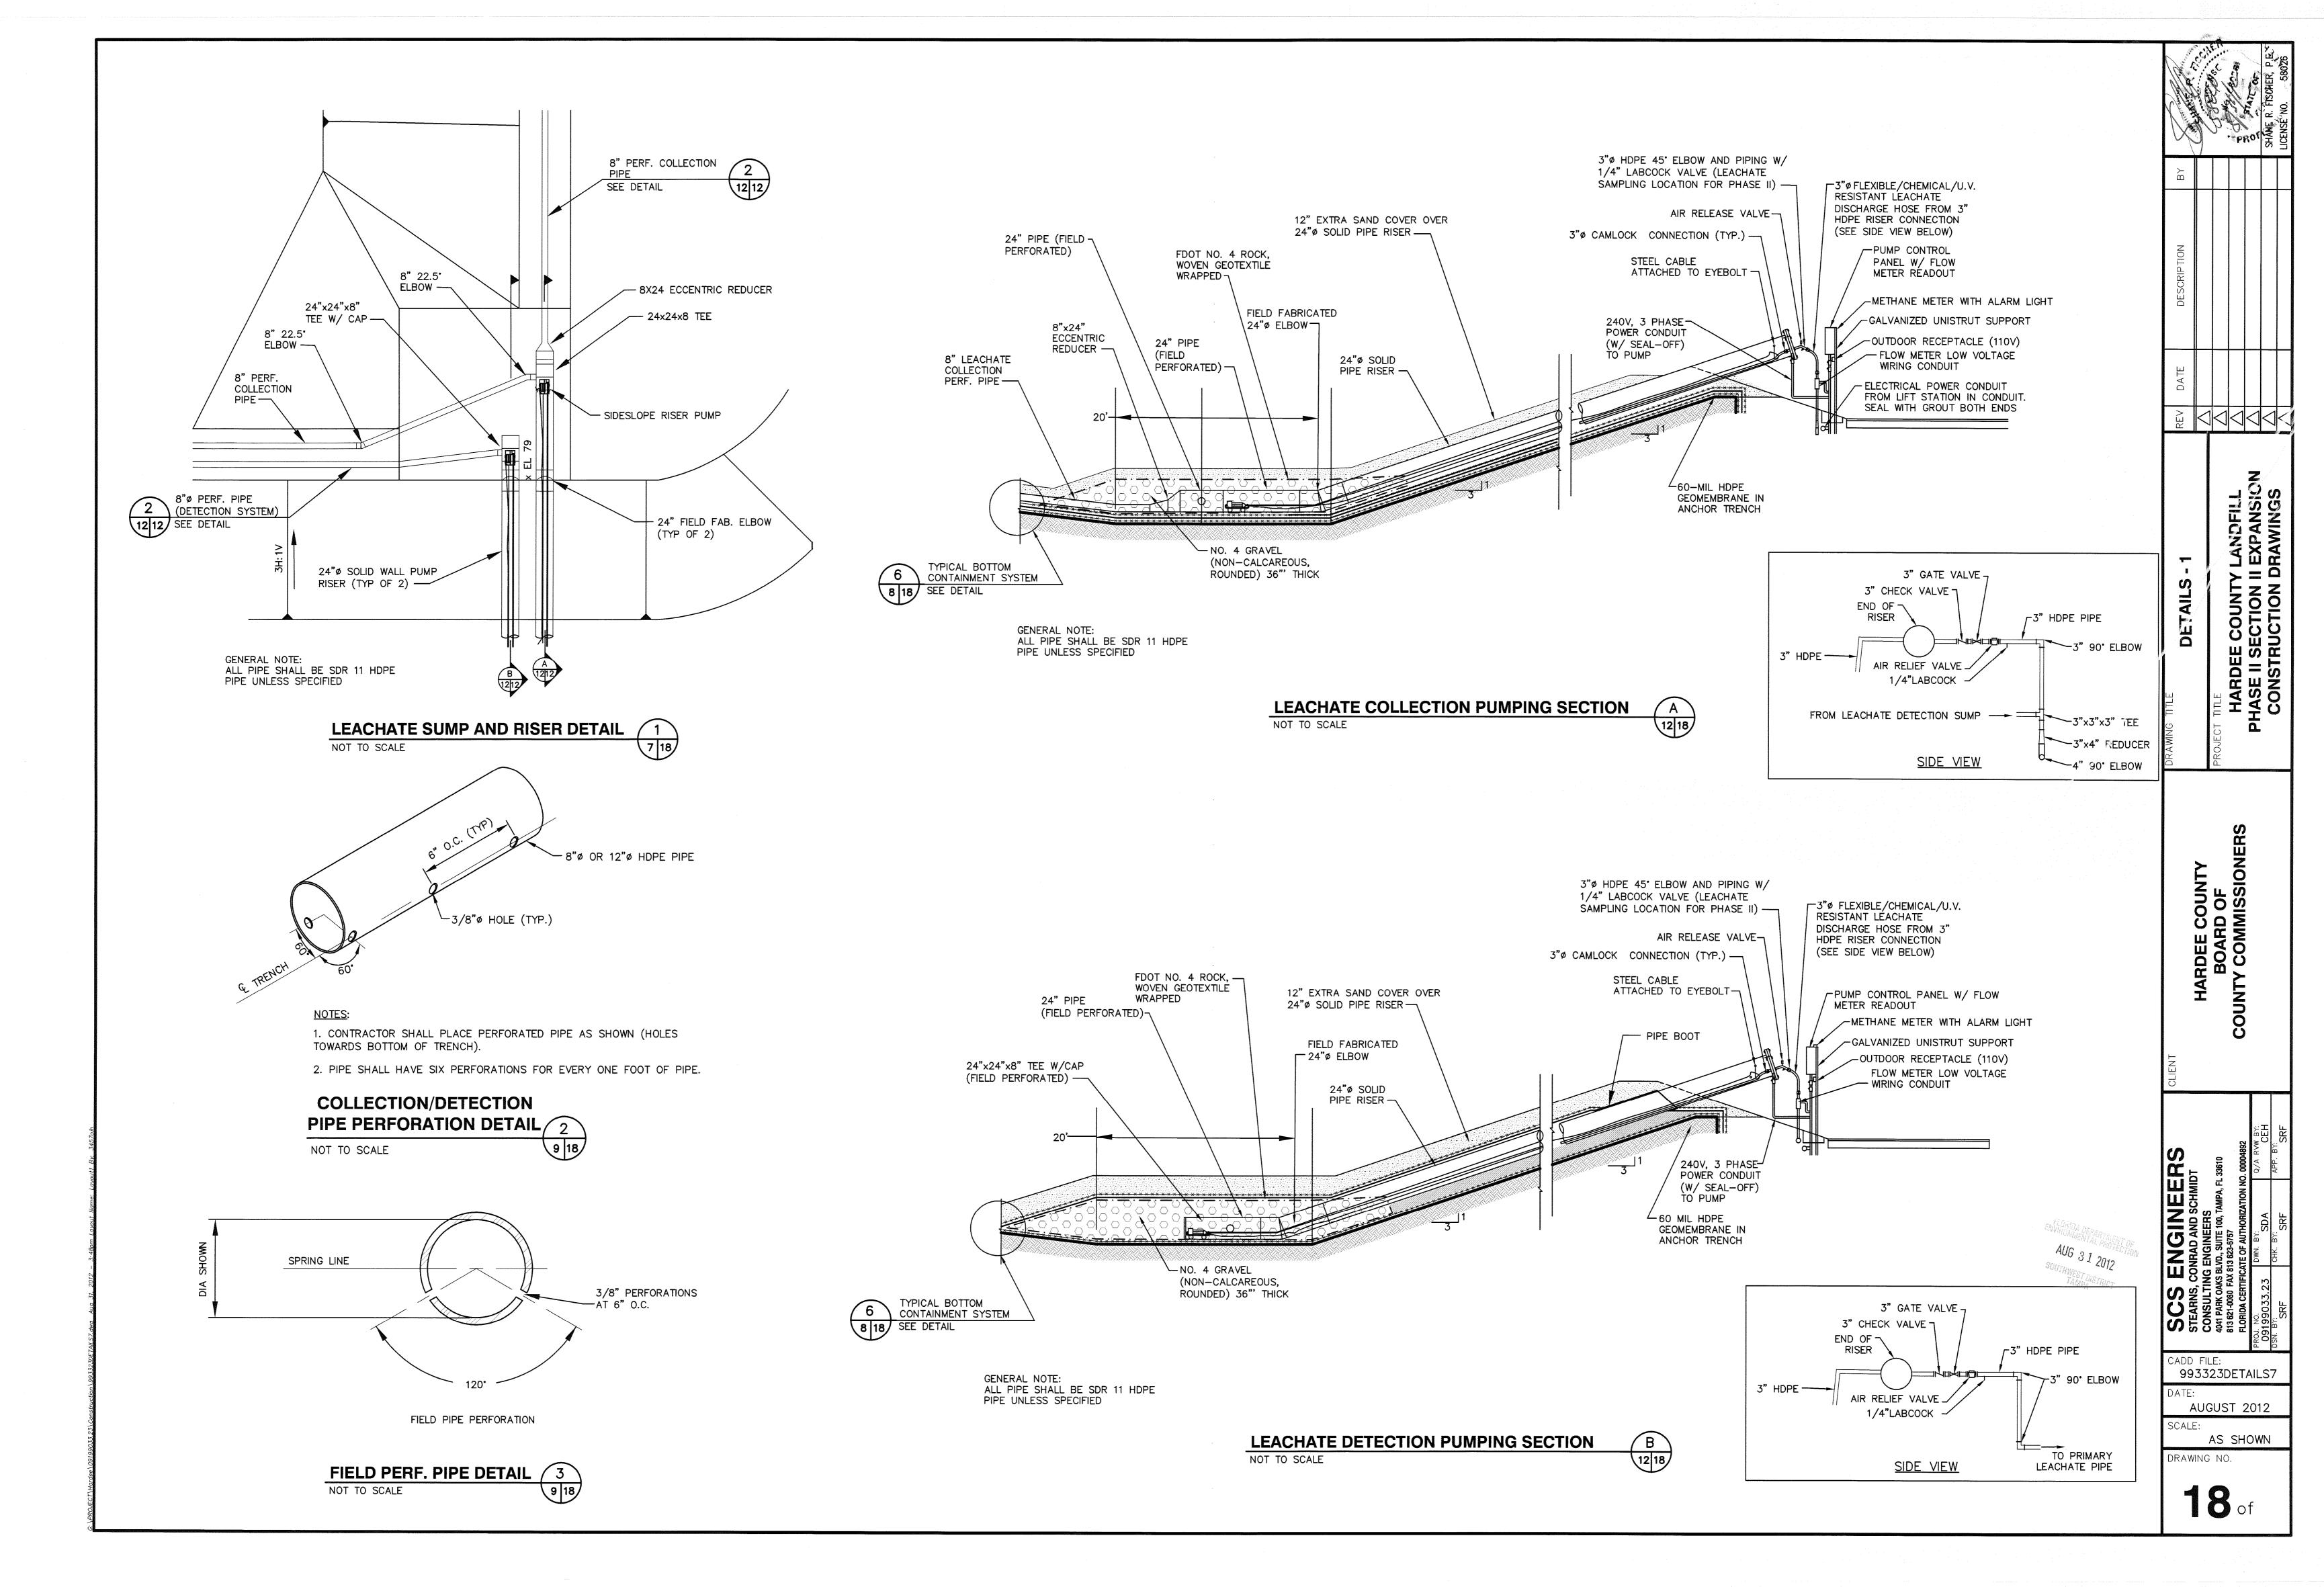

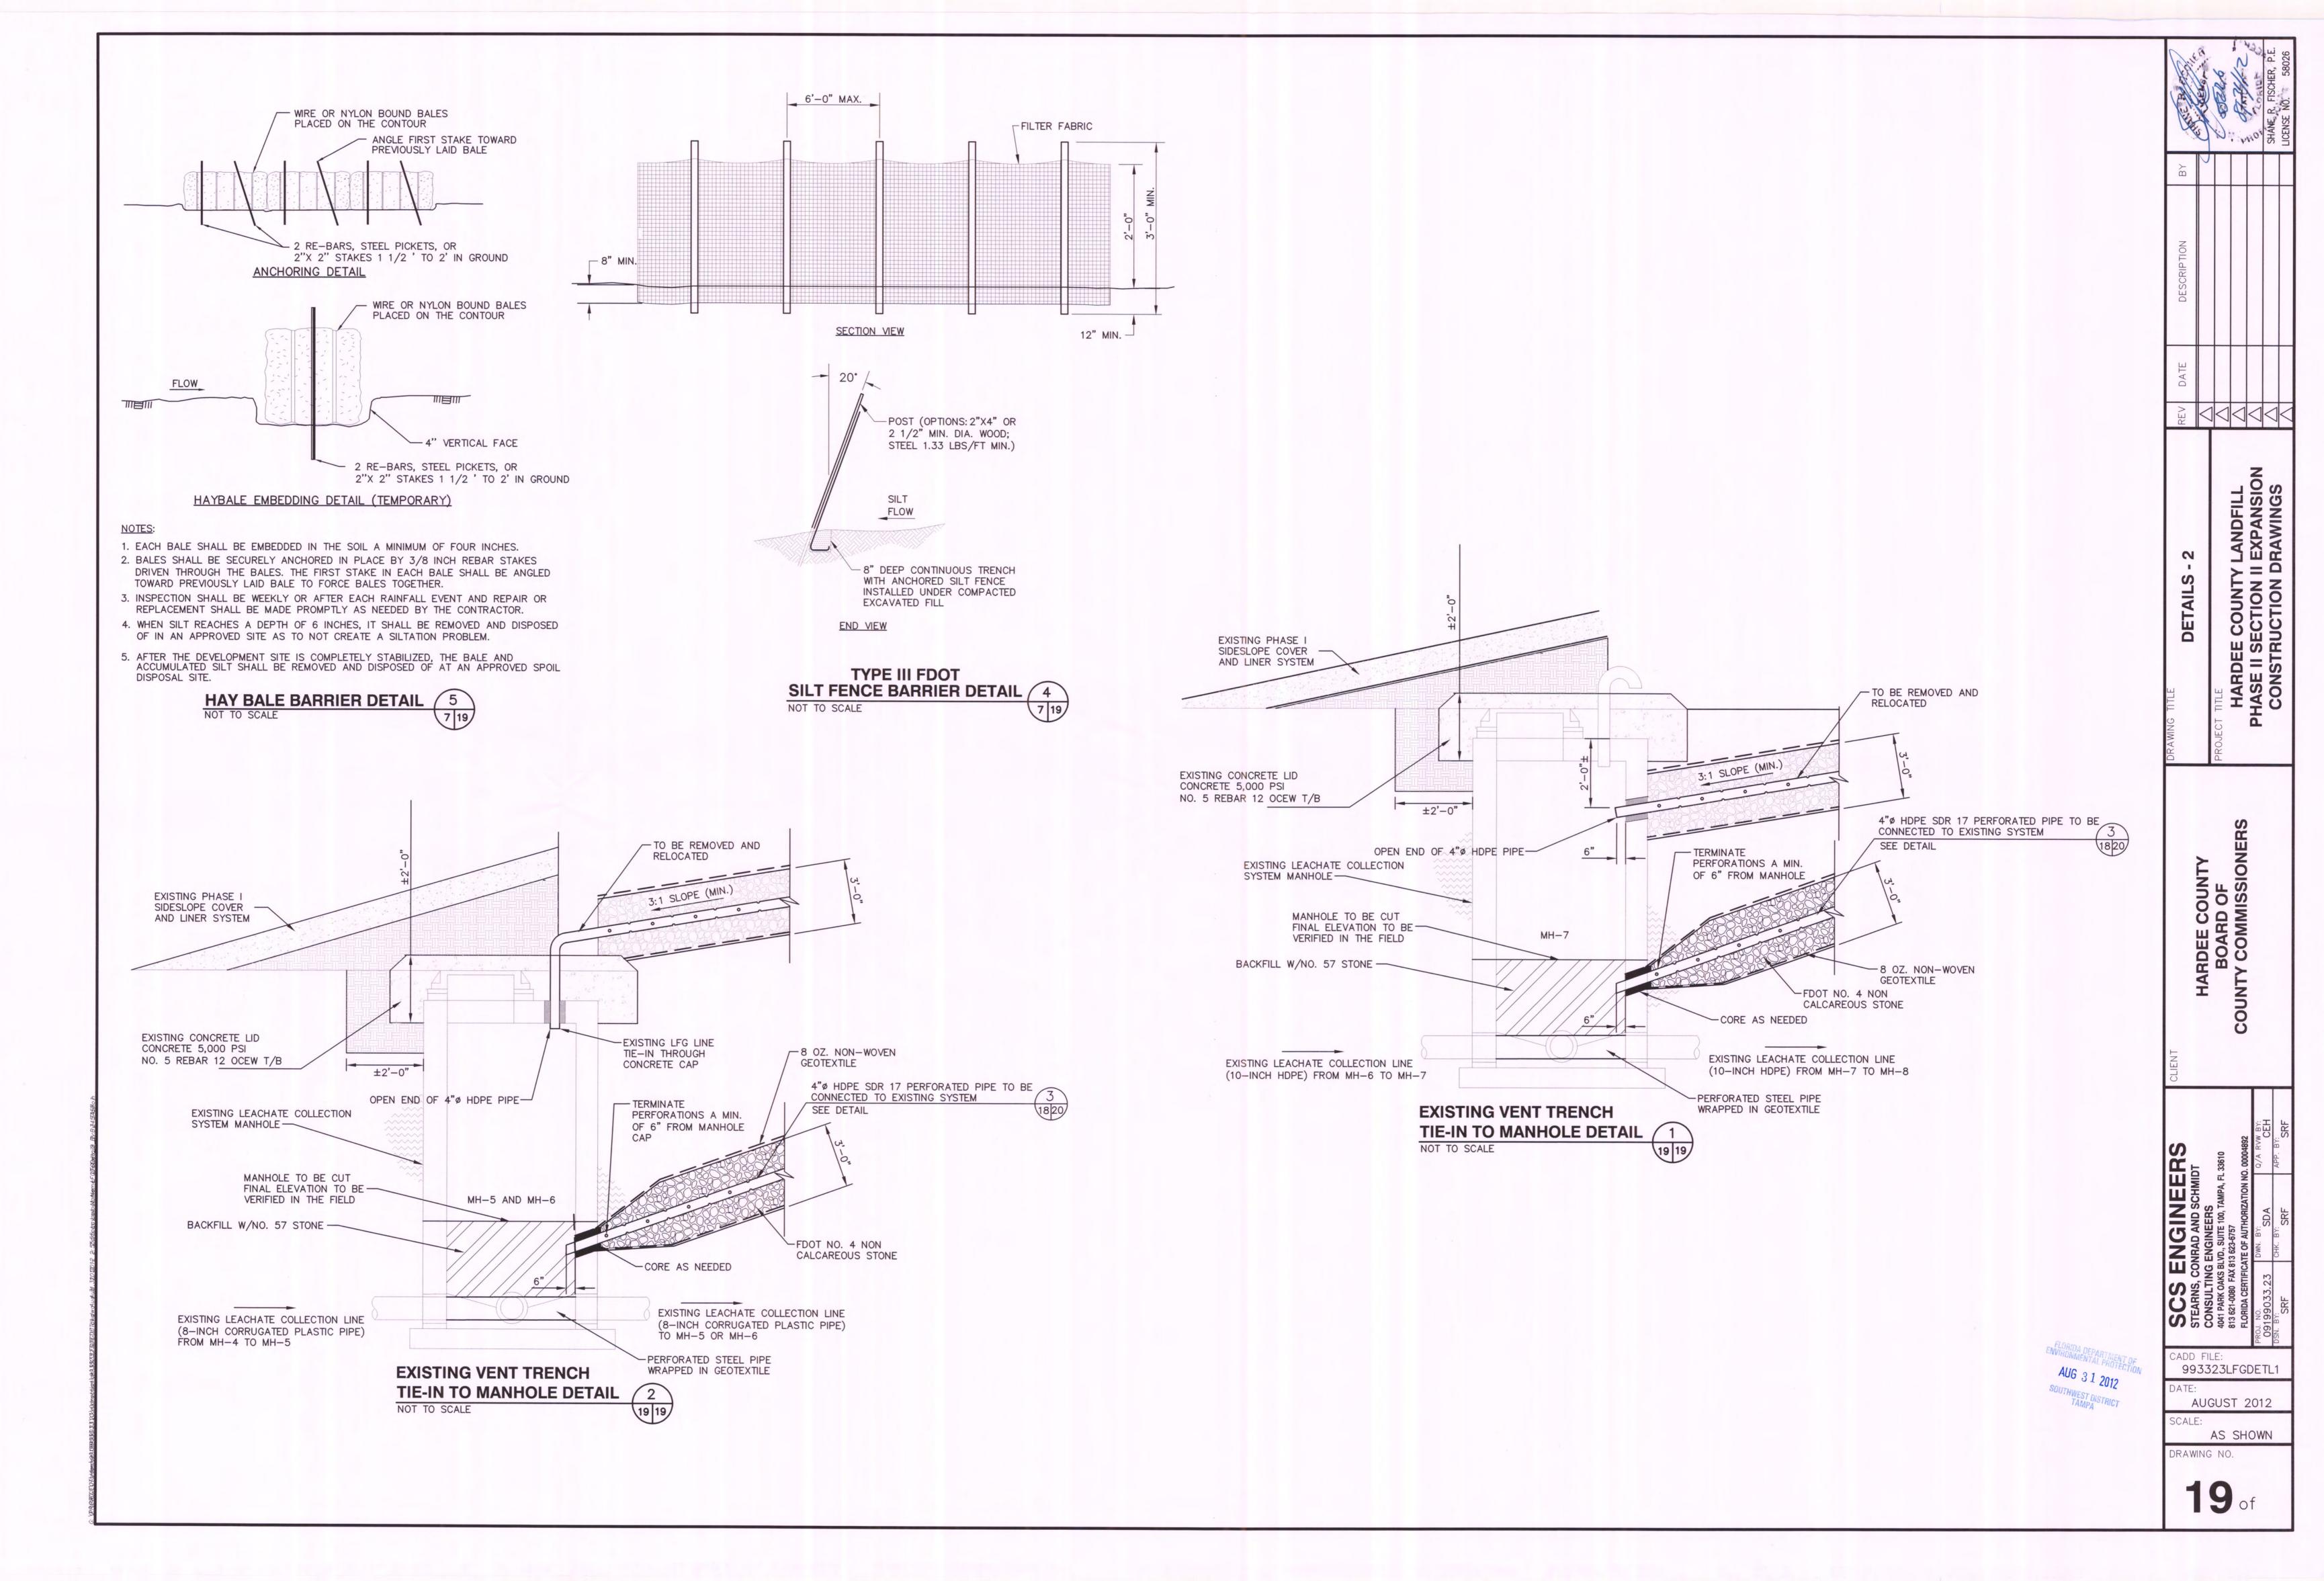

### LANDFILL GAS MONITORING PROBE SCHEDULE

Solid Pipe | Solid Pipe

Length

Grade

3

3

3

3

3

3

Above

Length

Below

Grade

2.5

2.5

2.5

2.5

2.5

2.5

Slotted

Pipe

Length

5.06


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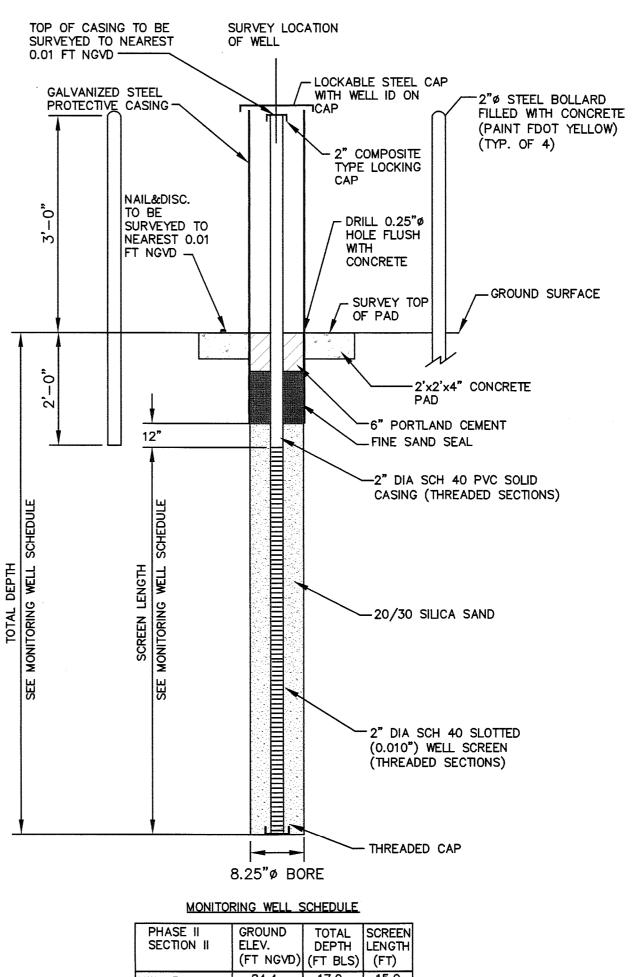
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7.42


6.92

8.09



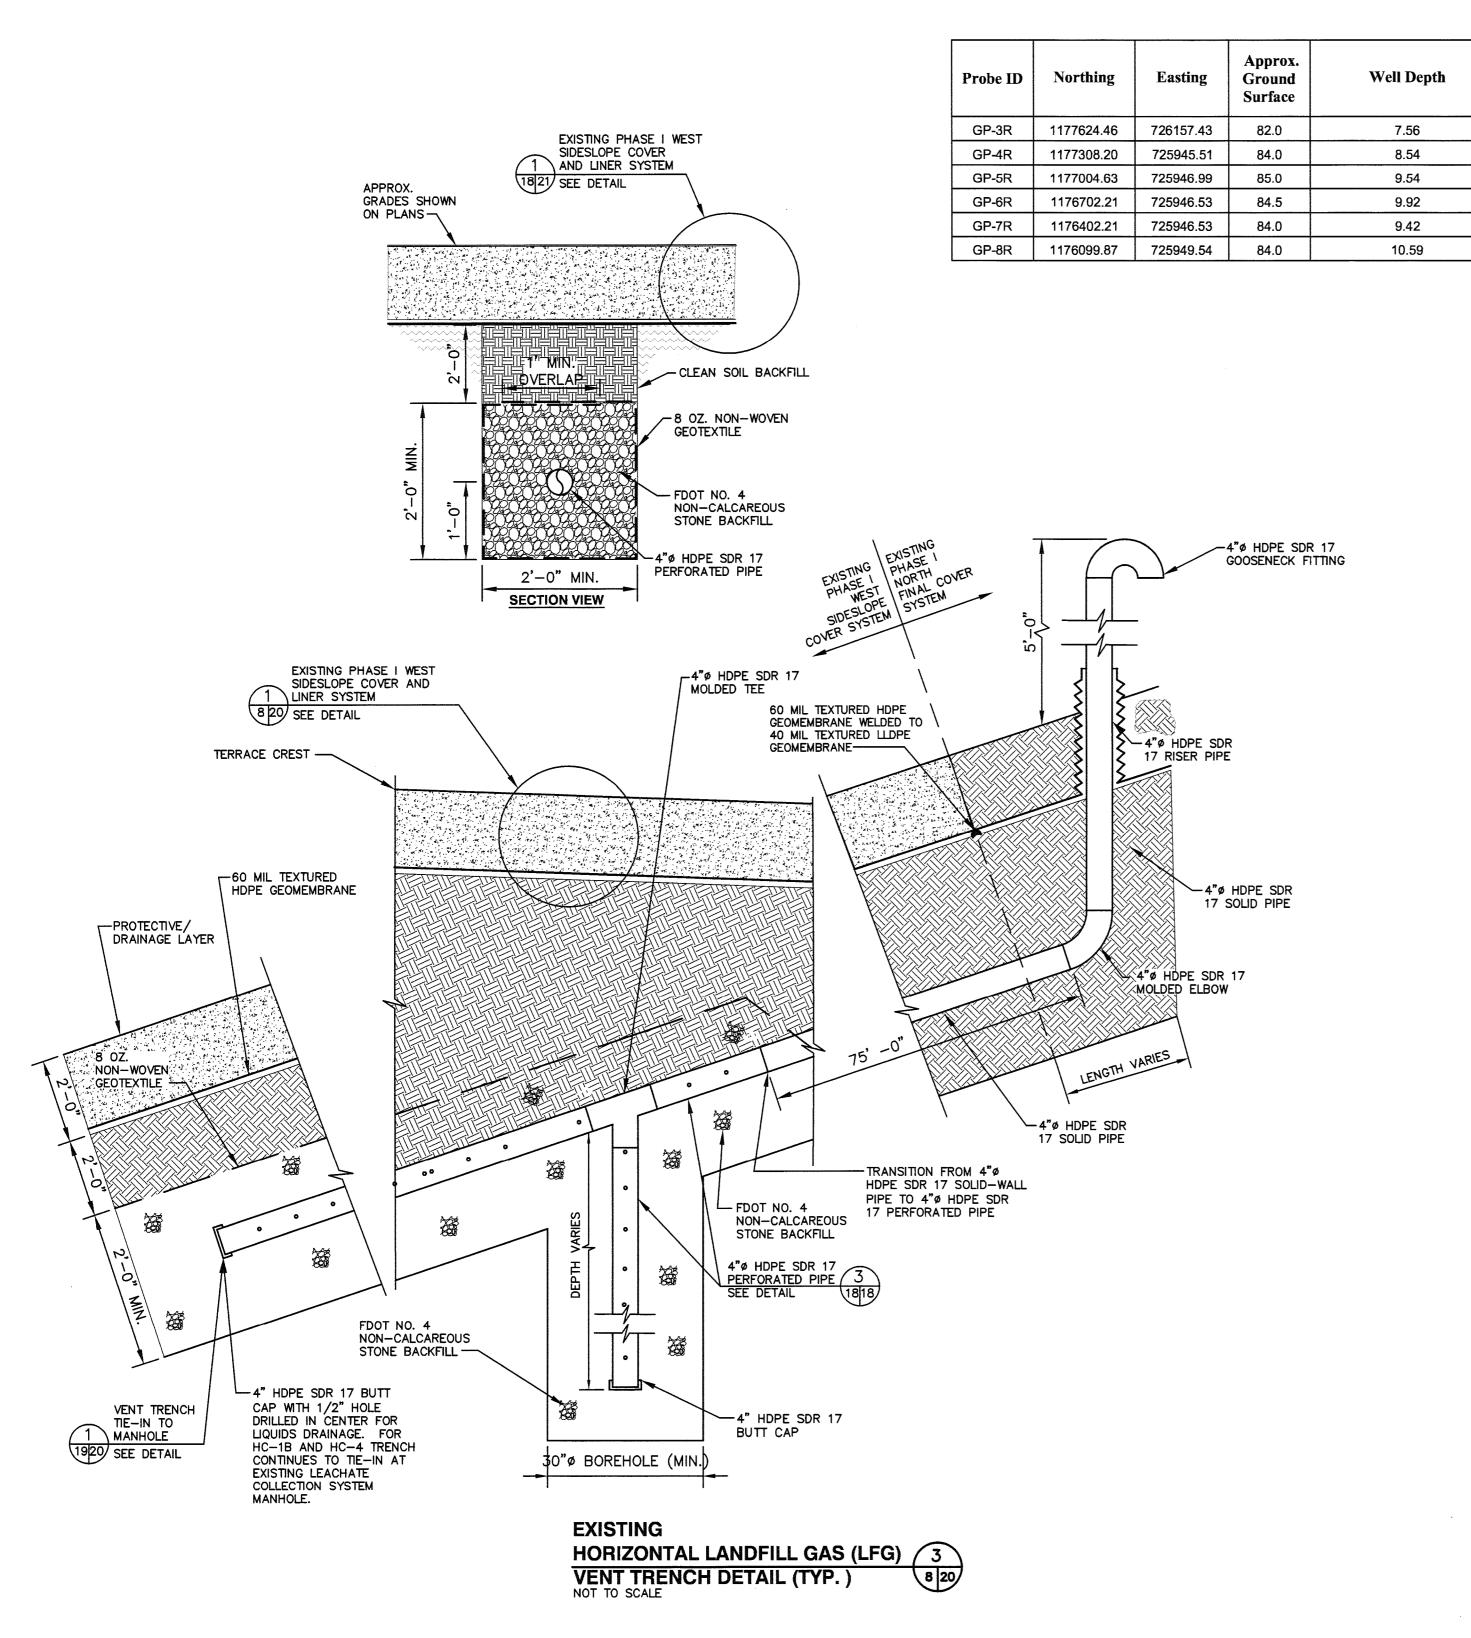

PHASE II SECTION II	GROUND ELEV. (FT NGVD)	TOTAL DEPTH (FT BLS)	SCREEN LENGTH (FT)
MW-13	84.4	17.0	15.0
N 1176331.81			
E 725977.70			
MW-14	85.5	12.0	10.0
N 1176949.27			
E 725978.30			
MW-15	84.0	12.0	10.0
N 1177463.17			
E 725967.78			
TYPICAL MONITO	ORING V	VELL C	ETAI
IOT TO SCALE			

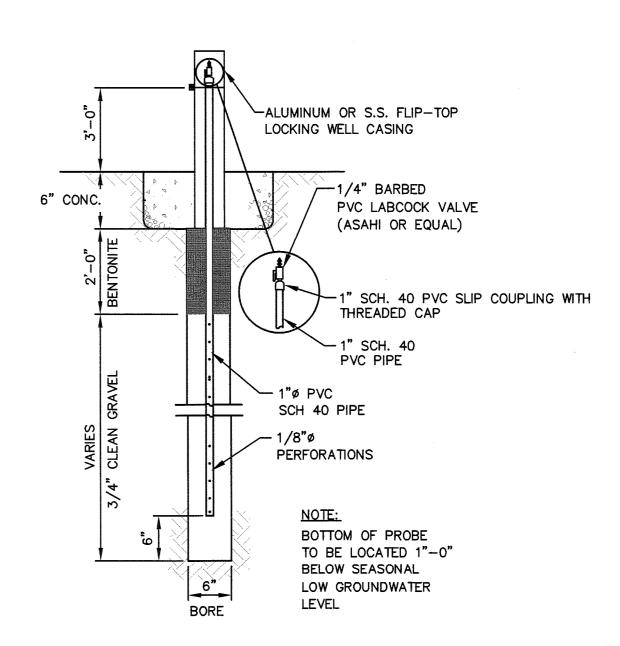

LANDFILL GAS MONITORING PROBE (GP)

**DETAIL** 

NOT TO SCALE

AUG 31 2012

SOUTHWEST DISTRICT
TAMPA

SCS ENGINEERS
CONSULTING ENGINEERS
CONSULTING ENGINEERS

CADD FILE:
993323LFGDETL1

DATE:

HARDEE COUNTY HASE II SECTION I CONSTRUCTION I

HARDEE COUNTY BOARD OF COUNTY COMMISSIONERS

**DETAILS** 

AUGUST 2012 SCALE: AS SHOWN

**20**°

DRAWING NO.

