
PROPOSED EXPANSION OF ENTERPRISE RECYCLING AND DISPOSAL FACILITY CLASS III LANDFILL


ANGELO'S AGGREGATE MATERIALS, LTD.

DATE: MARCH 2004 PROJECT No. 03-255.001

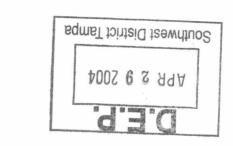



REGIONAL MAP

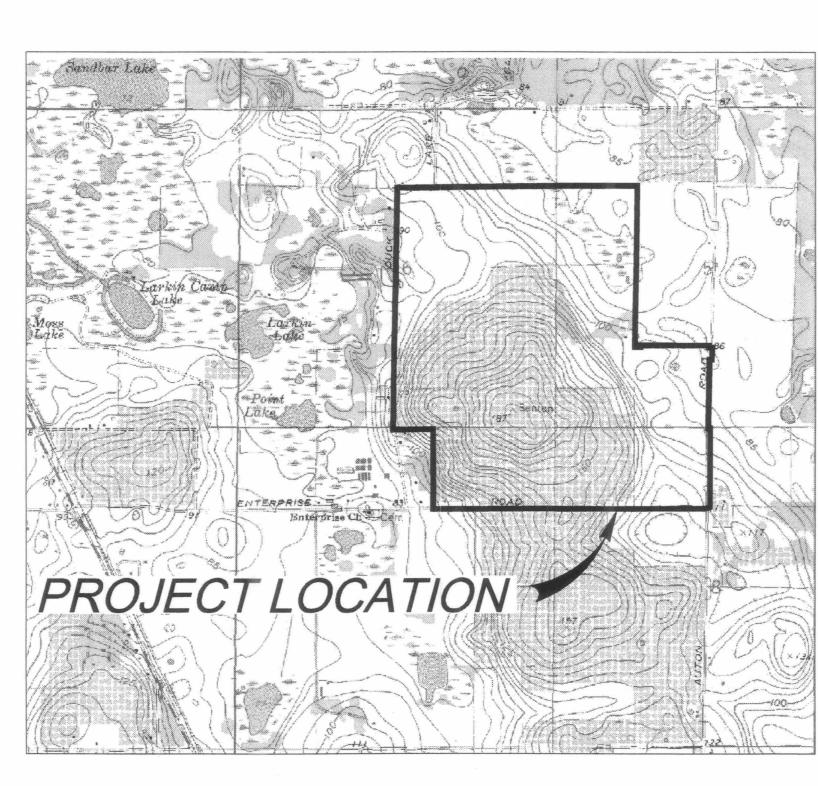

VICINITY MAP

FACILITY LOCATION

ENTERPRISE ROAD DADE CITY, FL

AREA VIEW SECTION 6, TOWNSHIP 25 S, RANGE 22 E

APR 2 6 LOUT SOUTHWEST DISTRICT

ENGINEER



SURVEYOR

SIMMONS & BEALL, INC. P.O. BOX 1297 DADE CITY, FL 33526 PHONE (352) 567-0048

APPLICANT

DOMINIC IAFRATE, PRESIDENT ANGELO'S AGGREGATE MATERIALS, LTD. 1755 20th AVE., S.E. LARGO, FLORIDA 33771 PHONE: (727) 581-1544

SUNSHINE ONE CALL TEL. 1-800 432-4770 CALL 48 HOURS BEFORE DIGGING

DRAWING INDEX							
SHEET No.	DESCRIPTION						
-	TITLE PAGE						
G-1	GENERAL NOTES AND SECTIONS						
9-6	SITE PLAN AND MINE EXCAVATION PLAN						
9-7	PROPOSED FINAL GRADE PLAN						
9-8	CROSS SECTIONS						
9-11	PROPOSED LANDSCAPE PLAN						



Submitted to Pasco County -Countery copy for DEP

DATE 3-12-04

3. Shop drawings of all materials being used shall be submitted to the Engineer for approval prior to installation.

4. All materials and construction to be in accordance with Pasco County's construction specifications, latest edition, unless otherwise waived.

5. It will be the responsibility of the Contractor to ensure that all required permits are obtained and in hand before beginning any construction. No construction or fabrication of any item shall begin until the Contractor has received all plans and any other documentation from all of the permitting and any other regulatory authorities. Any penalties, stop work orders on additional work resulting from the Contractor being in violation of the requirements above shall be fully borne by the Contractor.

6. The location of all existing utilities and storm drainage shown on the plans have been determined from the best information available and are given for the convenience of the Contractor. The Engineer assumes no responsibility for inaccuracy. Prior to the start of any construction activity it shall be the Contractor's responsibility to notify the various utilities and to make the necessary arrangements for any relocation of these utilities with the Owner of the utility. The Contractor shall exercise caution when crossing underground utility, whether shown on the plan or located by the utility company. All utilities which interfere with the proposed construction shall be brought to the attention of the Engineer first. Any fees associated with utility relocations shall be borne by the Contractor. It is requested that utility companies move their particular utilities. Any delay or inconvenience caused to the Contractor by the relocation of the various utilities shall be incidental to the contract and no extra compensation will be allowed.

7. A preconstruction meeting is to be held between the jurisdictional entity Pasco County, utilities, Engineer of Record, and Contractor prior to commencement of construction.

8. The sequence of construction shall be such that all underground installations of every kind, including sprinklers, shall be placed beneath the pavement and its edges prior to the construction of the pavement. The pavement shall not be cut without prior approval of the Engineer.

9. The Contractor shall notify the Engineer at least 48 hours prior to beginning construction and at least 48 hours before requiring inspection on each and every phase of work.

10. All Contractors, County Representatives, and Utility Companies are responsible for their respective surveying and layout from benchmark provided on construction plans. Any survey monumentation disturbed during construction shall be replaced upon completion of the work by a registered land surveyor.

11. The Contractor shall be responsible for preventing any construction activities from taking place outside of the Limits of Construction shown on the plans. Any on—site or off—site areas disturbed shall be restored to original condition or better.

12. The Contractor shall maintain a current set of construction plans and all permits on the job site during all phases of construction. The contractor shall provide two (2) sets (this number should vary depending on the County) of record drawings to the Engineer of Record within two (2) weeks after construction has been completed on each phase.

13. All pipe call outs are measured centerline to centerline for manholes and inlets and from the end of the pipe for mitered end sections.

14. Plans and Specifications require that compacted backfill be placed along side of and over all utilities. The engineer may require that compaction tests be taken to verify backfill compaction. The cost of such compaction tests will be borne by the Contractor.

Utilities will be provided as follows:

Electric will be provided by Florida Power Corporation

Telephone will be provided by Urited Telephone.

Water will be provided by well. Sewage collection will be provided by septic tank and drainfield.

Property currently zoned AC.

EARTHWORK AND SITEWORK

1. The Contractor shall be responsible for obtaining the necessary testing to assure that the proper compaction has been achieved on the subgrade, base, and all other pertinent areas that have been completed. The Contractor shall bear all costs associated with testing and retesting of the areas and shall provide the Owner and the Engineer with copies of the certification of compaction from the testing company.

2. All excess fill from site shall be stockpiled by the Contractor, in a location determined by the Owner or the Owner's representative and the Engineer.

3. Clear areas indicated shall be completely clear of all timber, brush, stumps, roots, grass, weeds, rubbish, and all other debris and obstructions resting on or protruding through the surface of the ground.

4. Prior to bid preparation, the Contractor must become familiar with the overall site conditions and perform additional investigations as determined necessary to understand the limit and depth of expected organic silt peat areas, adequacy of existing materials as fill, and materials to be disposed of offsite, all of which will affect his pricing. Any delay, inconvenience, or expense caused to the Contractor due to inadequate investigation of existing conditions shall be incidental to the contract, and no extra compensation will be allowed. The materials anticipated to be encountered during construction may require drying prior to use as backfill, and the Contractor may have to import materials, at no extra cost, from offsite to meet the requirements for compaction and proper fill.

EROSION CONTROL AND SEDIMENTATION


1. The Contractor must install and maintain grass, seed and mulch, or sod on exposed slopes within 48 hours of completed final grades, as noted on plans, and at any other time as necessary to prevent erosion, sedimentation or turbid discharges to any downstream water body, wetland, or off-site property. Sodding on slopes 3:1 or steeper shall be staked.

2. The Contractor shall be responsible for the project complying with applicable State water quality standards during construction as specified in the permits. All water and wind erosion shall be minimized as defined in the specifications and permits. The specifications provide only a minimum requirement for erosion and sedimentation control, it is the Contractor's responsibility to implement control measures not shown in specifications. All costs associated with turbidity control and sediment stabilization shall be borne by the Contractor.


GENERAL SPECIFICATIONS

EARTHWORK AND SITEWORK


1. Sod shall be of the Bahia grass type, well matted with roots, of sufficient thickness to withstand all necessary handling and reasonably free of weeds and other grasses. Sod shall be freshly cut, healthy and green in appearance, and be in commercial size rectangles, preferably twelve inches (12") by twenty—four (24"), or larger. Sod shall be placed within twenty-four (24) hours of arrival to the job site. Where the sod is placed on slopes 3:1 or steeper the seams shall be staggered or staked.

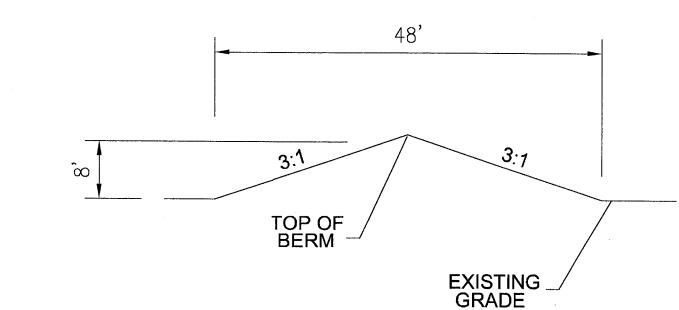



VISUAL BUFFER DETAIL - 8 FT. BERM

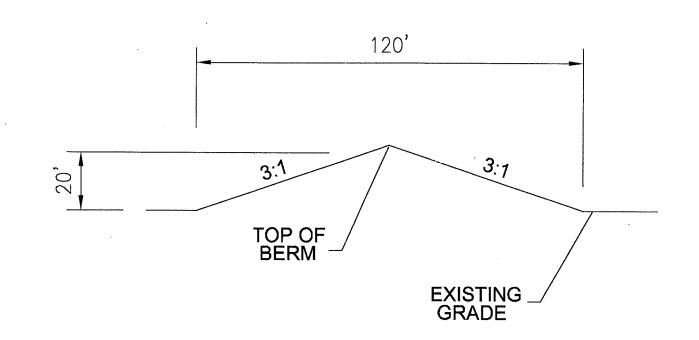

VISUAL BUFFER DETAIL - 20 FT BERM

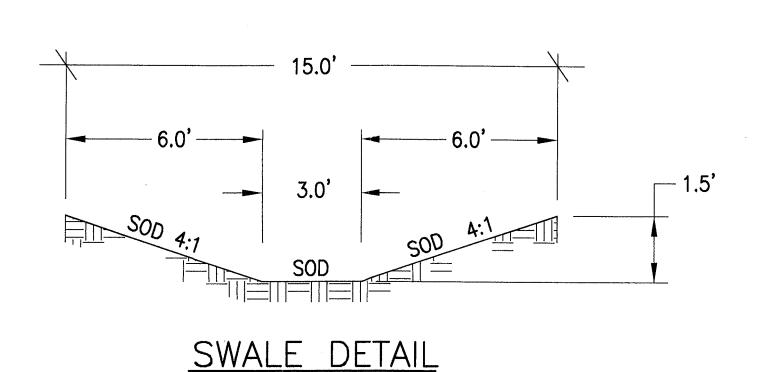

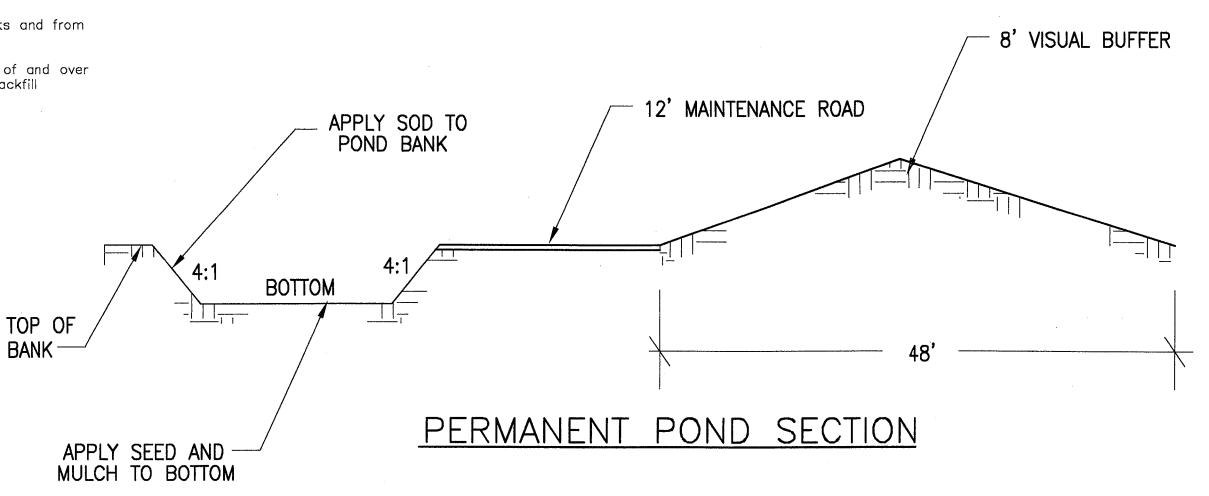

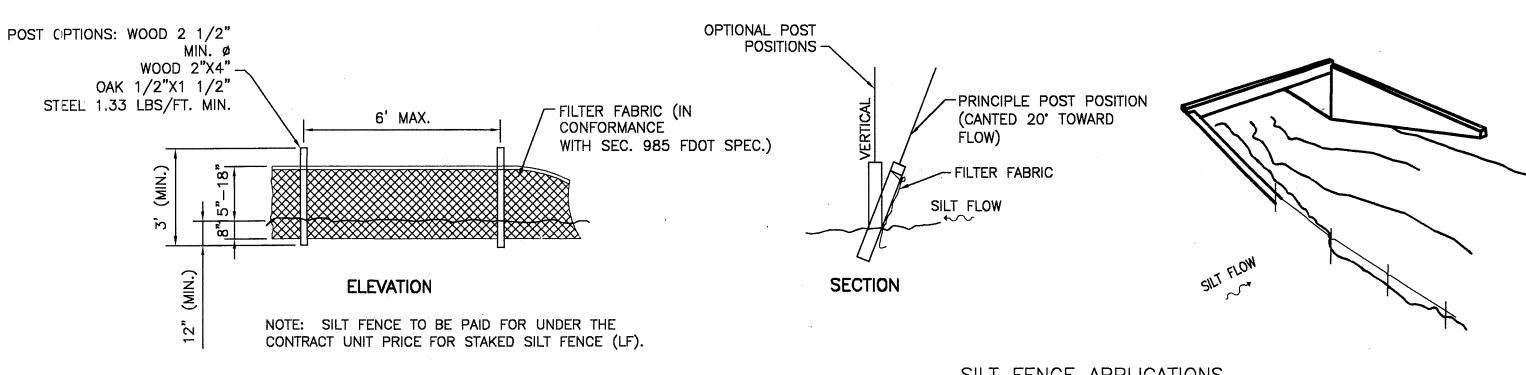

SILT FENCE APPLICATIONS PER FDOT INDEX 102 **DETAIL**

SCALE: NTS

TYPE III SILT FENCE PROTECTION

ACCORDANCE WITH CHART I, SHEET 1 OF 3 AND DITCH INSTALLATIONS AT DRAINAGE STRUCTURES SHEET 2 OF 3.

DO NOT DEPLOY IN A MANNER THAT SILT FENCES WILL ACT AS A DAM ACROSS PERMANENT FLOWING WATERCOURSES. SILT FENCES ARE TO BE USED AT UPLAND LOCATIONS AND TURBIDITY BARRIERS USED AT PERMANENT BODIES OF WATER.

Orlando, Florida

ax: 407 649-6582

VERIFY SCALES **DOCUMENT REUSE** PORATED HEREIN ARE THE PROPERTY OF HSA GOLDEI
AND AFE NOT TO BE USED, IN WHOLE OR IN PART, FOR ANI
OTHER PURPOSE WITHOUT EXPRESS WRITTEN AUTHORIZATION
OF HSA GOLDEN.

PROPOSED EXPANSION OF ENTERPRISE RECYCLING AND DISPOSAL FACILITY **CLASS III LANDFILL**

GENERAL NOTES AND SECTIONS

Engineering Business No. 9915 DESIGNED DESIGNED DESIGNED DESIGNED DESIGNED DRAWN DRD 3-04 N.T.S. CHECKED QG APPROVAL DLL 3-04 G-1				David L. Leggett, P.E.		BY	DATE	PROJECT NO.
DRAWN DRD 3-04 N.I.S. CHECKED JEG 3-04 G-1 QC APPROVAL DLL 3-04				P.E. No. 58667. FE Fnoincering Business No. 9915	DESIGNED	DLL	3-04	03-255.001 SCALE
Devol 2 QC APPROVAL DLL 3-04			87		DRAWN	DRD	3-04	1
3210.20				6 N. J.	CHECKED	JEG	3-04	G-1
DATE REVISIONS REVISED CHECKED DATE 3 - 02 FINE 0.3255001G01.DWG SHEET OF				Davill defill	QC APPROVAL	DLL	3-04	
The following the first of the	DATE	REVISIONS	REVISED CHECKED	DATE 3-//2-04	FIRE: 0325	5001G0	1.DWG	SHEET OF

FLCRIDA DEPARTMENT OF ENVIRONMENTAL PROTECTION

Enterprise Road Dade City, Florida

